NUMBER TITLE		SHEETS	
SA-001	TROLLEY STANDARD	S DRAWING INDEX	5
SPECIAL PARTS AND DESIGNATIONS			
SA-097	SPECIALWORK MATE	RIAL LIST	2
SA-098	MASTER MATERIAL	LIST USAGE REFERENCE	4
SA-099	MASTER MATERIAL	LIST	4
SA-100	SYMBOLS AND ABB	REVIATIONS	3
SA-101	STRAIN PLATE		1
SA-102	STEEL POLE COLLA	R	1
SA-103	WOOD POLE EYEBC	LT ASSEMBLY	1
SA-104	WOOD POLE DOWN	GUY ASSEMBLY	1
SA-106	COMPRESSION POL	E BRACKET POLE COLLAR	1
SA-107	SA-107 STAINLESS STEEL EYEBOLT 1		1
SA-108 BRACKET ARM POLE END CAP		1	
SA-109 BRACKET ARM ARM END CAP		1	
SA-110	-110 BRACKET ARM SPAN END CAP		1
SA-111	1 WOOD POLE MOUNTING BRACKET 1		1
SA-112	SA-112 3 1/2" TUBE SOCKET PLATE 1		
SA-113	SA-113 3 1/2" TUBE TEE SLIPFIT & SOCKET 1		1
SA-114			1
	SPECIAL A	SSEMBLIES AND SYSTEM CRITERIA	
SA-151	SA-151 SPECIALWORK INSULATED JUMPER ASSEMBLY 1		1
SA-152	SA-152 TROLLEY WIRE DEADEND ASSEMBLY 2		2
SA-153 STAGING DEADEND ASSEMBLY		1	
A WOLAK DR: S B FARISSB	CHKD: D GREER SCALE: NONE	METRO TRANSIT DIVISION TROLLEY OVERHEAD SYSTEM STANDARDS	DATE: APRIL 2008 FILE DWG. NO.
	BIS NO: CONTRACT NO: King County	INDEX	SA-001 SHT 1 OF 5

NUMBER	TITLE	SHEETS
SA-161	SPECIALWORK DEVICE REFERENCE POINT LOCATIONS	1
SA-163	SPECIALWORK SWITCH CONTACTOR CONFIGURATION	1
SA-164	TROLLEY WIRE SUPPORT SPAN ATTACHMENT CRITERIA	4
SA-165	FROG INDUCTION CONTROL SYSTEM	6
SA-166	ADJUSTMENT POINT	1
SA-167	INSULATION COVERED GUY WIRE REQUIREMENT CRITERIA	1
SA-170	TROLLEY COACH TRAVEL AREA IN CONSTRUCTION ZONE	1
SA-190	TEMPORARY INSULATION BOARD	1
	SUPPORTING STRUCTURES	
SA-201	STANDARD STEEL POLE	4
SA-202	WOOD POLE FRAMING DETAILS	1
SA-211	OFFSET FOUNDATION (ANCHOR BASE POLE)	7
SA-212	STANDARD FOUNDATION (EMBEDDED STEEL POLE)	4
SA-213	STANDARD FOUNDATION (ANCHOR BASE STEEL POLE)	7
SA-214	WOOD POLE SETTING STANDARD	
SA-215	EMBEDDED STEEL POLE INSTALLATION	3
SA-216	ANCHOR BASE STEEL POLE INSTALLATION	4
SA-221	BUILDING EYEBOLT INSTALLATION	5
SA-231	DOWN GUY	1
SA-232	SIDEWALK GUY	2
SA-233	HEAD GUY	1
SA-234	BRACKET ARM GUY	2
DESIGNED A WOLAK DR: B FARISSB	CHKD: D GREER SCALE: NONE METRO TRANSIT DIVISION TROLLEY OVERHEAD SYSTEM STANDARDS	DATE: APRIL 2008 FILE
RECOM. APPROVED J DAVIS	IBIS NO: CONTRACT NO: King County INDEX	DWG. NO. SA-001 SHT 2 OF 5

NUMBER	TITLE	SHEETS	
TROLLEY WIRE SUPPORT ASSEMBLIES			
SA-300	TANGENT SPAN TWO-WAY TRAFFIC W/ K& M HANGERS		
SA-301	TANGENT SPAN TWO-WAY TRAFFIC	1	
SA-302	HOLDUP TANGENT SPAN TWO-WAY TRAFFIC	1	
SA-303	INVERTED TANGENT SPAN TWO-WAY TRAFFIC	1	
SA-304	HOLDDOWN TANGENT SPAN TWO-WAY TRAFFIC	1	
SA-305	BRIDLE TANGENT SPAN TWO-WAY TRAFFIC	2	
SA-306	DOUBLE BRIDLE TANGENT SPAN TWO-WAY TRAFFIC	2	
SA-307	1° TO 5° CURVE SPAN W/ 2' CURVE RAILS TWO-WAY TRAF	FIC 2	
SA-308	5.5° TO 7.5° CURVE SPAN W/ 4' CURVE RAILS TWO-WAY T	TRAFFIC 2	
SA-309	TANGENT SPAN THREE TRACKS	1	
SA-310	8° TO 30° CURVE SPAN W/ CURVE SEGMENTS TWO-WAY TRAFFIC		
SA-311	TANGENT SPAN ONE-WAY TRAFFIC		
SA-312	HOLDUP TANGENT SPAN ONE—WAY TRAFFIC		
SA-313	INVERTED TANGENT SPAN ONE-WAY TRAFFIC		
SA-314	HOLDDOWN TANGENT SPAN ONE—WAY TRAFFIC		
SA-315	BRIDLE TANGENT SPAN ONE—WAY TRAFFIC		
SA-316	DOUBLE BRIDLE TANGENT SPAN ONE—WAY TRAFFIC	2	
SA-317	1° TO 5° CURVE SPAN W/ 2' CURVE RAILS ONE—WAY TRAF	FFIC 2	
SA-318	5.5° TO 7.5° CURVE SPAN W/ 4' CURVE RAILS ONE-WAY TRAFFIC		
SA-320	8° TO 30° CURVE SPAN W/ CURVE SEGMENT ONE-WAY TRAFFIC		
SA-321	DOUBLE FEEDER SPAN TWO-WAY TRAFFIC	3	
A WOLAK DR:	CHKD: D GREER SCALE: NONE METRO TRANSIT DIVISION TROLLEY OVERHEAD SYSTEM STANDARDS	DATE: APRIL 2008 FILE	
	NONE IBIS NO: CONTRACT NO: King County INDEX	DWG. NO. SA-001 SHT 3 OF 5	

NUMBER	TITLE	SHEETS
SA-322	SINGLE FEEDER SPAN TWO-WAY TRAFFIC	2
SA-325	EQUALIZER SPAN TWO-WAY TRAFFIC	1
SA-331	DOUBLE FEEDER SPAN ONE-WAY TRAFFIC	3
SA-332	SINGLE FEEDER SPAN ONE—WAY TRAFFIC	2
SA-333	SECTIONALIZING SPAN ONE-WAY TRAFFIC	1
SA-334	TROLLEY WIRE SPREADER BAR	1
SA-341	STEEL POLE BRACKET ASSEMBLY TANGENT CONSTRUCTION	2
SA-342	STEEL POLE BRACKET ASSEMBLY CURVE CONSTRUCTION	2
SA-343	STEEL POLE BRACKET ASSEMBLY COMPRESSION TYPE	4
SA-345	STEEL POLE BRACKET ASSEMBLY UNDERSLING CONSTRUCTION	2
SA-348	STEEL POLE HOLDDOWN BRACKET ASSEMBLY	2
SA-349	STEEL POLE TANGENT FEEDER BRACKET ASSEMBLY	3
SA-351	WOOD POLE BRACKET ASSEMBLY TANGENT CONSTRUCTION	2
SA-352	WOOD POLE BRACKET ASSEMBLY CURVE CONSTRUCTION	2
SA-355	WOOD POLE BRACKET ASSEMBLY UNDERSLING CONSTRUCTION	2
SA-358	WOOD POLE HOLDDOWN BRACKET ASSEMBLY TANGENT CONST	2
SA-361	TRAFFIC MAST ARM TROLLEY SUPPORT	1
SA-370	SPAN WIRES LIMITED SPACE TYPICAL VARIANCES	2
SA-371	SWITCH & CURVE SEGMENT PULLOFFS	9
SA-372	CROSSOVER HOLDUP SPAN	2
SA-373	CONVENTIONAL CURVE WITH CURVE RAILS	4
	METRO TRANSIT DIVISION TROLLEY OVERHEAD SYSTEM	APRIL 2008

DESIGNED A WOLAK	CHKD: D GREER
DR:	SCALE:
B FARISSB	NONE
RECOM.	IBIS NO:
APPROVED	CONTRACT NO:
J DAVIS	



METRO TRANSIT DIVISION TROLLEY OVERHEAD SYSTEM STANDARDS

INDEX

DATE:	
APRIL	2008
FILE	

DWG. NO.

SA-001

SHT 4 OF 5

NUMBER	TITLE	SHEETS
	SPECIAL DETAILS	
SA-401	LIGHTNING ARRESTERS AT FEEDER RISER POLES	6
SA-402	FEEDER RISER POLE	3
SA-403	STEEL POLE FEEDER RISER WITH STREETLIGHT	1
SA-411	DUCTBANK CONCRETE ENCASED	2
	PURCHASE REQUIREMENTS	
SP-201	STANDARD STEEL POLE PURCHASE REQUIREMENTS	13
DE0101153		PATE:
DESIGNED A WOLAK DR:	D GREER TROLLEY OVERHEAD SYSTEM	APRIL 2008
B FARISSB RECOM.	NONE	WG. NO.
APPROVED J DAVIS	King County INDEX	SA-001 5 of 5

	SPECIALWORK I	MATERIAL LIST
ITEM #	DESCRIPTION	WABCO CAT. NO.
1	15° WSE, RH, IC, RS	55964-3001
2	15° WSE, LH, IC, RS	55964-3002
3	15° WSE, RH, IC, RC	55964-3005
4	15° WSE, LH, IC, RC	55964-3006
5	15° WSE, RH, IS, RS	55973-3001
6	15° WSE, LH, IS, RS	55973-3002
7	15° WSE, RH, IS, RC	55973-3003
8	15° WSE, LH, IS, RC	55973-3004
9	15° WTR, RH, IC, RC	55979-3001
10	15° WTR, LH, IC, RC	55979-3002
11	15° WTR, RH, IC, RS	55979-3005
12	15° WTR, LH, IC, RS	55979-3006
13	15° WTR, RH, IS, RC	55981-3001
14	15° WTR, LH, IS, RC	55981-3002
15	15° WTR, RH, IS, RS	55981-3003
16	15° WTR, LH, IS, RS	55981-3004
17	30° WSE, RH, IC, RS	56425-3001
18	30° WSE, LH, IC, RS	56425-3002
19	30° WSE, RH, IC, RC	56425-3003
20	30° WSE, LH, IC, RC	56425-3004
21	30° WSE, RH, IS, RS	57143-3001
22	30° WSE, LH, IS, RS	57143-3001
23	30° WSE, RH, IS, RC	57143-3002
24	30° WSE, LH, IS, RC	57143-3004
25	30° WTR, RH, IS, RC	56596-3005
26	30° WTR, LH, IS, RC	56596-3006
27	30° WTR, RH, IS, RS	56596-3007
28	30° WTR, LH, IS, RS	56596-3008
29	30° WTR, RH, IC, RC	56597-3001
30	30° WTR, LH, IC, RC	56597-3002
31	30° WTR, RH, IC, RS	56597-3005
32	30° WTR, LH, IC, RS	56597-3006
33	17° RXO	17872 A OR B
34	27° RXO	17874 A OR B
35	30° RXO	55968-3003
36	37° RXO	17877 A OR B
37	45° RXO	55967-3003
38	50° RXO	57857-3007
39	60° RXO	55966-3001
40	90° RXO	55965-3001
41	30°- 60° XOCS, RH	57123-3001
42	30°- 60° XOCS, LH	57123-3001
43	30°- 45° XOCS, LH	55969-3001
DESIGNED	CHKD:	METRO TRANSIT DIVISIONI DATE:
A WOLAK	D GREER	TROLLEY OVERHEAD SYSTEM APRIL 2000
DR: B FARISSB	SCALE: NONE	STANDARDS
RECOM.	IBIS NO:	DWG. NO.
	King County	SPECIAL WORK SA-097
APPROVED	CONTRACT NO:	MATERIAL LIST
J DAVIS		1 2

SPECIALWORK MATERIAL LIST		
ITEM #	DESCRIPTION	WABCO CAT. NO.
44	58° TO 65° AXO	18438
45	66° TO 90° AXO	18437
46	15° Y, IND, ILH, RST RH	59503-3004
47	23° WSE, RH, IC, RS	55961-3001
48	23° WSE, LH, IC, RS	55961-3002
49	23° WTR, RH, IC, RS	55978-3001
50	23° WTR, LH, IC, RS	55978-3002
51	45° WSE, RH, IC, RS	56593-3001
52	45° WSE, LH, IC, RS	56593-3002
53	45° WSE, RH, IC, RC	56593-3005
54	45° WSE, LH, IC, RC	56593-3006
55	45° WSE, RH, IS, RS	57904-3001
56	45° WSE, LH, IS, RS	57904-3002
57	45° WSE, RH, IS, RC	57904-3005
58	45° WSE, LH, IS, RC	57904-3006
59	45° WTR, RH, IC, RC	56595-3005
60	45° WTR, LH, IC, RC	56595-3006
61	45° WTR, RH, IC, RS	56595-3007
62	45° WTR, LH, IC, RS	56595-3008
63	45° WTR, RH, IS, RC	56592-3005
64	45° WTR, LH, IS, RC	56592-3006
65	45° WTR, RH, IS, RS	56592-3007
66	45° WTR, LH, IS, RS	56592-3008

LEGEND

RH = RIGHT HAND SWITCH

LH = LEFT HAND SWITCH

IC = INSULATION IN CURVE

IS = INSULATION IN STRAIGHT

WSE = ELECTRICALLY OPERATED INDUCTIVE SWITCH

WTR = TRAILING SWITCH

RXO = RIGID CROSSOVER

RC = RESET TO CURVE

RS = RESET TO STRAIGHT

XOCS = CROSSOVER CURVE SEGMENT

Y = Y SWITCH

IND = ELECTRICALLY OPERATED INDUCTIVE SWITCH

ILH = INSULATION IN LH OF Y

RST RH = RESET TO RH OF Y

AXO = ADJUSTABLE CROSSOVER

DESIGNED A WOLAK	CHKD: D GREER	
DR:	SCALE:	
B FARISSB	NONE	
RECOM.	IBIS NO:	2
APPROVED J DAVIS	CONTRACT NO:	



METRO TRANSIT DIVISION TROLLEY OVERHEAD SYSTEM STANDARDS

SPECIAL WORK
MATERIAL LIST

DATE:
APRIL 2008
FILE
DWG. NO.
DWG. NO.
SA-097
SHT 2 OF 2

	MASTER MATERIAL LIST		
ITEM #	METRO STANDARD SA— WHICH USES THE ITEM		
01	153,165,190,300,301,302,303,304,305,306,307,309,311,312,313,314,315,		
	316,317,321,322,325,331,332,334,345,348,355,358		
02	190,301,302,305,306,309,311,312,315,316,355,345		
03	152,166,167,233,300,301,302,303,304,305,306,307,308,309,310,311,312,		
	313,314,315,316,317,318,320,321,322,325,331,332,342,343,345,348,352,		
	370,371,372,373,355,358		
04	152,233,300,301,302,303,304,305,306,307,308,309,310,311,312,313,314,		
	315,316,317,318,320,321,322,325,331,332,342,343,345,348,352,370,371,		
	372,373,355,358		
05	152,166,233,300,301,302,303,304,305,306,307,308,309,310,311,312,313,		
	314,315,316,317,318,320,321,322,325,331,332,342,343,345,348,352,370,		
	371,372,373,355,358		
06	152,166,233,300,301,302,303,304,305,306,307,308,309,310,311,312,313,		
	314,315,316,317,318,320,321,322,325,331,332,342,343,345,348,352,370,		
0.7	371,372,373,355,358		
07	152,233,300,301,302,303,304,305,306,307,308,309,310,311,312,313,314,		
	315,316,317,318,320,321,322,325,331,332,342,343,345,348,352,370,371, 372,373,355,358		
08	152,166,167,233,300,301,302,303,304,305,306,307,308,309,310,311,312,		
00	313,314,315,316,317,318,320,321,322,325,331,332,342,343,345,348,352,		
	370,371,372,373,355,358		
09	152,305,306,310,315,316,331,371,372		
10	153,303,304,307,308,313,314,317,318,334,342,345,348,352,370,373,358		
11	152,310,342,343,345,348,352,371,372,355,358		
12	310,320,322,325,332,342,343,345,352,370,371,373		
13	152,166,167,231,232,233,305,306,315,316,371,373		
14	152,153,231,232,233,305,306,315,316,371,373		
15	166,233,305,306,315,316,341,342,345,348,349,351,352,371,373,355,358		
16	152,166,167,231,232,233,305,306,315,316,371,373		
17	152,153,233,234,305,306,315,316,341,342,345,348,349,351,352,371,373,355,358		
18	167,310,372		
19	167		
20	343		
21	321,322,331,332		
22	321,322,325,331,332		
23	153,321,331		
24 25	361		
26	310,320,342,352 321,322,331,332		
27			
28	341,348,349,351,361,358		
29			
30			
DESIGNED	CHKD: METRO TRANSIT DIVISION DATE:		
A WO	ARIL 2008 SCALE: APRIL 2008 FILE		

DESIGNED A WOLAK	CHKD: D GREER
DR:	SCALE:
B FARISSB	NONE
RECOM.	IBIS NO:
APPROVED	CONTRACT NO:
J DAVIS	



STANDARDS

MASTER MATERIAL LIST USAGE REFERENCE

date: APRIL	2008
FILE	
DWG. NO.	
SA-	098
SHT	OF .

	MASTER MATERIAL LIST										
ITEM	#	METRO STANDARD SA— WHICH USES THE ITEM									
31		341,349,351,361									
32	_	325									
33	_	325									
34		152,153									
35		163,165									
36		361									
37		333									
38		152									
39	_	152,308,348,358									
40	-	321,331,342,345,352									
41	_	321,322,325,331,332,349									
42		349									
43		*									
44		WFSC ONLY									
45	\rightarrow	WFSC ONLY									
46		WFSC ONLY									
47	_	WFSC ONLY *									
48	_										
49 50		349 349									
51	\rightarrow	349									
52		349									
53	\rightarrow	307,317,342,352,373									
54	_	308,318,342,352,373									
55	-	234,341,342,345,348,349,351,352,355,358									
56	_	234,341,342,345,348,349,351,352,355,358									
57	_	341,342,345,348,349,351,352,358									
58	_	300,345									
59		402									
60	_	321,322,331,332,349,402									
61		231,232									
62		231									
63		232									
64		232									
65		232,351									
66		232									
67	\rightarrow	401									
68		402									
69	\rightarrow	402									
70	_	321,331,372									
71	-	402									
72	\rightarrow	165									
73 DESIGN		WFSC ONLY CHKD: METRO TRANSIT DIVISIONI DATE:									
A W		AK D GREER TROLLEY OVERHEAD SYSTEM APRIL 2008									
DR:		SCALE: STANDARDS FILE									
B F RECOM.		ISSB NONE IBIS NO: NAACTED MATERIAL LICT									
0 0 , • 1 .		IBIS NO: MASTER MATERIAL LIST CO. O.O.									

King County

CONTRACT NO:

APPROVED

J DAVIS

MASTER MATERIAL LIST USAGE REFERENCE

	MASTER MATERIAL LIST							
ITEM	# METRO STANDARD SA- WHICH USES THE ITEM							
74	190							
75	190							
76	325							
77	401,411							
78	401							
79	341,349,351							
80	321,331,341,343,349,351,361,401							
81	401							
82	232							
83	401							
84	343,361							
85	401							
86	402							
87	361							
88	361							
89	361							
90	234,341,342,345,348,349,351,352,355,358							
91	401							
92	373							
93	401							
94	103,351,352,355,358							
95 96	103,351,352,355,358							
97	104,351,352,355,358							
98	104							
99	103,104,351,352							
100	321,331							
101	152,321,331							
102	152,164,233,234,300,301,302,303,304,305,306,307,308,309,310,311,312,							
	313,314,315,316,317,318,320,321,322,325,331,332,341,342,343,345,348,							
	349,371,372,373,355,358							
103	152,164,233,234,300,301,302,303,304,305,306,307,308,309,310,311,312,							
	313,314,315,316,317,318,320,321,322,325,331,332,371,372,373							
104	231,232							
105	*							
106	343							
107	,							
108								
109								
110								
111	351,352,355,358							
112								
113 DESIGN	0.175							
	ED CHKD: OLAK D GREER TROLLEY OVERHEAD SYSTEM OUTPUT TOUR TROLLEY OVERHEAD SYSTEM							
DR:	SCALE: STANDARDS FILE							
B F RECOM	ARISSB NONE IBIS NO: MACTED MATERIAL LICT							
	King County MASTER MATERIAL LIST SA-098							
APPRO'	CONTRACT NO: USAGE REFERENCE							
LUL	AVIS 33.4							

				MASTER MA	TERIAL LI	ST				
ITEM #			METRO	STANDARD	SA-	WHICH	USES	THE	ITEM	
114										
	401									
116	349,4	01								
	401									
	401									
	401									
	401									
	401									
		ONLY								
		ONLY								
124	WI 30	ONLI								
DESIGNED		CHKD:			METD	O TRA	NICIT I) \ /IC	.IUVI	DATE:
A WOL	.AK	D GREER			IVI E I R TROLI	_ey ove	inoli l Erhead	SYS SYS	TEM	APRIL 2008
DR: B FAR		scale: NONE	a	f		STAN	IDARDS			FILE DWG NO

King County

RECOM.

APPROVED

J DAVIS

IBIS NO:

CONTRACT NO:

MASTER MATERIAL LIST USAGE REFERENCE

DATE:	
APRIL 2008	
FILE	
	_
DWG. NO.	
SA-098	
SHT OF .	

ITEM # QTY DESCRIPTION MANUFACTURE 01 DETROIT CLAMP ASSY WABCO 02 AGC TANGENT SPAN HANGER WABCO 03 GUY STRAIN INSUL PORCELAIN PRODUCTS OF PREFORMED 04 GUY GRIP DEADEND PREFORMED	19293-3007 19360-2000 504 CO. CDE-3106 G450
02 AGC TANGENT SPAN HANGER WABCO 03 GUY STRAIN INSUL PRODUCTS (19360-2000 504 CO. CDE-3106 G450 G414 8M
03 GUY STRAIN INSUL PORCELAIN PRODUCTS (504 CO. CDE-3106 G450 G414 0 8M
PRODUCTS (CO. CDE-3106 G450 G414 BM
	CDE-3106 G450 G414 8M
OA CHY CRIP DEADEND PREFORMED	G450 G414 8M
	G414 8M
05 WIRE ROPE CLIP, 5/16" CROSBY) 8M
06 FRICTION TAPE, 3/4" (6 WRAPS)) 8M
07 THIMBLE, 3/8" XHD, OPEN CROSBY	
08 GUY STRAND COPPERWELE	19567 2000
09 BULL RING WABCO	16367-2000
10 HI-LITE DOUBLE CURVE HANGER WABCO	54962-3001
11 7/8 TRANSLITE STRAIN INSUL CL-CL WABCO	54975-6120
12 7/8 TRANSLITE STRAIN INSUL CL—EYE WABCO	55339-6120
13 GUY STRAIN INSUL PORCELAIN	506
PRODUCTS (O.
14 GUY GRIP DEADEND PREFORMED	CDE-3115
15 WIRE ROPE CLIP, 3/8" CROSBY	G450
16 GUY STRAND COPPERWELD	16M
17 THIMBLE, 1/2" XHD, OPEN CROSBY	G414
18 GUY STRAND, COVERED COPPERWELD) 8MI
19 GUY STRAND, COVERED COPPERWELL	16MI
20 EYEBOLT WABCO	11933-2000
21 7/8 TRANSLITE STRAIN INSUL CL-CL WABCO	54975-6360
22 CLAMP STRAIN EYE WABCO	10571-2000
23 7/8 TRANSLITE STRAIN INSUL CL-CL WABCO	54975-6260
24 TROLLEY WIRE SUPPORT ASSY WABCO	54962-3003
25 CURVE SEGMENT 8-12 DEG TYPE C WABCO	22301-3014
CURVE SEGMENT 13-27 DEG TYPE C WABCO	22302-3005
CURVE SEGMENT 28-47 DEG TYPE C WABCO	22303-3005
26 TYPE PH-4 POS FEED SPAN HANGER WABCO	54937-3002
27 TYPE PH-5 NEG FEED SPAN HANGER WABCO	54936-3002
28 INSULATOR SPOOL WABCO	16835-2000
29 TYPE TCL CLEVIS TIP 4/0 WABCO	54950-3002
30 TROLLEY SUPPORT-LARGE PIPE ARMS WABCO	54940-4001
31 SPRING DETROIT CLAMP WABCO	54959-3001
32 TYPE PH-5 NEG FEED SPAN HANGER WABCO	54936-3001
33 TYPE PH-4 POS FEED SPAN HANGER WABCO	54937-3001
34 TYPE T DOUBLE EAR STRAIN CLAMP WABCO	17700-2000
35 CLAMP-INSUL LEAD WIRE WABCO	19655-2000
36 7/8 TRANSLITE STRAIN INSUL WABCO	54980-6385
W/ ADJUST END FITTINGS	
37 NO-BO SECTION INSUL WABCO	55025-3001
38 7/8 TRANSLITE STRAIN INSUL CL-CL WABCO	54975-6200
DESIGNED CHKD: A WOLAK D GREER METRO TRANSIT DIVISION TROLLEY OVERHEAD SYSTEM	DATE: APRIL 2008

DESIGNED
A WOLAK
D GREER

DR:
B FARISSB
NONE

RECOM.

APPROVED
J DAVIS

CHKD:
D GREER
NONE
SCALE:
NONE
CONTRACT NO:



METRO TRANSIT DIVISION TROLLEY OVERHEAD SYSTEM STANDARDS

> MASTER MATERIAL LIST

APRIL 2008

DWG. NO.

SA-099

ITEM #	QTY	DESCRIPTION	MANUFACTURER	CAT. NO.
39		5/8" SHACKLE	WABCO	13722-2000
40		7/8 TRANSLITE STRAIN INSUL CL-90	WABCO	54995-6120
41		H.S.P. FEEDER CLAMP ASSY, BRONZE	WABCO	19879-2000
42		FEEDER CLAMP, BRONZE	WABCO	19790-4004
43		·		
44		RUNNER, 6 FT TYPE C, 8 TO 12 DEG	WABCO	21375-2000
45		PLATE-STRAIN 5 TO 12 DEG	WABCO	20290-2000
46		SINGLE CURVE HANGER, TYPE A-2	WABCO	14072-2000
47		DOUBLE CURVE HANGER, TYPE A-2	WABCO	14073-2000
48		, , , , , , , , , , , , , , , , , , , ,		
49		COMPRESSION CONNECTOR COPPER, LONG	ANDERSON/	VHCL-
		BARREL, TIN PLATED, FLARED	SQUARE D	2/0-12BNF
50		COMPRESSION CONNECTOR COPPER, LONG	ANDERSON/	VHCL-
		BARREL, TIN PLATED, FLARED	SQUARE D	500-12BNF
51		MULTI-LOK TIES (18") NYLON COATED	BAND-IT	AE714
52		TUF NEOPRENE AIR HOSE SLEEVE	McMASTER-	3 BRAID
		1.5" ID x 2.0625" OD (BLACK)	CARR	2
53		CURVE RAIL (1° TO 5°, 2' LG)	K & M	851 B412/0
54		CURVE RAIL (5.5° TO 7.5°, 4' LG)	K & M	851 B412/1
55		PHILLYSTRAN (3/8")	PHILLYSTRAN	HPTG 6700I
		(2, 2, 7)	INC	
56		PHILLYSTRAN BIG GRIP	PHILLYSTRAN	PLP 2755
			INC	EVEDEN
57		FIBERGLASS REINFORCED PLASTIC	STRONGWELL	EXTREN
		(FRP) TUBE 5" DIA x 1/4"	14 0 14	SERIES 525
58		TANGENT SPAN HANGER	K & M	C-1728-01
59		CONDUIT CLAMP WITH 2" MTG SCREW		
60		FEED SPAN CABLE, 500 KNM CU		
		UNSHIELDED, 5KV EPR WITH PVC JACKET	2255221152	55.55
61		GUY GUARD, 8 FT FOR USE ON 3/16" TO 1/2" STRAND	PREFORMED	PG 5518
62		POWER INSTALLED SCREW ANCHOR	CHANCE	E102-1219
63		POWER INSTALLED SCREW ANCHOR	CHANCE	C102-1260
64		POLE PLATE, 2 1/2" PIPE	JOSLYN	J0521
65		LAG SCREW, FETTER DRIVE, 1/2" x 4"	JOSLYN	J8754
66		END FITTING, 2 1/2" PIPE	COOPER	DG5G1
		, _ , _ , _	POWER SYSTEM	
67		CLOVERLEAF EPOXIROD STANDOFF	CHANCE	C653-1038
68		UNIVERSAL SERVICE CONNECTOR	BURNDY	KVSU34
69		SEALING BUSHING, TYPE KR WITH TYPE	O-Z-GEDNEY	KR250 &
-		M CABLE SUPPORT, 2 1/2" CONDUIT		RPLG-2001-
70		EYEBOLT, 5/8" x 6"		23 2001
, ,		WITH 2 NUTS & LOCKWASHER		

DESIGNED
A WOLAK
D GREER
DR:
B FARISSB NONE
RECOM.

APPROVED
J DAVIS

CHKD:
D GREER
NONE
SCALE:
NONE
CONTRACT NO:
D GREER
CHKD:
D GREER
CONTRACT
CON



METRO TRANSIT DIVISION TROLLEY OVERHEAD SYSTEM STANDARDS

> MASTER MATERIAL LIST

APRIL 2008

DWG. NO.

SA-099

MASTER MATERIAL LIST						
ITEM #	QTY	DESCRIPTION	MANUFACTURER	CAT. NO.		
71		WATERTIGHT STR STRAIN RELIEF	O-Z-GEDNEY	SR 15012		
		CONN, 1 1/2" CONDUIT		H.D. GALV		
72		INDUCTIVE CONTROL SYSTEM RECEIVER	UNITRAC	320100-16X		
		INDUCTIVE CONTROL SYSTEM ANTENNA	UNITRAC	320310-4X		
73		ANCHOR SHACKLE	JOSLYN	J2742		
74		4' x 8' x 1/2" EXTERIOR PLYWOOD				
75		U-BOLT TO FIT 4/0 TROLLEY WIRE				
76		4/0 STRANDED INSUL CABLE				
77		ELECT WARNING TAPE, 6" YELLOW	BRADY	UT 20-Y6		
78		CONNECTOR, PARALLEL CLAMP	BURNDY	QPX342C		
79		5/8"-11 UNC x 3/8" STUD				
80		3/4" x 0.03" SS BANDING TYPE 201	BAND-IT	C206		
81		CONNECTOR, SERVICE, SPLIT BOLT	BURNDY	KS20		
82		2 1/2" DIA ASTM A53 GRB STD WT				
		GALV STEEL PIPE				
83		MOLDING, PLASTIC, GROUND WIRE,	JOSLYN	PM128		
		1/2" X 1/16" X 8'				
84		SCHED 40 PVC, GREY, SPLIT				
85		1000 VOLT DC ARRESTER, 907 MCOV	IMPULSE	P/N 1057		
86		GALV RIGID STEEL CONDUIT				
87		5/8"-11 UNC x 6" THREADED ROD,	5/8"-11 UNC :	6" THREADED F		
		GALV ASTM A36	GALV ASTM A36			
88		5/8"-11 UNC HVY HEX JAM NUT				
		GALV ASTM A563 GRA				
89		11/16" LOCKWASHER				
90		HEAVY PIPE CLAMP, GALV	GRINNELL	FIG 216		
91		STAPLES, ROLLED POINT, GALV,	JOSLYN	J156		
		2" x 1/2" x 0.162"				
92		ANGLE CLAMP, DUCTILE IRON	ANDERSON/	82860-2000		
			SQUARE D			
93		STAPLES, ROLLED POINT, GALV,	JOSLYN	J1673		
		1 3/4" x 1/4" x 0.148"				
94		1 3/4" x 1/4" x 0.148" 5/8" OVAL EYEBOLT WITH NUT	JOSLYN	J94XX		
95		3/4" OVAL EYEBOLT WITH NUT	JOSLYN	J95XX		
96		SQ CURVED WASHER 3" x 3" x 1/4",	JOSLYN	J113		
		11/16" DIA				
97		3/4" MACHINE BOLT	JOSLYN	J89XX		
98		GUY HOOK, 3/4"	STANLEY	P133AX		
			FLAGG	1 100///		
99		SQ CURVED WASHER 3" x 3" x 1/4",	JOSLYN	J6823		
		13/16" DIA		00020		
100		EPPOXIROD DEADEND ARM	CHANCE	COEH36DP		
101		STRAIN PLATE	METRO STD	SA-101		
DESIGNED	СНК	D: METRO TRAN	_	DATE:		
A WOL	AK D	GREER TROLLEY OVER		APRIL 2008		
DR: B FARI	SCAL	E: None Stand		FILE		
RECOM.	IBIS	NO.	TCO	DWG. NO.		
		King County		SA-099		
APPROVED		TRACT NO: MATERIA	AL LIST	SHT OF		
J DAVI	3			3 4		

ITEM #	QTY	DESCRIPTION	MANUFACTURER	CAT. NO.
102		FORGED THREE-PIECE ADJUSTABLE	KORTICK	ITEM 1, 2, 3
		POLE BAND, ANNEALED & GALVANIZED	MFG CO	4, 5, 8, 9
103		WOOD POLE EYEBOLT	METRO STD	SA-103
104		WOOD POLE DOWN GUY ASSEMBLY	METRO STD	SA-104
105				
106		COMPRESSION POLE BRACKET COLLAR	METRO STD	SA-106
107		STAINLESS STEEL EYEBOLT	METRO STD	SA-107
108		MAST ARM POLE END CAP	METRO STD	SA-108
109		MAST ARM ARM END CAP	METRO STD	SA-109
110		MAST ARM UNDERSLING END CAP	METRO STD	SA-110
111		WOOD POLE MOUNTING BRACKET	METRO STD	SA-111
112		3 1/2" TUBE SOCKET PLATE	METRO STD	SA-112
113		3 1/2" TUBE TEE SLIPFIT & SOCKET	METRO STD	SA-113
114		MAST ARM POLE END CAP WITH BOT TAB	METRO STD	SA-114
115		STAINLESS STEEL BOLT WITH WASHERS		
		& LOCK WASHERS		
116		WIRE, 2 OR 5KV, #4 AWG CU,		
		JACKETED, UNSHIELDED		
117		WIRE, #6 AWG CU, SOLID, SOFT,		
		0.031" POLYETHYLENE INSULATED		
118		GROUND ROD CLAMP	COPPERWELD	ABH58
119		CONDUCTIVE & ANTI-SEIZE COMPOUND	THOMAS &	CP-8 OR
		(KOPR-SHIELD)	BETTS	CP-16
120		GROUND ROD, 5/8" x 10'	COPPERWELD	GR5810
		, ,	OR JOSLYN	J8340
121		LAG SCREW, FETTER DRIVE, 5/8" x 5"	JOSLYN	J8765
122		7/8 TRANSLITE STRAIN INSUL CL-TB	WABCO	54982-3001
123		FEEDER, TYPE E, DEAD END	WABCO	21590-2000
124		CLAMP ASSEMBLY	WABCO	54936-3006

DESIGNED
A WOLAK
D GREER
DR:
B FARISSB NONE
RECOM.

APPROVED
J DAVIS

CHKD:
D GREER
NONE
SCALE:
NONE
CONTRACT NO:



METRO TRANSIT DIVISION TROLLEY OVERHEAD SYSTEM STANDARDS

> MASTER MATERIAL LIST

DATE: APRIL 2008 FILE

DWG. NO.

SA-099

standard #	SYMBOLS	DESCRIPTION
	\bigcirc	EXISTING WOOD POLE
SA-202 & SA-214		INSTALL WOOD POLE
		REMOVE WOOD POLE
		EXISTING DIRECT EMBEDMENT STEEL POLE
SA-201,SA-212 & SA-2	15	INSTALL DIRECT EMBEDMENT STEEL POLE
		REMOVE DIRECT EMBEDMENT STEEL POLE
		EXISTING ANCHOR BASE STEEL POLE
SA-201,SA-213 & SA-2	16	INSTALL ANCHOR BASE STEEL POLE
		REMOVE ANCHOR BASE STEEL POLE
	—	EXISTING BUILDING EYEBOLT
SA-107 & SA-221	-	INSTALL NEW BUILDING EYEBOLT
		EXISTING DOWN GUY ON POLE
SA-231	\subset	INSTALL DOWN GUY ON POLE
	•	EXISTING SIDEWALK GUY ON POLE
SA-232	•	INSTALL SIDEWALK GUY ON POLE
	$\bigcirc\bigcirc$	EXISTING HEAD GUY, POLE TO POLE
SA-233	\bigcirc	INSTALL HEAD GUY, POLE TO POLE
		EXISTING POLE BRACKET
SA-351 & SA-352		INSTALL WOOD POLE BRACKET
SA-341 & SA-342		INSTALL STEEL POLE BRACKET
		TRAFFIC SIGNAL MAST ARM

	GNED WOLAK	CHK	d: GREEF	>	
DR:	WOLAN	SCAL		\	
В	FARISSB		NONE		
REC	DM.	IBIS	NO:		
					ı
APPF	ROVED	CON.	TRACT NO):	
J	DAVIS				



METRO TRANSIT DIVISION TROLLEY OVERHEAD SYSTEM STANDARDS

SYMBOLS AND ABBREVIATIONS

DATE	:			
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FILE				
DWG.	NO.			
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SHT	1	С	F	3

SYMBOLS DESCRIPTION

\otimes	PORCELAIN STRAIN INSULATOR				
∠ ⊗	ADJUSTMENT POINT (AT INSULATOR)				
	TROLLEY WIRE, — — NEGATIVE (DOUBLE LINE) — POSITIVE				
	TROLLEY WIRES, NEGATIVE AND POSITIVE (SINGLE LINE)				
2.0%	STREET GRADE (DOWNHILL SLOPE)				
SA#	TROLLEY STANDARD DRAWING NUMBER				
0	BULLRING				
○◀	INDUCTIVE CONTROL ENCLOSURE ON POLE				
	INDUCTIVE CONTROL ENCLOSURE ON WALL				

DESIGNED	CHKD:		
A WOLAK	D GREER		
DR:	scale:		
B FARISSB	NONE		
RECOM.	IBIS NO:		
APPROVED .I DAVIS	CONTRACT NO:		



METRO TRANSIT DIVISION TROLLEY OVERHEAD SYSTEM STANDARDS

> SYMBOLS AND ABBREVIATIONS

DATE:
APRIL 2008
FILE
DWG. NO.
SA-100
SHT 2 OF 3

ABBREVIATIONS

BEB BUILDING EYEBOLT

CS CURVE SEGMENT

DCH DOUBLE CURVE HANGER

LHI LEFT HAND INDUCTIVE SWITCH

RHI RIGHT HAND INDUCTIVE SWITCH

LHD LEFT HAND DIRECTIONAL SWITCH

RHD RIGHT HAND DIRECTIONAL SWITCH

LHT LEFT HAND TRAILING SWITCH

RHT RIGHT HAND TRAILING SWITCH

RXO RIGID CROSSOVER

XOCS RIGID CROSSOVER AND CURVE SEGMENT ASSEMBLY

PRESENTED IN

VARIOUS JOINT USE POLE COMBINATIONS

1\ IS

IS INSULATION IN THE STRAIGHT

IC INSULATION IN THE CURVE

RS RESET TO STRAIGHT

C SEATTLE CITY LIGHT

L LUMINAIRE, SED

M METRO

S TRAFFIC SIGNAL, SED

T TELEPHONE

V CABLE TV


8M,

16M COPPERWELD GUY WIRE

8MI,

16MI COPPERWELD GUY WIRE, COVERED

\triangle	REVISED AS CO	NSTRUCTED		CMS	DPG	06/05	
No.		REVISION					
DESIGNED CHKD: A WOLAK D GREER			METRO TRANSIT DIVISIOI TROLLEY OVERHEAD SYSTEM		DATE:	RIL 2008	
DR: R FARISS	FARISSB NONE M. IBIS NO:		STANDARDS	'1	FILE		
RECOM.			SYMBOLS AND		DWG.	NO.	
APPROVED	CONTRACT NO.	King County			_ SA	<u> </u>	
J DAVIS	CONTRACT NO:		ABBILLVIATIONS		SHT	3 OF 3	

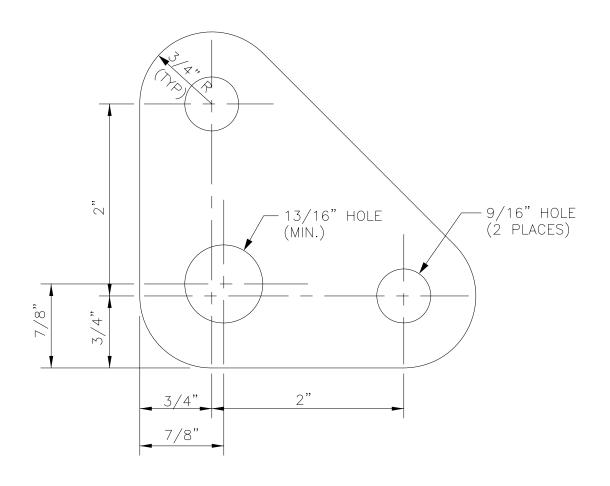

MATERIAL: ASTM A36 1/2" STEEL PLATE HOT DIP GALVANIZE AFTER FABRICATION.

NOTE: USED ON DOUBLE FEEDER SPANS AND DEADENDS.

DESIGNED A WOLAK	CHKD: D GREER	
DR: B FARISSB	scale: NONE	
RECOM.	IBIS NO:	
APPROVED J DAVIS	CONTRACT NO:	




METRO TRANSIT DIVISION TROLLEY OVERHEAD SYSTEM STANDARDS

STRAIN PLATE

DATE:	
APRIL	2008
FILE	
DWG. NO.	
	1 0 1

SA-101 SHT 1 OF 1

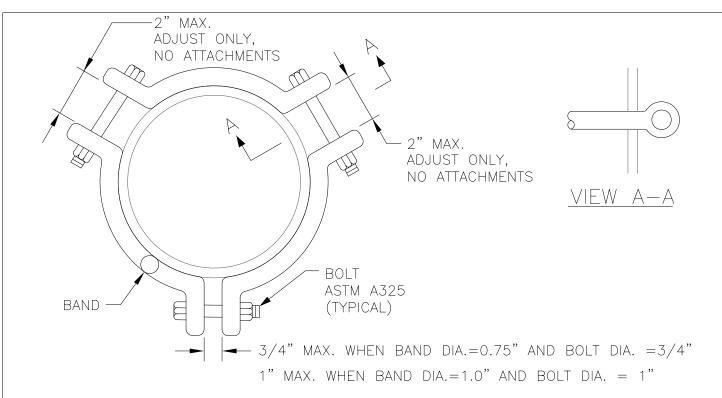

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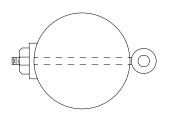
COLLAR M	.B			
DIAMETER	POL	POLE SIZE		
RANGE	BUTT Ø	ATT HT	& BOLT DIA.	
4.25" - 5.5"	8"	19' - 24'	.75"	
6" - 7.25"	10"	19' - 29'	.75"	
7" - 8.25"	11"	19' - 29'	.75"	
8" - 9.25"	12"	19' - 29'	.75"	
9" - 10.25"	13"	19' - 29'	.75"	
10" - 11.25"	14"	19' - 29'	.75"	
11" - 12.25"	15"	19' – 29'	.75"	

COLLAR MAX LOAD=5000 LB								
DIAMETER	POL	BAND						
RANGE	BUTT Ø	ATT HT	DIA.					
9" - 10.25"	13"	19' - 29'	1"					
10" - 11.25"	14"	19' - 29'	1"					
11" - 12.25"	15"	19' – 29'	1"					


NOTES

- 1. CONTACT KORTICK MFG CO AT: 5600 3RD ST, SAN FRANCISCO, CA (415) 822-6660
- 2. MAXIMUM NUMBER OF ATTACHMENTS PER COLLAR IS ONE, UNLESS APPROVED BY THE ENGINEER.

	MATERIAL LIST								
ITEM #	Q	TY		DESCRIF	PTION	MANUFACTURER	CAT. NO.		
102	VA	RIES			IECE ADJUSTABLE EALED & GALVANIZED	KORTICK MFG CO			
DESIGNED CHKD: A WOLAK D GRE DR: SCALE: B FARISSB NON		REER ONE	ŀA	METRO TRANSIT TROLLEY OVERHE STANDAR		DATE: APRIL 2008 FILE			
RECOM. APPROVED J DAVIS		IBIS NO:		King County	STEEL POLE COLLAR		DWG. NO. SA-102 SHT 1 OF 1		



PLAN

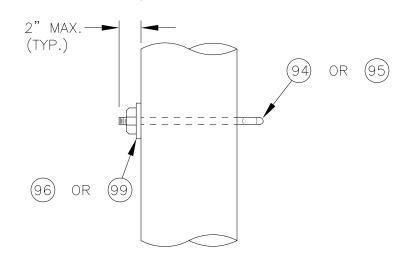

WOOD POLE EYEBOLT

NOTES:

APPROVED

J DAVIS


- 1. WOOD POLE EYEBOLTS SHALL HAVE A MINIMUM DIAMETER OF 5/8". 5/8" DIAMETER EYEBOLTS SHALL BE USED FOR WOOD POLE ATTACHMENT OF ALL <u>SINGLE</u> 8M TANGENT WORK SPANS. 3/4" DIAMETER EYEBOLTS SHALL BE USED FOR ALL OTHER WOOD POLE ATTACHMENTS.
- 2. MULTIPLE CABLE ATTACHMENTS TO 3/4" DIAMETER EYEBOLTS SHALL BE LIMITED TO A RESOLVED (RESULTANT) DESIGN TENSION OF 5000 LBS @ 60 DEGREES F.

	MATERIAL LIST							
ITEM #	QT	Y		DESCRIPT	ION	MANUFACTURER	CAT. NO.	
94		*	5/8'	'OVAL EYEB(DLT W/ NUT	JOSLYN	J94XX	
95		*	3/4'	OVAL EYEB	DLT W/ NUT	JOSLYN	J95XX	
96		*	SQ (SQ CURVED WASHER 3"x3"x1/4",		JOSLYN	J113	
99		*	SQ (SQ CURVED WASHER 3"x3"x¼", ¹³ / ₄ " DIA		JOSLYN	J6823	
DESIGNED CHKD: A WOLAK D GREER			METRO TRANSI TROLLEY OVERHI		DATE: APRIL 2008			
DR: SCALE:				STANDAF		FILE		
B FARISSB NONE RECOM. IBIS NO:				WOOD F	POLE	DWG. NO.		

EYEBOLT ASSEMBLY

King County

CONTRACT NO:

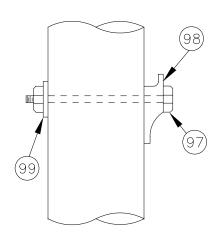

WOOD POLE DOWN GUY ATTACHMENT

	MATERIAL LIST						
ITEM #	ITEM # QTY DESCRIPTION		MANUFACTURER	CAT. NO.			
97	1	¾" MACHINE BOLT	JOSLYN	J89XX			
98	1	GUY HOOK, ¾"	STANLEY	P133AX			
99	1	SQ CURVED WASHER 3"x3"x4",13/6" DIA	JOSLYN	J6823			

DESIGNED CHKD:
A WOLAK D GREER
DR: SCALE:
B FARISSB NONE
RECOM. IBIS NO:

APPROVED CONTRACT NO:
J DAVIS




METRO TRANSIT DIVISION TROLLEY OVERHEAD SYSTEM STANDARDS

WOOD POLE DOWN GUY ASSEMBLY

date: APRIL	2008
FILE	


DWG. NO.

SA-104 SHT OF

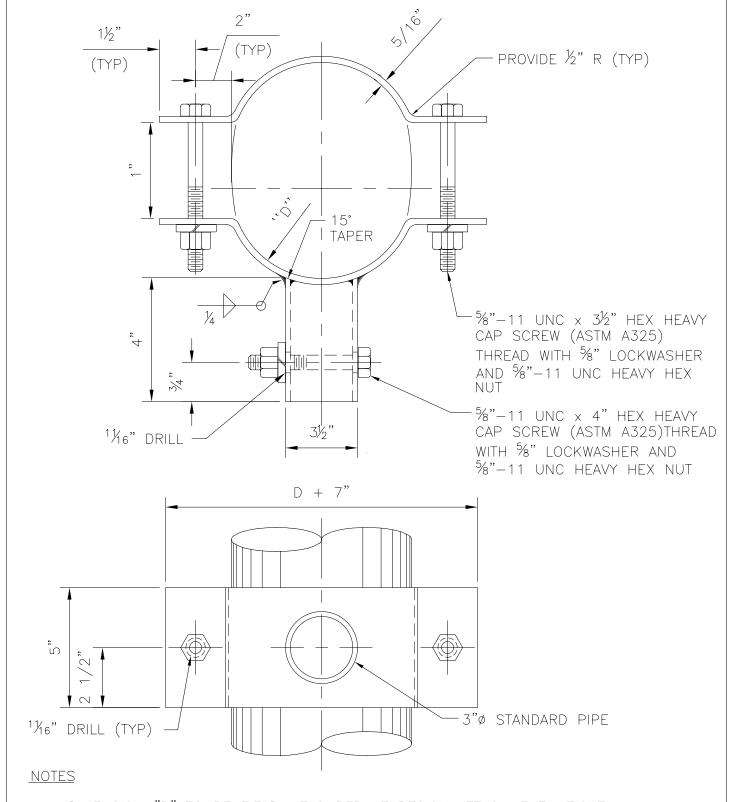


- 1. DIMENSION "D" TO BE FIELD MEASURED AT DESIGN ATTACHMENT HEIGHT.
- 2. MATERIAL FOR COLLARS SHALL BE ASTM A-36 STEEL. HOT DIP GALVANIZE METAL AFTER FABRICATION.

DESIGNED A WOLAK	CHKD: D GREER		METRO TRANSIT DIVISION TROLLEY OVERHEAD SYSTEM	DATE: APRIL 2008
DR: B FARISSB	scale: NONE	l:A	STANDARDS	FILE
RECOM.	IBIS NO:		COMPRESSION	DWG. NO.
APPROVED	CONTRACT NO:	King County	POLE BRACKET	SA-106
J DAVIS			POLE COLLAR	SHT OF 1

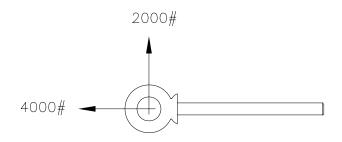

ALLOWABLE DEAD LOAD AT 60°.

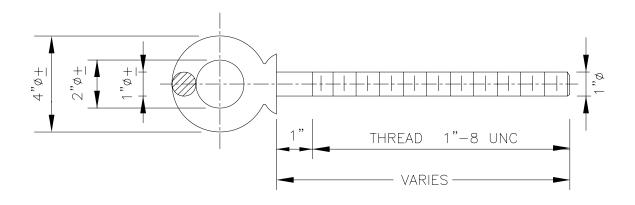

NOTES:

- 1. EYEBOLT SHALL BE 1" DROP FORGED, STAINLESS STEEL, SHOULDER PATTERN; MADE FROM TYPE 316 STAINLESS STEEL, UNC-2 THREADS, ELECTRO-POLISHED FINISH.
- 2. EYEBOLT SHALL BE MCGRAW-EDISON, CAMPBELL CHAIN M-29-ST 640-5015, MCMASTER-CARR 3032T49. NUMBERS ARE FOR 6" LENGTH; OTHER LENGTHS ARE SPECIAL.
- 3. MATERIAL YIELD STRESS SHALL BE 30,000 PSI MIN. TENSILE STRESS SHALL BE 75,000 PSI MIN.

DESIGN NOTES:

1. THE DEAD LOAD + LIVE LOAD IS 2 TIMES THE ALLOWABLE DEAD LOAD AT 60°. THE BREAKING LOAD IS 4 TIMES THE ALLOWABLE DEAD LOAD AT 60°.


DESI	GNED	CHK	D:	
Α	WOLAK	D	GREER	
DR:		SCAL	E:	
В	FARISSB		NONE	
RECOM.		IBIS	NO:	
				ı
APPF	ROVED	CON	TRACT NO:	
J	DAVIS			



METRO TRANSIT DIVISION TROLLEY OVERHEAD SYSTEM STANDARDS

STAINLESS STEEL EYEBOLT

DATE:
APRIL 2008
FILE
DWG. NO.
C
SA-10/
SHT 0F 1

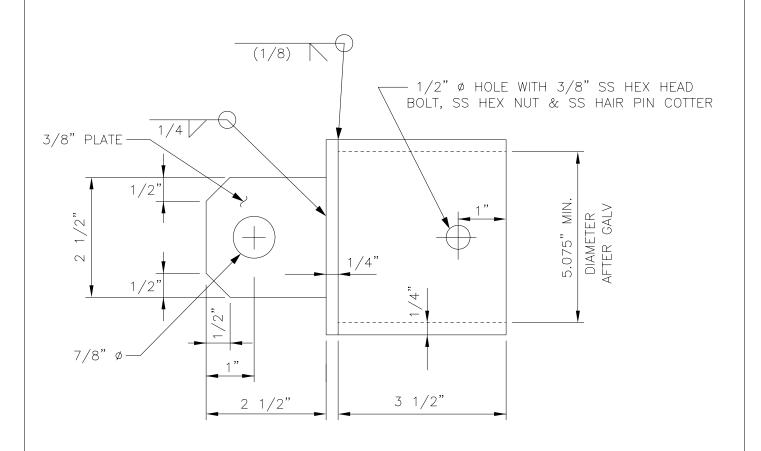

POLE END CAP DETAIL

NOTES:

1. GALVANIZE AFTER FABRICATION.


DESIGNED A WOLAK	CHKD: D GREER
DR: B FARISSB	SCALE:
RECOM.	IBIS NO:
APPROVED J DAVIS	CONTRACT NO:



METRO TRANSIT DIVISION TROLLEY OVERHEAD SYSTEM STANDARDS

> BRACKET ARM POLE END CAP

DATE:
APRIL 2008
FILE
5,110
DWG. NO.
SA-108
SHT OF 1

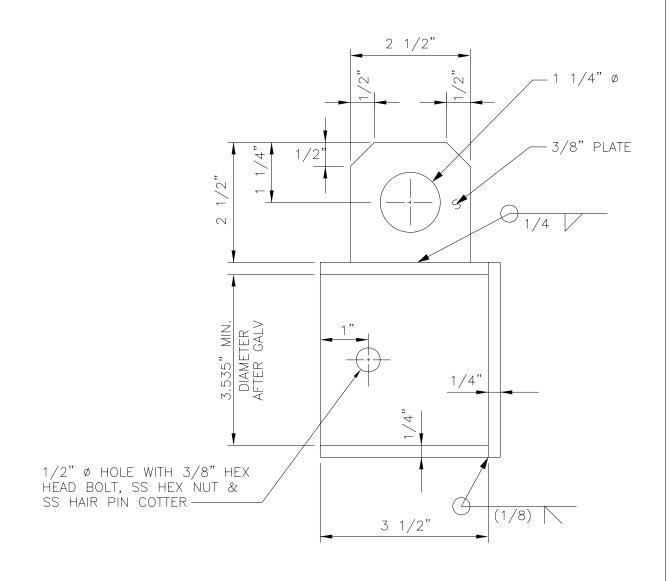

ARM END CAP DETAIL

NOTES:

1. GALVANIZE AFTER FABRICATION.


DESIGNED A WOLAK	CHKD: D GREER
DR: B FARISSB	SCALE:
RECOM.	IBIS NO:
APPROVED J DAVIS	CONTRACT NO:



METRO TRANSIT DIVISION TROLLEY OVERHEAD SYSTEM STANDARDS

BRACKET ARM END CAP

date: APRIL 2008	
FILE	
DWG. NO.	
SA-109	

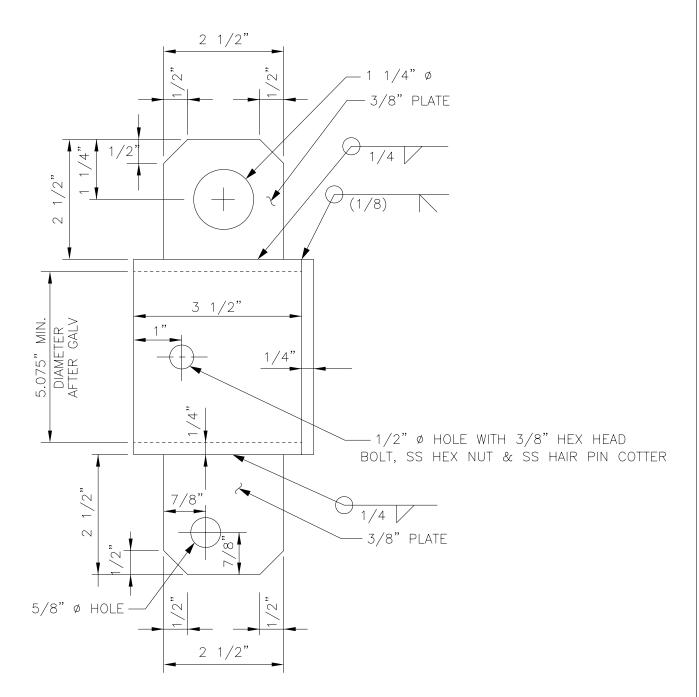


UNDERSLING END CAP DETAIL

NOTES:

1. GALVANIZE AFTER FABRICATION.

DESIGNED A WOLAK	CHKD: D GREER		METRO TRANSIT DIVISION TROLLEY OVERHEAD SYSTEM	APRIL 2008
DR: B FARISSB	SCALE:		STANDARDS	FILE
RECOM.	NONE IBIS NO:		BRACKFT ARM	DWG. NO.
APPROVED	CONTRACT NO:	King County	SPAN FND CAP	SA-110
J DAVIS	CONTRACT NO.		SPAN END CAP	SHT OF 1

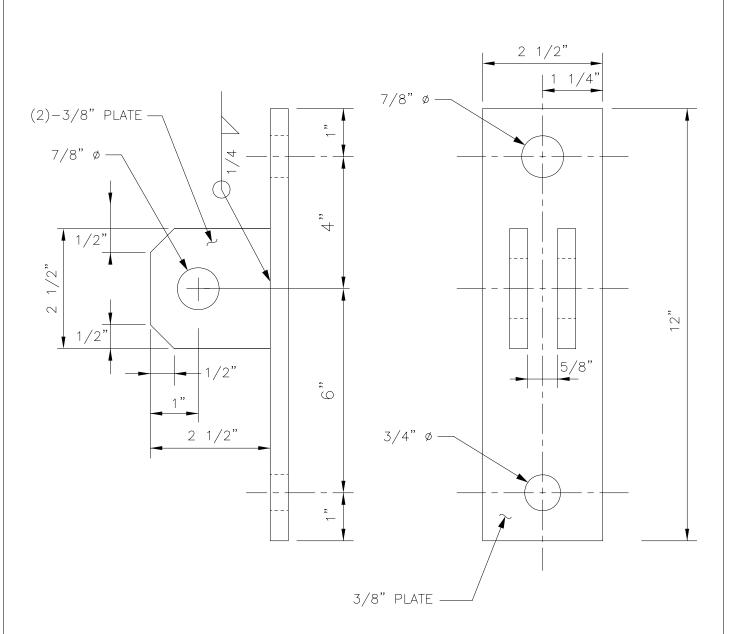

<u>WOOD POLE</u> MOUNTING BRACKET DETAIL

NOTES:

1. GALVANIZE AFTER FABRICATION.


0.0.	gned WOLAK	снкі D	^{d:} GREER	
DR:		SCAL	_E:	1
В	FARISSB		NONE	
RECOM.		IBIS	NO:]
APPF	ROVED	CON.	TRACT NO:	1
J	DAVIS			



METRO TRANSIT DIVISION TROLLEY OVERHEAD SYSTEM STANDARDS

WOOD POLE MOUNTING BRACKET


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FILE				
DWG. NO.				
SA-	1	1	1	
SHT	OF	=		

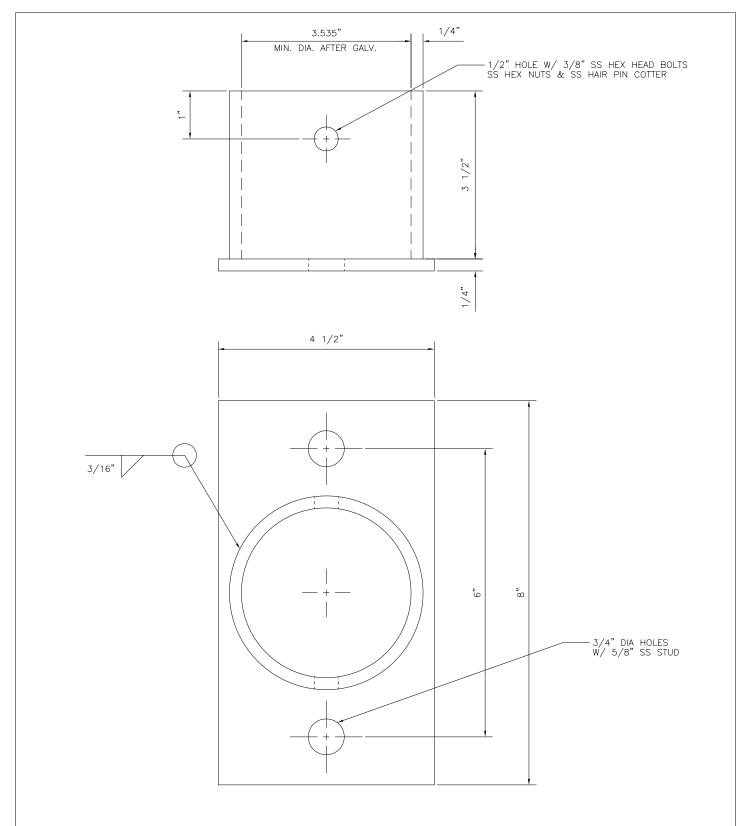

NOTE: HOT DIP GALVANIZE AFTER FABRICATION

3.5" TUBE SOCKET PLATE

DESIGNED A WOLAK	CHKD: D GREER		METRO TRANSIT DIVISION TROLLEY OVERHEAD SYSTEM	APRIL 2008
DR: B FARISSB	scale: NONE	ŀA	STANDARDS	FILE
RECOM.	IBIS NO:		3.5" TUBE	DWG. NO. SA — 112
APPROVED J DAVIS	CONTRACT NO:	King County	SOCKET PLATE	SHT OF 1

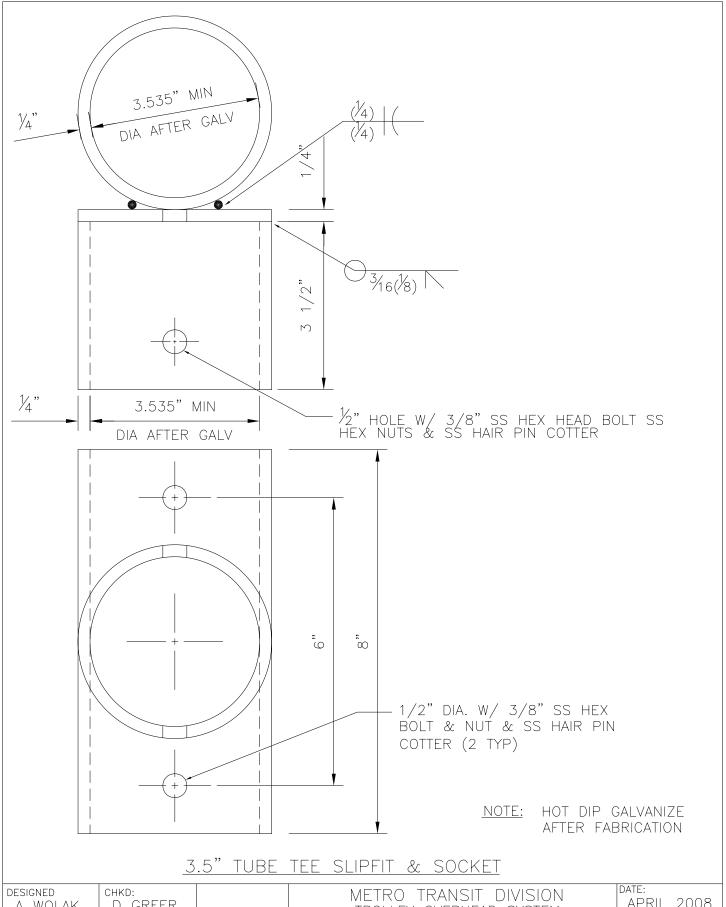


DESIGNED A WOLAK	CHKD: D GREER	
DR:	SCALE:	
B FARISSB RECOM.	NONE IBIS NO:	
approved J DAVIS	CONTRACT NO:	



METRO TRANSIT DIVISION TROLLEY OVERHEAD SYSTEM STANDARDS

3.5" TUBE TEE SLIPFIT & SOCKET

DATE:	
APRIL 2008	3
FILE	
DWC NO	
DWG. NO.	,
SA-113)
SHT 1 OF 1	
	APRIL 2008 FILE DWG. NO. SA-113

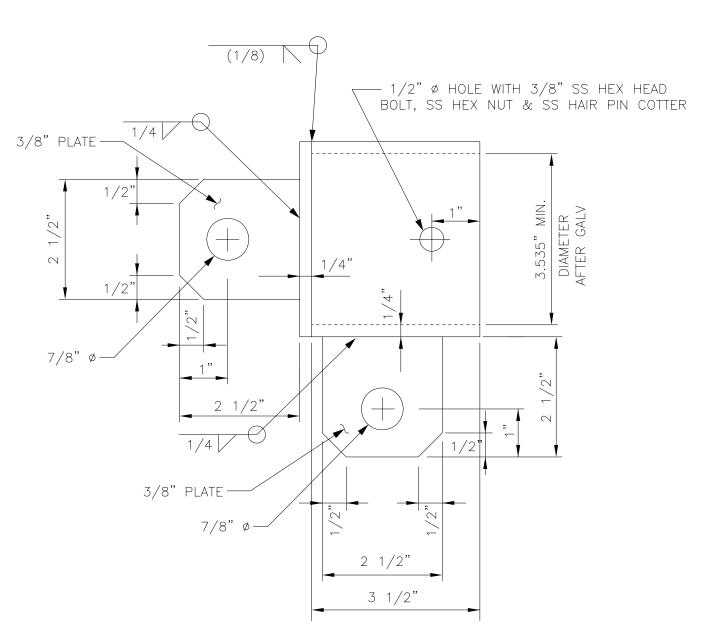


POLE END CAP WITH BOTTOM TAB DETAIL

NOTES:

1. GALVANIZE AFTER FABRICATION.

DESIGNED A WOLAK	CHKD: D GREER		METRO TRANSIT DIVISION TROLLEY OVERHEAD SYSTEM	date: APRIL 2008
DR: B FARISSB	scale: NONE	1.6	STANDARDS	FILE
	IBIS NO:	€	BRACKET ARM	DWG. NO.
APPROVED J DAVIS	CONTRACT NO:	King County	POLE END CAP WITH BOTTOM TAB	SHT 1 OF 1

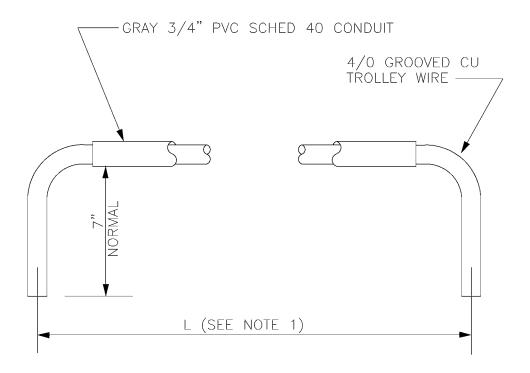

NOTES:

1. JUMPER WIRE AND ASSOCIATED INSULATING SLEEVE SHALL BE FIELD CUT TO LENGTH AS REQUIRED FOR EACH SPECIAL WORK DEVICE.


1	DESIGNED	CHKD:
	DPG	DOW
ĺ	DR:	SCALE:
	CMS	NONE
5	RECOM.	CONTRACT:
:	APPROVED	



DEPARTMENT OF TRANSPORTATION TROLLEY STANDARDS

SPECIAL WORK
INSULATED JUMPER
ASSEMBLY

DATE:
JUN 95
FILE
DWG. NO.
SA - 151
SHT 1 OF 1

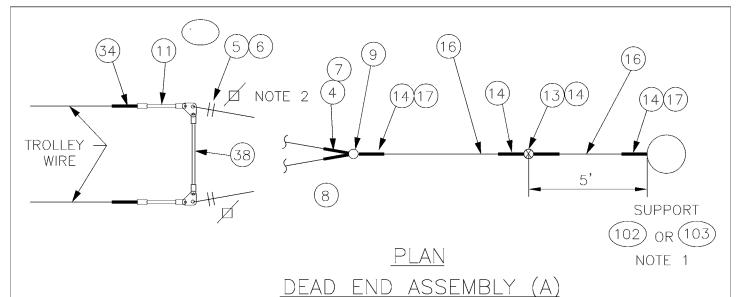

NOTES

- A POLE COLLAR OR POLE EYEBOLT IS REQUIRED PER SA-102 OR SA-103 UNLESS A BUILDING EYEBOLT ATTACHMENT IS USED. INSTALLATION HEIGHT IS SHOWN ON THE OVERHEAD DRAWINGS.
- PROVIDE TENSION ADJUSTMENT POINTS AT LOCATIONS INDICATED BY "". PROVIDE WIRE ROPE CLIPS AT THESE LOCATIONS. SEE SA-166.

		MATERIAL LIST		
ITEM #	QTY	DESCRIPTION	MANUFACTURER	CAT. NO.
	2	GUY STRAIN INSUL	PORCELAIN	504
			PRODUCTS CO.	
	6	GUY GRIP DEADEND	PREFORMED	CDE-3106
	4	WIRE ROPE CLIP, 5/16"	CROSBY	G450
	AS REQD	FRICTION TAPE, 3/4" (6 WRAPS)		
	2	THIMBLE, 3/8" XHD, OPEN	CROSBY	G414
	VARIES	GUY STRAND	COPPERWELD	8M
	1	BULL RING	WABCO	18567-2000
	2	7/8 TRANSLITE STRAIN INSUL CL-CL	WABCO	54975-6120
	1		PORCELAIN	506
			PRODUCTS CO.	
	4	GUY GRIP DEADEND	PREFORMED	CDE-3115
	VARIES	GUY STRAND	COPPERWELD	16M
	2	THIMBLE, 1/2" XHD, OPEN	CROSBY	G414
	2		WABCO	17700-2000
	1	SLITE STRAIN INSUL CL-CL	WABCO	54975-6200
	2		WABCO	13722-2000
	2		METRO STD	SA-101
	VARIES		KORTICK	
			MFG CO	
	VARIES		METRO STD	SA-103


V:\Library & Standards\Standards\Trolley\Detalls\SA-151-153.dwg, SA-152.1, 1/5/2007 12:18:30 PM DESIGNED CHKD: DOW DPG DR: SCALE: NONE TMB RECOM. CONTRACT: APPROVED

King County

DEPARTMENT OF TRANSPORTATION TROLLEY STANDARDS

> TROLLEY WIRE DEADEND ASSEMBLY

OCT 95 FILE DWG. NO. OF 1

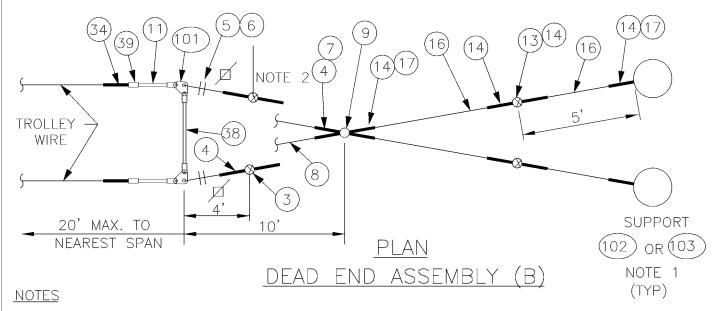

- A POLE COLLAR OR POLE EYEBOLT IS REQUIRED PER SA-102 OR SA-103 UNLESS A BUILDING EYEBOLT ATTACHMENT IS USED. INSTALLATION HEIGHT IS SHOWN ON THE OVERHEAD DRAWINGS.
- 2. PROVIDE TENSION ADJUSTMENT POINTS AT LOCATIONS INDICATED BY "\".
 PROVIDE WIRE ROPE CLIPS AT THESE LOCATIONS. SEE SA-166.

V:\Library & Standards\Standards\Trolley\Detalls\SA-151-153.dwg, SA-152.2, 1/5/2007 12:18:39 PM

DPG

DR:

TMB

RECOM.

APPROVED

DOW

CONTRACT:

NONE

King County

SCALE:

	MATERIAL LIST							
ITEM #	QTY	DESCRIPTION	MANUFACTURER	CAT. NO.				
03	2	GUY STRAIN INSUL	PORCELAIN	504				
			PRODUCTS CO.					
04	6	GUY GRIP DEADEND	PREFORMED	CDE-3106				
05	4	WIRE ROPE CLIP, 5/16"	CROSBY	G450				
06	AS REQD	FRICTION TAPE, 3/4" (6 WRAPS)						
07	2	THIMBLE, 3/8" XHD, OPEN	CROSBY	G414				
08	VARIES	GUY STRAND	COPPERWELD	8M				
09	1	BULL RING	WABCO	18567-2000				
11	2	7/8 TRANSLITE STRAIN INSUL CL-CL	WABCO	54975-6120				
13	1	GUY STRAIN INSUL	PORCELAIN	506				
			PRODUCTS CO.					
14	4	GUY GRIP DEADEND	PREFORMED	CDE-3115				
16	VARIES	GUY STRAND	COPPERWELD	16M				
. 17	2	THIMBLE, 1/2" XHD, OPEN	CROSBY	G414				
17 34 38	2	TYPE T DOUBLE EAR STRAIN CLAMP	WABCO	17700-2000				
38	1	7/8 TRANSLITE STRAIN INSUL CL-CL	WABCO	54975-6200				
39	2	5/8" SHACKLE	WABCO	13722-2000				
101	2	STRAIN PLATE	METRO STD	SA-101				
102	VARIES	FORGED THREE-PIECE ADJUSTABLE	KORTICK					
		POLE BAND, ANNEALED & GALVANIZED	MFG CO					
103	VARIES	WOOD POLE EYEBOLT	METRO STD	SA-103				
DEPARTMENT OF TRANSPORTATION DATE:								

TROLLEY STANDARDS

TROLLEY WIRE


DEADEND ASSEMBLY

OCT 95


OF

FILE

DWG. NO.

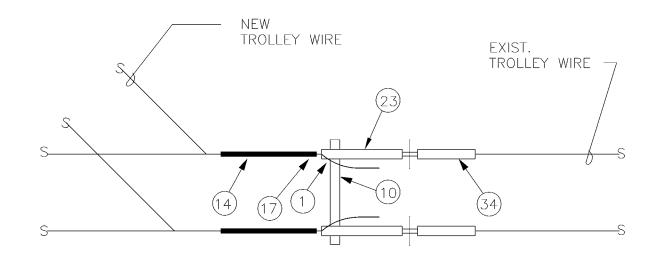

PLAN

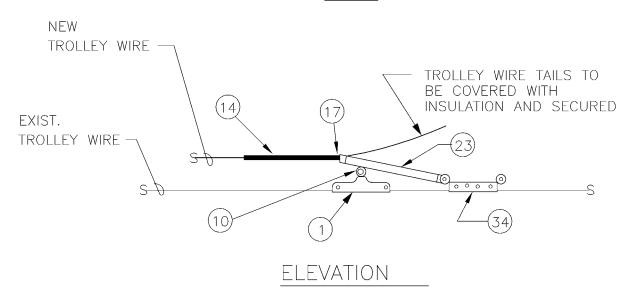

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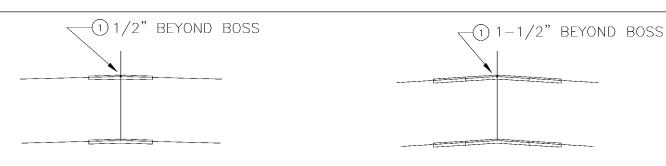
SCALE:

NONE

18:46 PM	MATERIAL LIST							
, 1/5/2007 12::	ITEM #	QT	Y		DESCRIPT	TION	MANUFACTURER	CAT. NO.
SA-153	01	2	>	DETROI	T CLAMP AS	SY	WABCO	19293-3007
3.dwg,	10	1		HI-LITE	E DOUBLE C	URVE HANGER	WABCO	54962-3001
51-15	14	2	2 GUY (RIP DEADEND		PREFORMED	CDE-3115
Is\SA-1	17	7 2 THIMBLE, 1/2" XH			E, 1/2" XH[), OPEN	CROSBY	G414
\Detai	23	2	<u> </u>	7/8 TF	RANSLITE STE	RAIN INSUL CL—CL	WABCO	54975-6260
Trolley	34	2	<u> </u>	TYPE T	DOUBLE EA	AR STRAIN CLAMP	WABCO	17700-2000
Standards	DESIGNED DPC	5	CHKD: DOV			DEPARTMENT OF T TROLLEY ST		JUN 95
tandards\	DR: TMB	SCALE: NONE						FILE
\Library & S	RECOM.		CONTR	ACT:		STAG Deadend <i>A</i>		DWG. NO. SA-153
>	APPROVED				77' G 1		· · · · - ·	SHT OF .




1	7700-20	000	
	DATE:	<u> </u>	
	JUN	95	
	FILE		
	DWG. NO.		
	SA-	15.	3
	SHT 1	OF	1





1°-5° CURVE RAIL


5.5°-7.5° CURVE RAIL

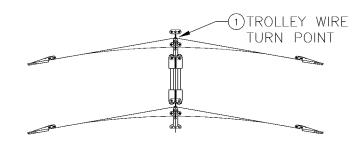

8°-12° & 13°-27° CURVE SEGMENT

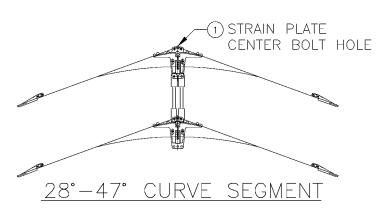

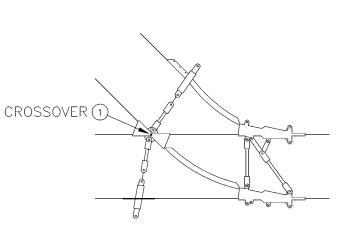

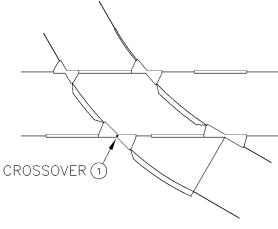

SWITCH OR TRAILING FROG CROSSOVER/CURVE SEGMENT

(1) DEVICE REFERENCE POINT

	DESIGNED	CHKD:	
	DPG	DOW	
	DR:	SCALE:	
	CMS	NONE	
	RECOM.	CONTRACT:	
-	APPROVED		١,




DEPARTMENT OF TRANSPORTATION TROLLEY STANDARDS

SPECIALWORK DEVICE REFERENCE POINT LOCATIONS

DATE:
JUN 95
FILE
DWG. NO.
SA-161
SHT 1 OF 1

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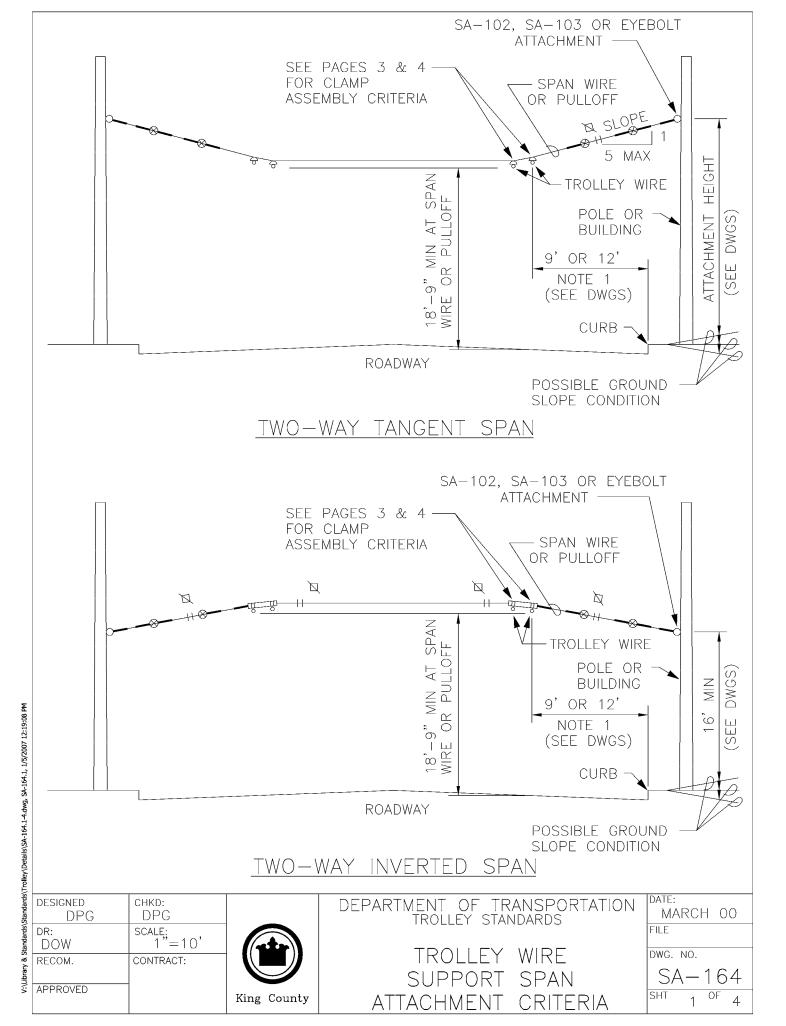
CONTACTOR ELEVATION A-A

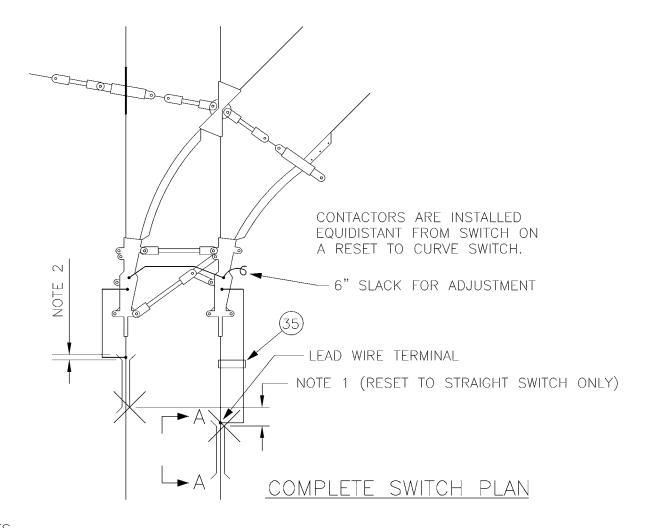



NOTES

- 1. PROVIDE A 4-1/2" INTERVAL BETWEEN OPPOSITE POLARITY CONTACTORS. MEASURE FROM POINT OF CONTACT WITH TROLLEY SHOE AND CONTACTOR.
- 2. PROVIDE A 1" OVERLAP BETWEEN CONTACTOR AND END OF SWITCH TROLLEY WIRE CLAMP.


MATERIAL LIST						
ITEM #	QTY	DESCR	CAT. NO.			
35	AS REQD	CLAMP, INSUL L	EAD WIRE	WABCO	19655-2000	
DESIGNED CHKD: DPG DOW DR: SCALE:			DEPARTMENT OF TRANSPORTATION TROLLEY STANDARDS		DATE: JUN 95 FILE	
TMB NONE RECOM. CONTRACT:			OVERHEAD SPE		DWG. NO. SA-163	
APPROVED	SWITCH CONTACTOR CONFIGURATION				SHT 1 OF 1	



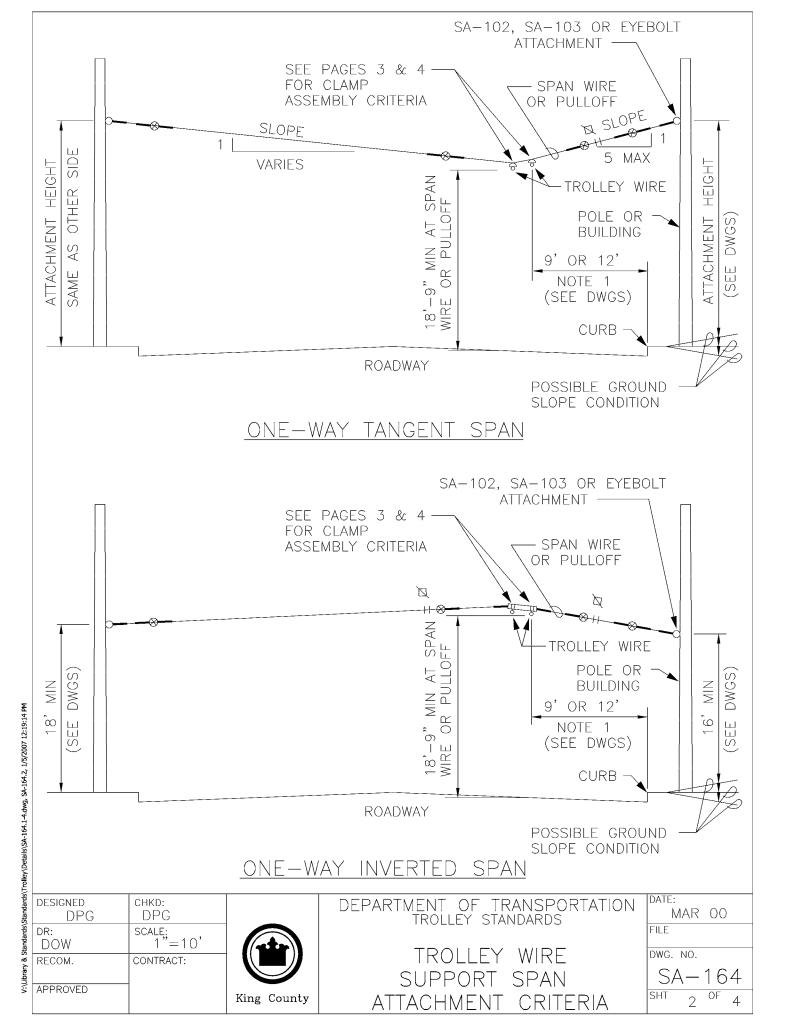


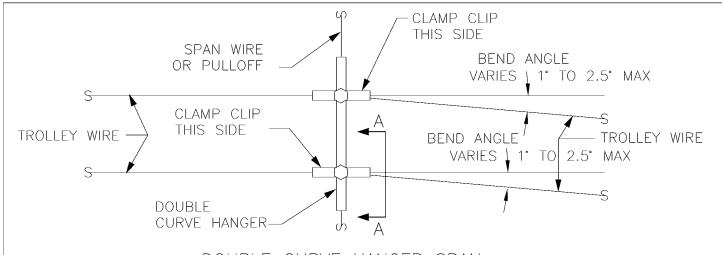

DOUBLE CURVE HANGER SPAN

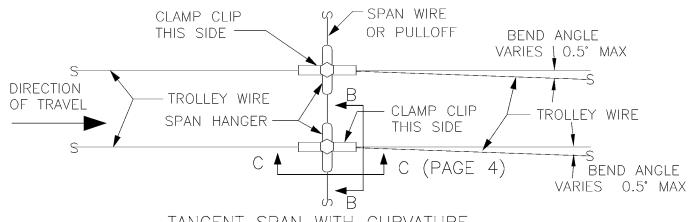

TANGENT SPAN WITH CURVATURE

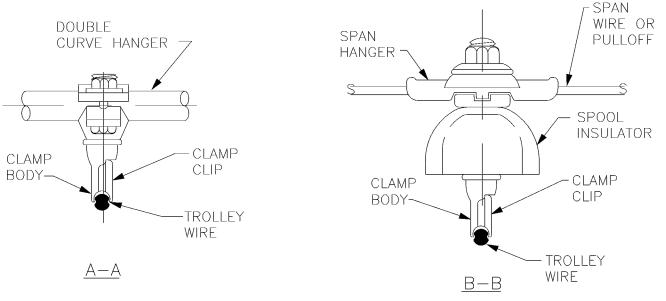

CLAMP ASSEMBLY CRITERIA

V:\Library & Standards\Standards\Trolley\Details\SA-164.1-4.dwg, SA-164.3, 1/5/2007 12:19:20 PM	CLAMP BODY—	<u>A-A</u>	_
Trolley\E		-	<u>C</u>
Standards\	DESIGNED DPG	снко: DOW	
tandards\	DR: TMB	scale: NONE	
V:\Library & !	RECOM. APPROVED	CONTRACT:	




DEPARTMENT OF TRANSPORTATION TROLLEY STANDARDS

TROLLEY WIRE
SUPPORT SPAN
ATTACHMENT CRITERIA

DATE:
OCT 95
FILE
DWG. NO.
SA-164
SHT 7 OF 1



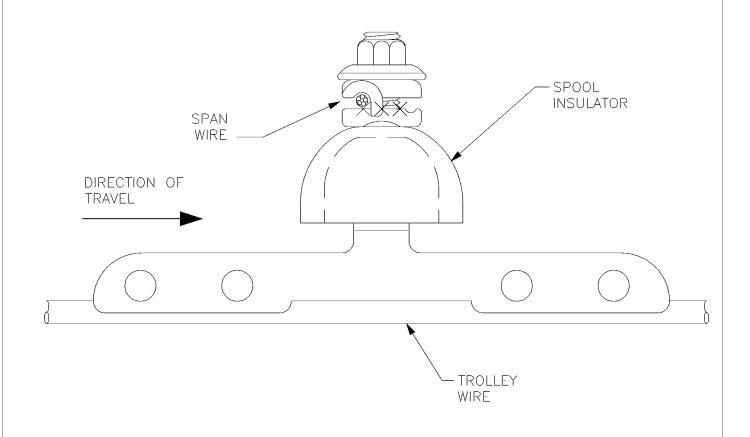

<u>NOTES</u>

 9' IS NORMAL FOR EXTENDED ZONES OF TANGENT SPANS WHERE NO PARKING IS ALLOWED. 12' IS NORMAL FOR EXTENDED ZONES OF TANGENT SPANS WHERE PARKING IS ALLOWED.

C-C


Standards	DESIGNED DPG	снко: DOW	
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>	APPROVED		





DEPARTMENT OF TRANSPORTATION TROLLEY STANDARDS

TROLLEY WIRE
SUPPORT SPAN
ATTACHMENT CRITERIA

DATE:		
JUN	95	
FILE		
DWG. NO.		
DWG. NO.		
SA-	16	4
SHT 4	OF	4

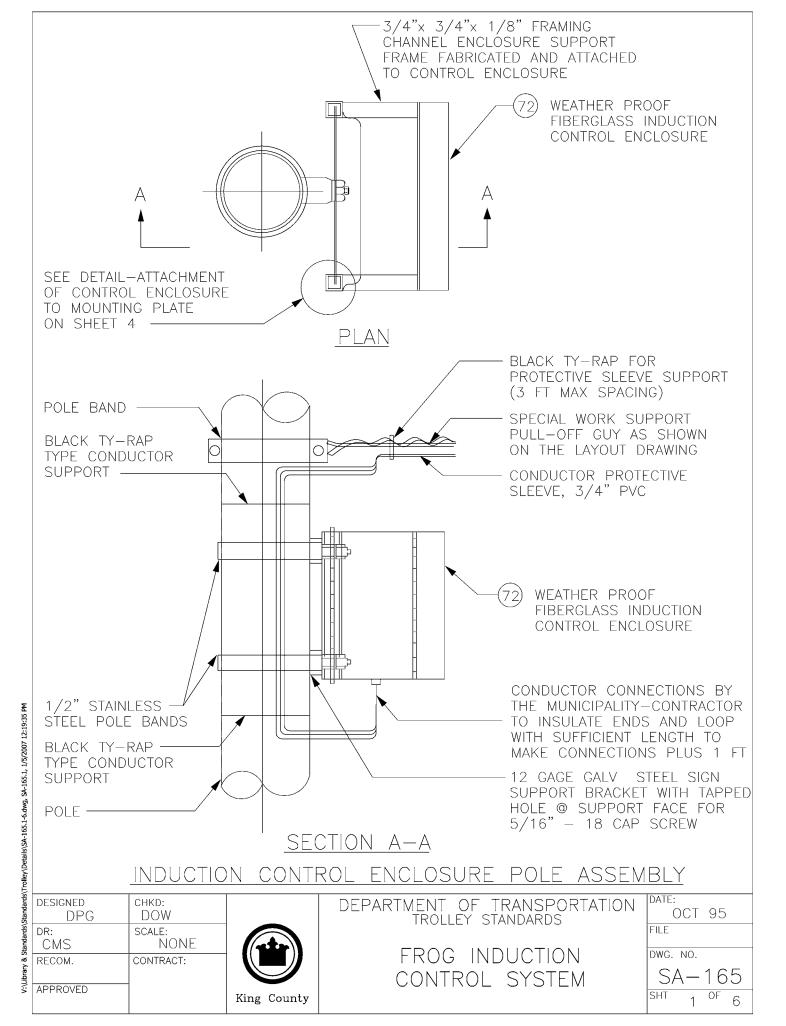

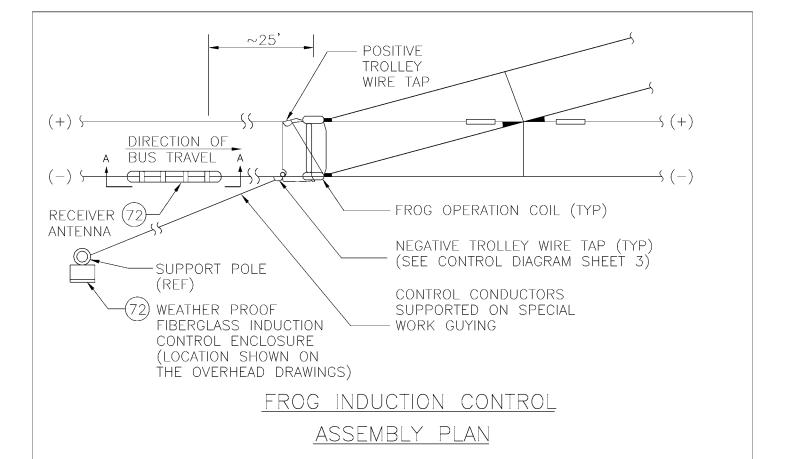

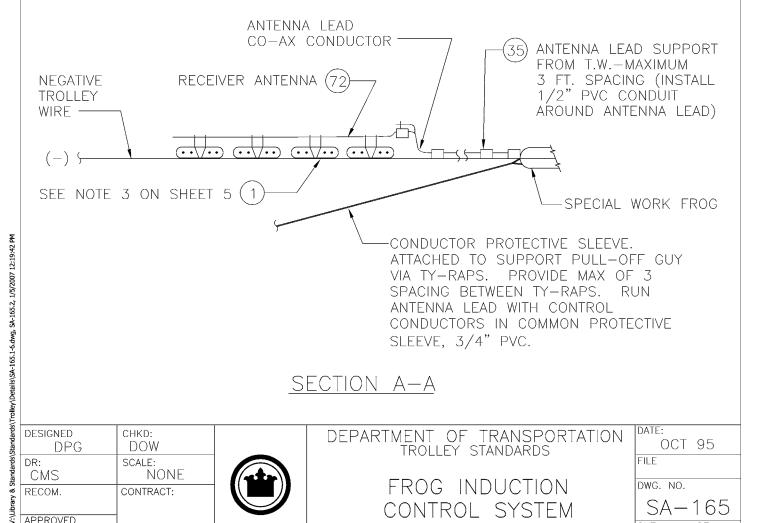


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	DESIGNED	CHKD:	
1	DPG	DOW	
1	DR:	SCALE:	
	CMS	NONE	
5	RECOM.	CONTRACT:	
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:	APPROVED		l
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DEPARTMENT OF TRANSPORTATION TROLLEY STANDARDS

> FROG INDUCTION CONTROL SYSTEM

DATE:
OCT 95
FILE
DWG. NO.
SA-165
SHT 2 OF 6



INDUCTION SYSTEM CONTROL DIAGRAM

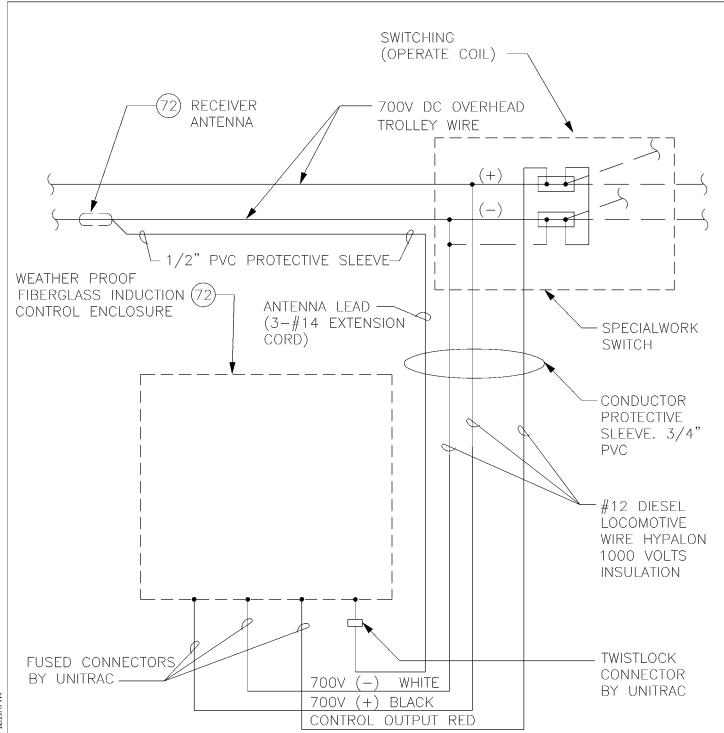NOTES:

ALL CONNECTIONS AT ANTENNA, SWITCH AND CONTROL BOX BY THE MUNICIPALITY.


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	DESIGNED	CHKD:	
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	DR:	SCALE:	
	CMS	NONE	
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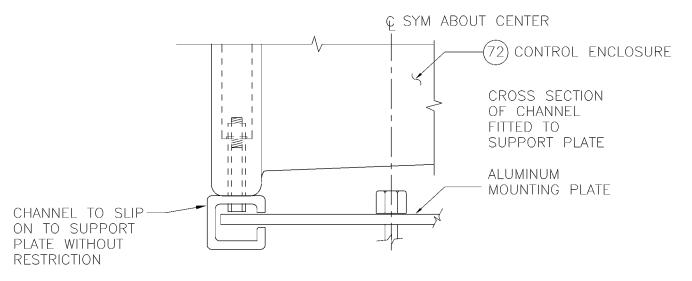
DEPARTMENT OF TRANSPORTATION TROLLEY STANDARDS

FROG INDUCTION CONTROL SYSTEM

DATE:
OCT 95
FILE
DWG. NO.
SA-165
SHT 3 OF 6



ALUMINUM MOUNTING PLATE DETAIL

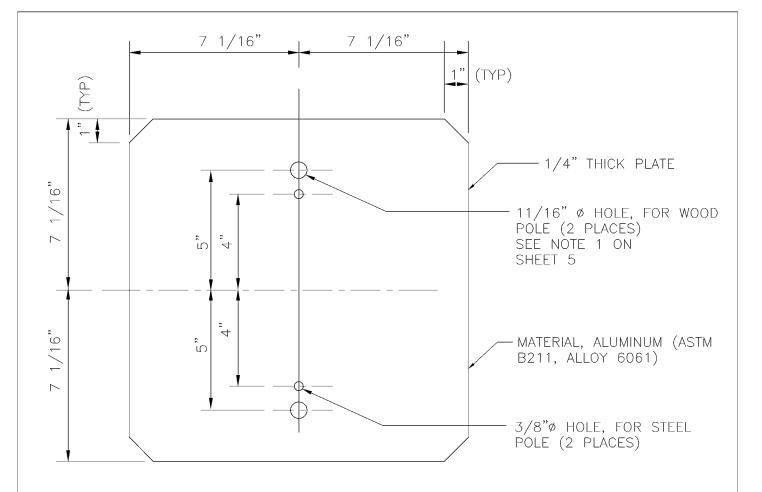

DETAIL—ATTACHMENT OF CONTROL ENCLOSURE TO MOUNTING PLATE

5			
oranualus (oranualus) i	DESIGNED DPG	CHKD: DOW	
5	2, 0		
ä	DR:	SCALE:	
9	CMS	NONE	
	RECOM.	CONTRACT:	
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	APPROVED		,
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DEPARTMENT OF TRANSPORTATION TROLLEY STANDARDS

FROG INDUCTION CONTROL SYSTEM

DATE: OCT 95
FILE
DWG. NO.
SA-165
SHT 4 OF 6

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GENERAL NOTES

- 1. WHERE THE SUPPORT POLE IS WOOD, THE CONTROL ENCLOSURE MOUNTING PLATE SHALL BE ATTACHED DIRECTLY TO THE POLE BY MEANS OF ONE HOT-DIP GALVANIZED 5/8-INCH DIAMETER HEX HEAD THROUGH BOLT WITH ATTACHMENT NUT AND WASHER MOUNTED THROUGH THE TOP HOLE OF THE SUPPORT PLATE AND ONE HOT-DIP GALVANIZED 5/8-INCH BY 6-INCH GIMLET POINT HEX HEAD LAG SCREW MOUNTED THROUGH THE BOTTOM HOLE OF THE SUPPORT PLATE.
- THE CONTROL ENCLOSURE SHALL BE LOCATED IN PROXIMITY OF THE PULL-OFF CABLE ATTACHMENTS AT THE SUPPORT POLE. THE ENCLOSURE SHALL, AS PRACTICAL, BE LOCATED AT THE SIDE OF THE POLE FACING THE CURB. ENCLOSURE MAY BE INSTALLED EITHER ABOVE OR BELOW THE PULL-OFF GUY CABLE ATTACHMENT AT THE POLE, AS SUITABLE, TO PREVENT CONFLICT WITH OTHER ATTACHMENTS TO THE POLE. THE ENCLOSURE SHALL BE SO LOCATED ON THE POLE THAT CONFLICTS WILL NOT BE INTRODUCED TO ACCESSIBILITY OF EXISTING UTILITIES AND POLE CLIMBING SPACES. ON JOINT USE POLES HAVING A CROSS-ARM, THE ENCLOSURE SHALL BE MOUNTED ON THE CROSS-ARM TO PREVENT CONFLICT WITH CLIMBING SPACE. WHERE A JOINT USE POLE IS WITHOUT A CROSS-ARM, THE CONTRACTOR SHALL COORDINATE ENCLOSURE MOUNTING SPACE SITH THE JOINT USE OWNERS OF THE POLE.
- THE HOLES FORMED IN THE ANTENNA WEB FOR MOUNTING OF THE ANTENNA MAY BE ENLARGED TO ACCOMMODATE THE 5/8-INCH DIAMETER BOLTS REQUIRED FOR ANTENNA ATTACHMENT TO THE SUPPORTING TROLLEY WIRE CLAMPS.

	MATERIAL LIST							
ITEM # QTY DESCRIPTION MANUFACTURER CAT.						CAT. NO.		
01	4	DETROIT CLAMP ASSY				WABCO	19293-3007	
35	AS REQD	CLAMP, INS	UL LEAD) WIRE		WABCO	19655-2000	
72	1	INDUCTIVE	CONTROL	SYSTEM RECEIVER		UNITRAC	320100-16X	
07	07 1 INDUCTIVE CONTROL			SYSTEM ANTENNA		UNITRAC	320310-4X	
DESIGNED	CHKD:			DEDARTMENT (DATE:	


Standards\Standards\Trolley\Details\SA-165.1-6.dwg, SA-165.5, 1/5/2007 12:19:58 PM DOW DPG SCALE: DR: NONE CMS RECOM. CONTRACT: APPROVED



TRANSPORTATION DEPARIMENT () -TROLLEY STANDARDS

> FROG INDUCTION CONTROL SYSTEM

DATE:
OCT 95
FILE
DWG. NO.
SA-165
SHT 5 OF 6

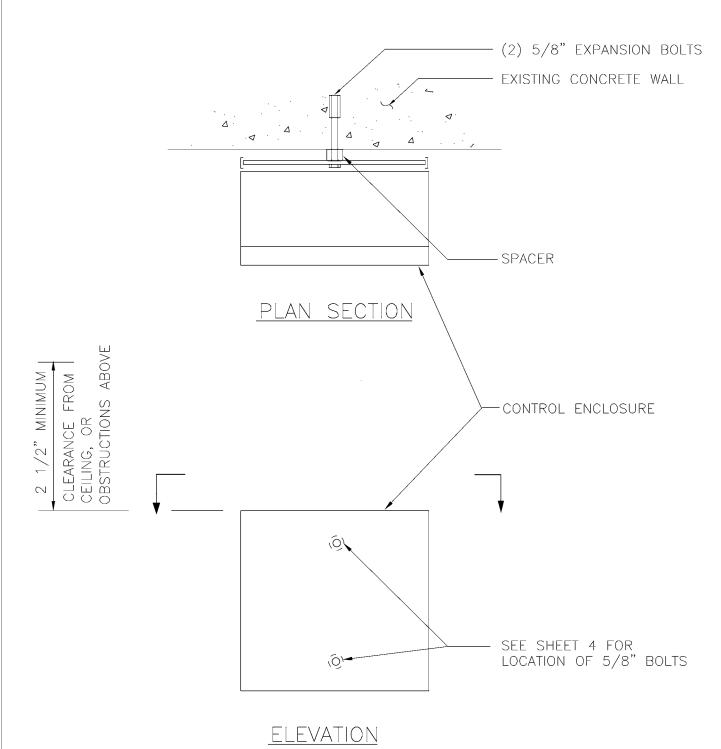

ELEVATION INSTALLATION ON EXISTING CONCRETE OR MASONRY WALL


1	DESIGNED	CHKD:	
	DPG	DOW	
1	DR:	SCALE:	
	CMS	NONE	
5	RECOM.	CONTRACT:	
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:	APPROVED		١,
			ŀ



DEPARTMENT OF TRANSPORTATION TROLLEY STANDARDS

FROG INDUCTION CONTROL SYSTEM

DATE:
OCT 95
FILE
DWG. NO.
SA-165
SHT 6 OF 6

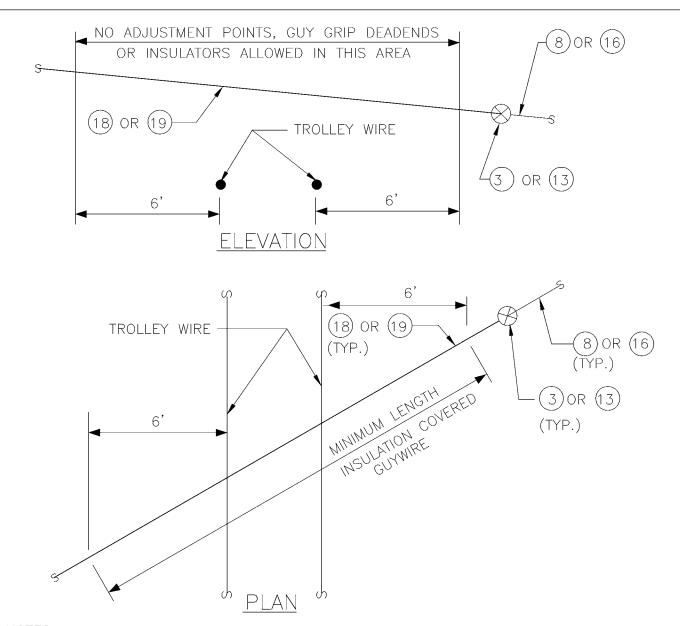

NOTES:

1. THE ENGINEER SHALL CONCUR WITH ANY EXCEPTIONS TO THESE CRITERIA.

	MATERIAL LIST				
ITEM #	TEM # QTY DESCRIPTION		MANUFACTURER	CAT. NO.	
03	VARIES	GUY STRAIN INSUL	PORCELAIN	504	
			PRODUCTS CO.		
80	VARIES	GUY STRAND	COPPERWELD	8M	
13	VARIES	GUY STRAIN INSUL	PORCELAIN	506	
			PRODUCTS CO.		
. 16	VARIES	GUY STRAND	COPPERWELD	16M	
18	VARIES	GUY STRAND, COVERED	COPPERWELD	8MI	
19	VARIES	GUY STRAND, COVERED	COPPERWELD	16MI	


V:\Library & Standards\Standards\Trolley\Details\SA-167.dwg, SA-167, 1/5/2007 12:20:10 PM DESIGNED CHKD: DOW DPG DR: SCALE: NONE TMB RECOM. CONTRACT: APPROVED



DEPARTMENT OF TRANSPORTATION TROLLEY STANDARDS

INSULATION COVERED GUY WIRE REQUIREMENT CRITERIA

OIVII
DATE:
OCT 95
FILE
DWG. NO.
SA-167
SHT 1 OF 1

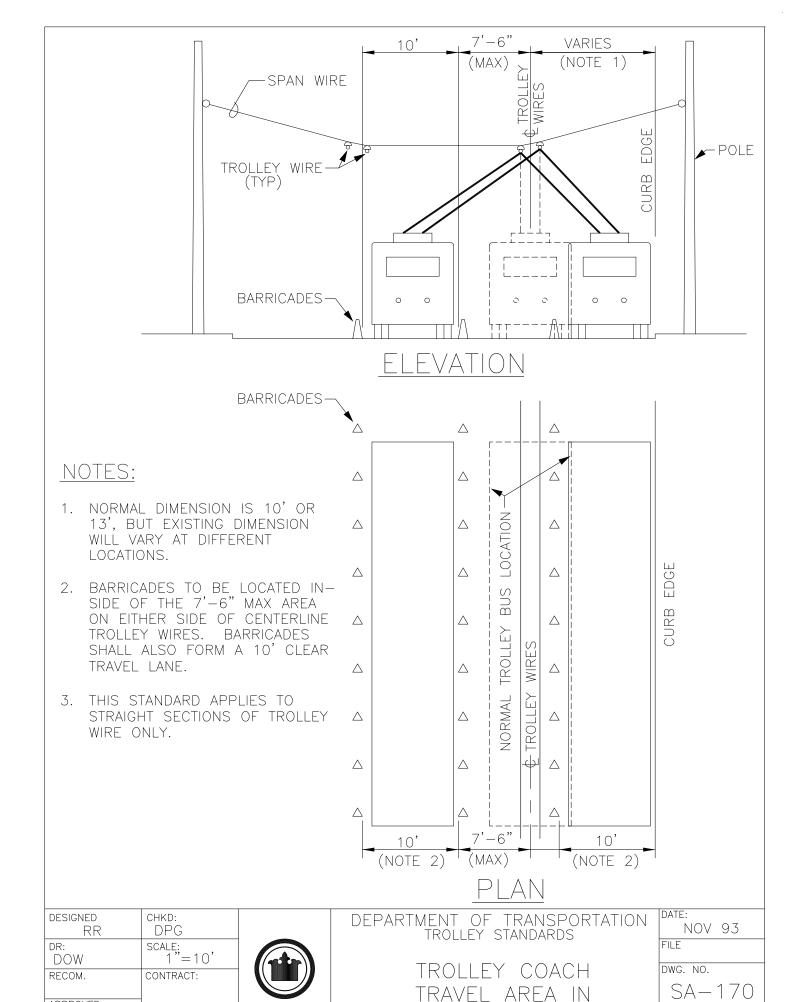


CONSTRUCTION ZONE


OF

APPROVED

King County

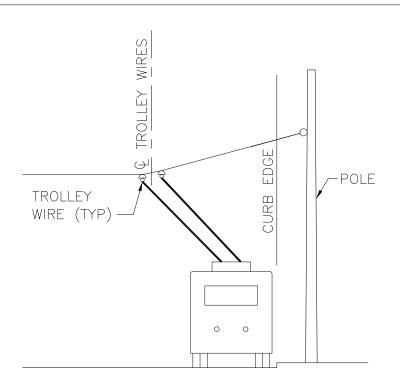

POLE SPAN SUPPORT

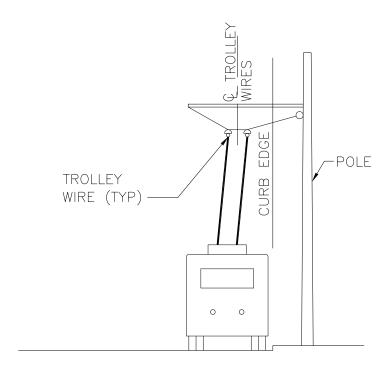

MAST ARM SUPPORT


DESIGNED AW	CHKD: AW
DR: BFB	SCALE; 1"=10'
RECOM.	CONTRACT:
APPROVED	



DEPARTMENT OF TRANSPORTATION TROLLEY STANDARDS

TROLLEY COACH ELEVATION VIEW WITH SPANS OR MAST ARM

DATE:
FEB 08
FILE
DWG. NO.
SA-171
SHT 1 OF 1

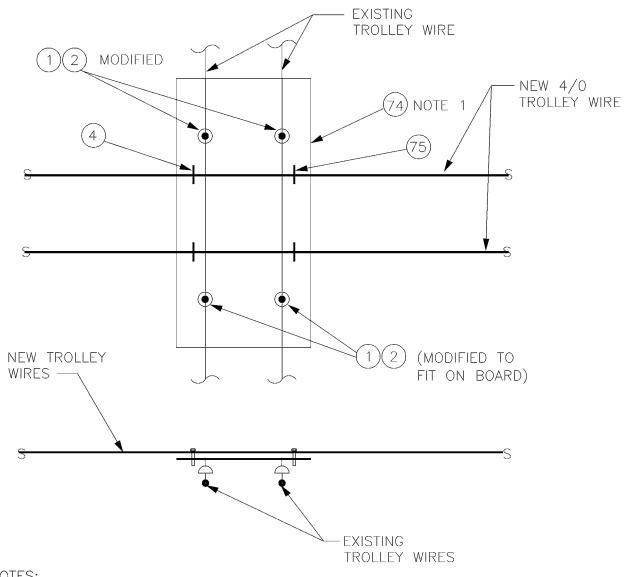

NOTES:

1. 4' x 8' SIZE IS A MINIMUM. USE 2 OR MORE WHEN REQUIRED.

MATERIAL LIST

U/ 12:20:23 PM	ITEM #	QTY	DESCRIPTION	MANUFACTURER	CAT. NO.
02/5/1	01	4	DETROIT CLAMP ASSY	WABCO	19293-3007
4-190,	02	4	AGC TANGENT SPAN HANGER	WABCO	19360-2000
λ Ser	74	1	4' X 8' X 1/2" EXTERIOR PLYWOOD		
). 130.	75	4	U BOLT, FOR 4/0 TROLLEY WIRE		


77 12:20:23 PM	ITEM #	QT	Y		
1/5/20	01	4		DET	ROI
١-190,	02	4		AGC) TA
Wg, S	74	1		4'	X 8
A-190.c	75	4		U E	30L
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tandards\	DR: TMB		SCALE:	: IONE	
ibrary & S	RECOM.		CONTR	ACT:	
V:\L	APPROVED				



DEPARTMENT OF TRANSPORTATION TROLLEY STANDARDS

TEMPORARY INSULATION BOARD

DATE:		
JUN	95	
FILE		
DWG. NO.		
SA-	19	0
SHT 1	OF	1

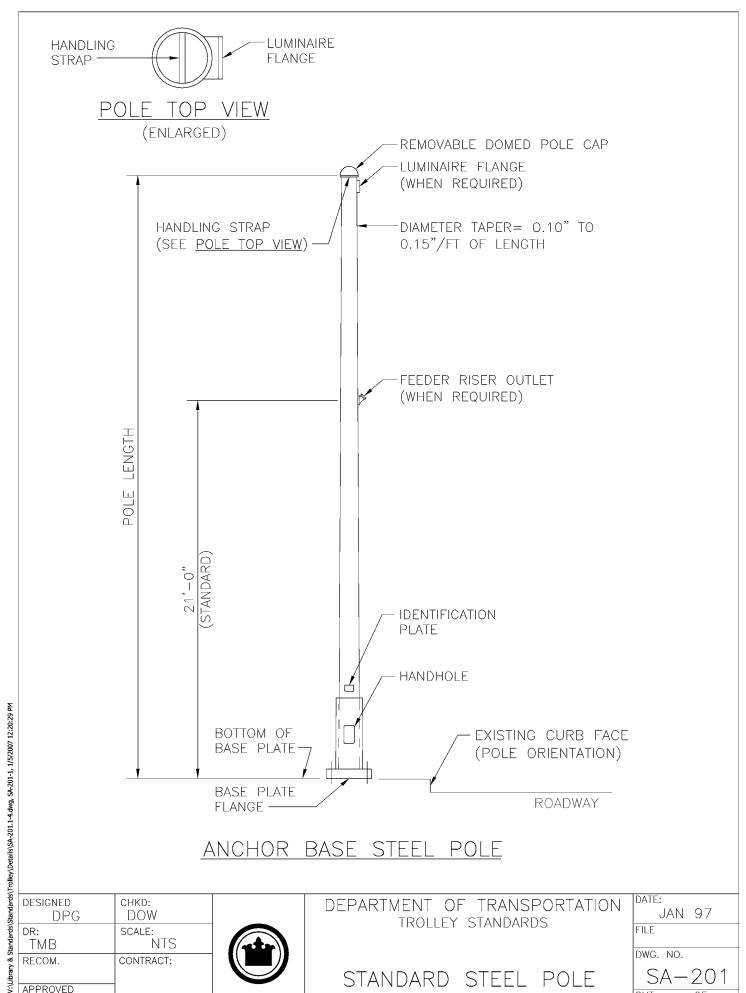

ANCHOR BASE STEEL POLE


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DEPARTMENT OF TRANSPORTATION TROLLEY STANDARDS

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EMBEDDED STEEL POLE

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POLE SCHEDULE OF ALLOWABLE LOADS

ALLOWABLE TROLLEY OVERHEAD LOADS ON POLES AT 60° F WITH TROLLEY WIRE TENSION = 2000 LB. (EQUIVALENT HORIZONTAL LOAD IS APPLIED AT 25 FT)

	ALLC	WABI	LE LOAD	S		REFE	REN	ICE DA	ГА
	POLE USE TOH/LIGH	I T	POLE US TOH/LIGHT/						
POLE TYPE	GROUND LINE MOMENT (LB-FT) (<u>NOTE 1</u>)	EQUIVALENT LOAD (LB)	GROUND LINE MOMENT (LB-FT) (NOTE 1,2)	EQUIVALENT LOAD (LB)	POLE STYLE	STANDARD LENGTH (FEET)	GRD LINE DIA (IN)	GROUND LINE YIELD MOMENT (LB-FT)	POLE FOUNDATION TYPE
SA-201H	40,000	1600	10,000	400)ED	35	12	100,000	SA-212B
SA-201K	80,000	3200	50,000	2000	EMBEDD		14	180,000	SA-212D
SA-201M	155,000	6200	125,000	5000	∏ ∑ ∭		15	330,000	SA-212F
SA-201V	40,000	1600	10,000	400	BASE	33.5	12	100,000	SA-213B
SA-201X	80,000	3200	50,000	2000			14	180,000	SA-213D
SA-201Z	155,000	6200	125,000	5000	T		15	330,000	SA-213F
SA-201ZZ	185,000	7400	155,000	6200	ANCHOR		15	390,000	SA-213F
SA-201V	40,000	1600	10,000	400	E BASE BASE	28.5	12	100,000	SA-213B
SA-201X	80,000	3200	50,000	2000	画化山		12	180,000	SA-213D
SA-201Y	125,000	5000	95,000	3800	CHO		12	270,000	SA-213F
SA-201Z	155,000	6200	125,000	5000	W/ ANG SEA		12	330,000	SA-213F

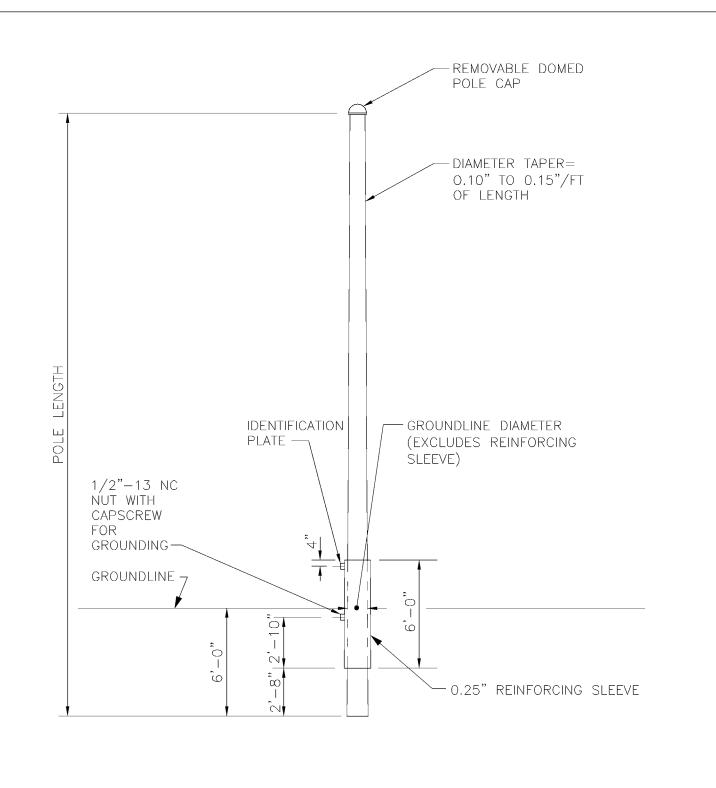NOTES

- 1. REDUCE ALLOWABLE LOADS FOR:
 - A. TROLLEY WIRE TENSION OF 1500# AT 60° F

10%

- B. FOR EACH ELECTRIC LINE, COMMUNICATION LINE, OR SERVICE DROP ATTACHED TO POLE EXCEPT AT DEAD ENDS AND ANGLES
- 5000 LB-FT (200 LB)
- C. DEAD ENDS, ANGLES, AND GUYS FOR ELECTRIC AND COMMUNICATION LINES AND SERVICE DROPS REQUIRE ADDITIONAL REDUCTIONS.
- 2. REDUCE ALLOWABLE LOADS FOR:
 - A. TRAFFIC SPAN WITH OVER 4 HEADS OR SIGNS FOR EACH ADDITIONAL HEAD OR SIGN

6000 LB-FT (240 LB)

B. 2 TRAFFIC SPANS AT 90° $\pm 10^\circ$ W/ OVER 5 HEADS OR SIGNS TOTAL FOR EACH ADDITIONAL HEAD OR SIGN

5000 LB-FT (200 LB)

C. TRAFFIC ARM WITH OVER 4 HEADS OR SIGNS FOR EACH ADDITIONAL HEAD OR SIGN

15000 LB-FT (600 LB)


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DEPARTMENT OF TRANSPORTATION TROLLEY STANDARDS

TROLLEY STANDARDS

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BASE PLATE FLANGE

BASE PLATE FLANGE DIMENSIONS					
(INCHES)					
POLE	PLATE	PLATE	BOLT	HOLE	
TYPE	WIDTH	THICKNESS	CIRCLE	DIA	
	(A)	(B)	(C)	(D)	
	BASE ST	YLE: STAND	ARD		
SA-201-V	18x18	1¾	18	21/16	
SA-201-X	20×20	2	20	25/16	
SA-201-Z	23x23	21/2	22	2 ¹ 3/16	
SA-201-ZZ	23x23	21/2	22	2 ¹ 3/ ₁₆	
В	ASE STYL	E: CHIEF SI	EATTLE		
SA-201-V	23×23	13/4	18	21/16	
SA-201-X	23×23	2	20	25/16	
SA-201-Y	23×23	21/4	22	2 ¹³ / ₁₆	
SA-201-Z	23×23	21/2	22	2 ¹ 3/16	

GENERAL NOTES

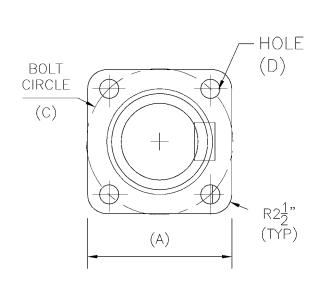1. <u>INSTALLATION:</u>

- A. <u>HANDLING</u> OF POLES SHALL BE DONE ONLY BY THE ANCHOR BOLT HOLES IN THE BASE PLATE, THE HANDLING STRAP AT THE POLE TOP, OR A PAD—EYE BOLTED TO THE POLE TOP PLATE.
- B. <u>POLES SHALL BE STORED AND TRANSPORTED</u> HORIZONTALLY, SUPPORTED BY THE BASE PLATES, AND WITH A NEW SCRAP OF CARPETING WITHIN THE TOP FOOT OF THE POLE.
- C. <u>ZINC REPAIR PAINT</u> SHALL BE AS SPECIFIED IN SECTION 05121 OF THIS CONTRACT.
- D. <u>Galvanizing repair compound</u> shall be as specified in section 05121 of this contract.

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15° ROOF TO SLOPE AT RIGHT ANGLE WITH BUTT GAIN

NOTES

- 1. POLE SHALL BE CLASS 1, WESTERN RED CEDAR, PER ANSI 05.1-LATEST EDITION.
- METAL TAGS AND NAILS FOR BURN BRAND ARE NOT ALLOWED. 2.

V:\Library & Standards\Standards\Trolley\Details\SA-202-202A.dwg, SA-202, 1/5/2007 12:20:54 PM	<u>NOTE:</u> 1. 2.	POLE	SHALL NL TAGS		n.
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DEPARTMENT OF TRANSPORTATION TROLLEY STANDARDS

WOOD POLE FRAMING DETAILS

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BUTT GAIN NOTCH 2" X 1/2" DEEP

- POLE SHALL BE CLASS 1, WESTERN RED CEDAR OR DOUGLAS FIR,

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DEPARTMENT OF TRANSPORTATION TROLLEY STANDARDS

WOOD POLE FRAMING DETAILS

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SHT 1 OF 1

15° ROOF TO SLOPE AT RIGHT ANGLE WITH BUTT GAIN

12'-6"

POLE FACE


DETAILS FOR SHTS 2,3 & 4												
FOUNDATION TYPE		DIME	NSI	ONS	Ò	REBAR QUANTITIES						
	(LB-FT)	Α	Р	G	В	D	R*	Т	V	W	Υ	Z
SA-211B	40,000	2'-4"	9"	6.5"	2.5"	8'-6"	8-#8	4-#7	6-#7	6-#7	#4@6"	4-#7
SA-211D	80,000	2'-8"	10"	7"	3"	10'-6"	12-#8	4-#8	6-#8	6-#8	#5@5"	4-#8
SA-211F	155,000	3'-0"	11.5"	8"	3.5"	13'-0"	12-#8	4-#8	6-#8	6-#8	#5@4"	4-#8

* ADD (1) #8 VERTICAL FOR GROUNDING



- EXISTING CURB

ANCHOR BOLT TO CURB ORIENTATION DOES NOT ROTATE.

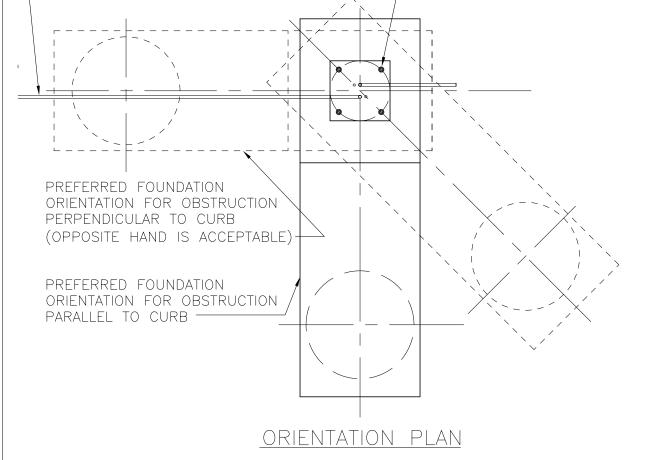



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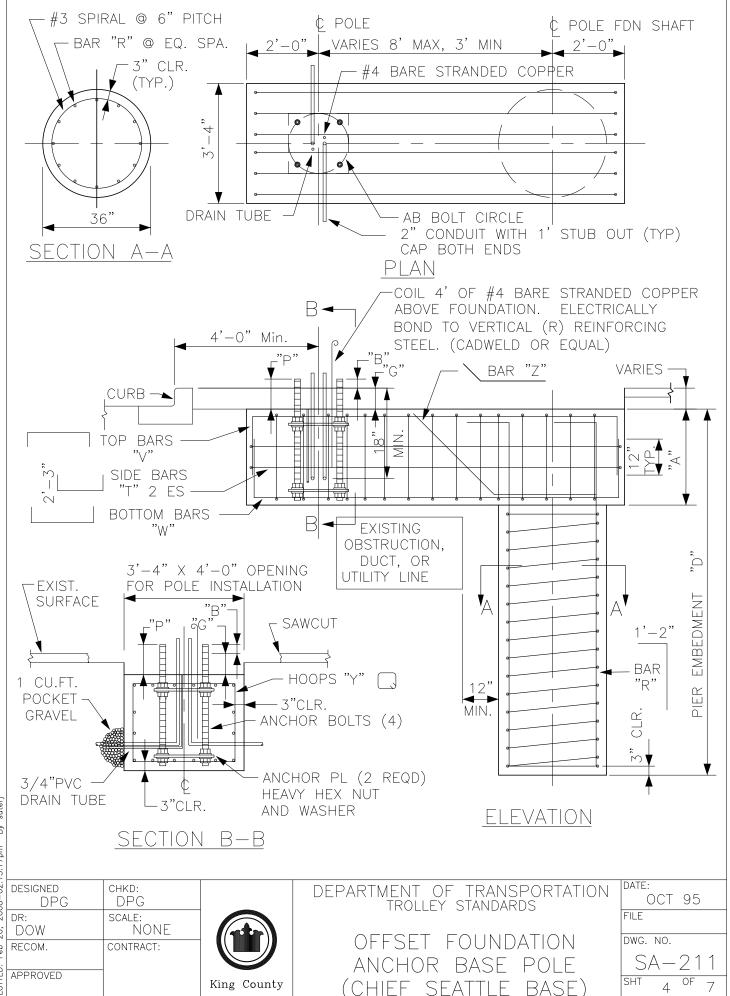


DEPARTMENT OF TRANSPORTATION TROLLEY STANDARDS


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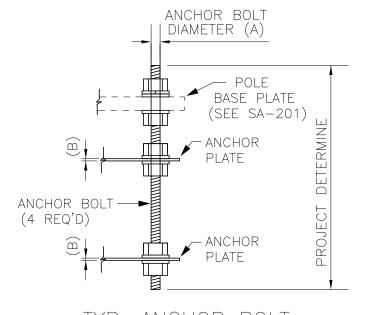


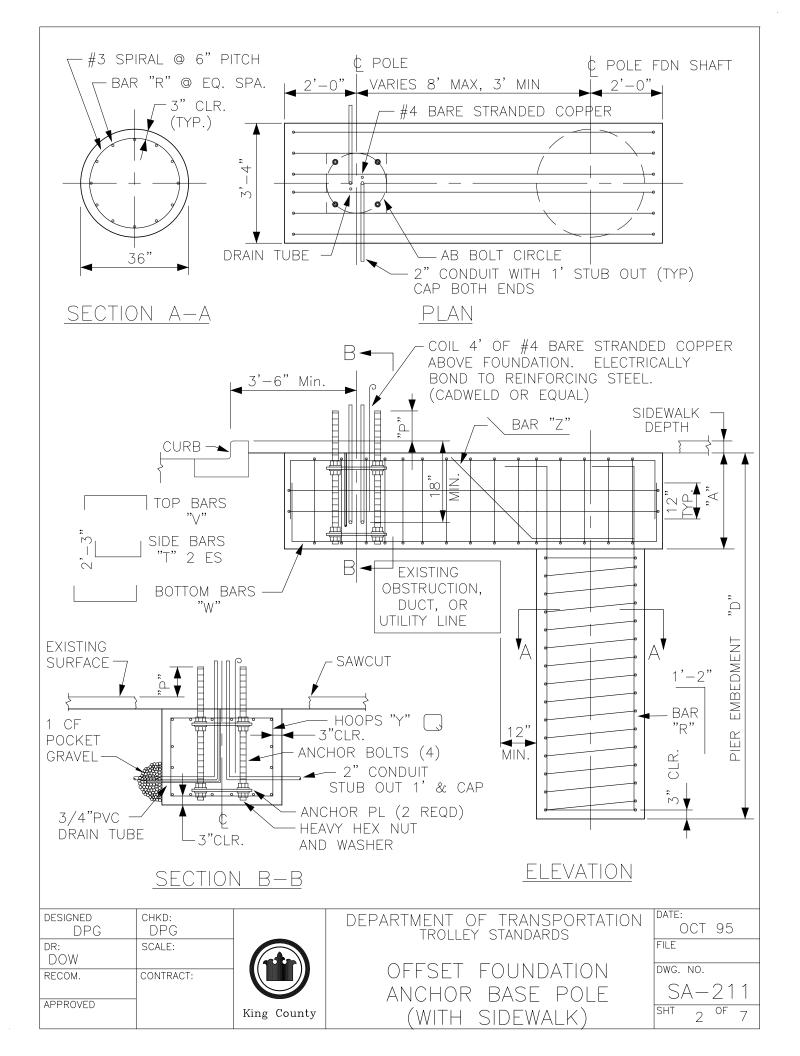

ANCHOR BOLT ANCHOR PLATE DIMENSIONS (INCHES)							
FOUNDATION TYPE	DIAM. (INCHES) (A)	PLATE THICK. (B)	PLATE WIDTH (C)	BOLT HOLE (D)	CENTER HOLE (E)	CORNER RADIUS (F)	BOLT CIRCLE (G)
SA-211B	1 3/4	3/8	16 X 16	I 7/8	12 1/2	I 5/8	18
SA-211D	2	3/8	18 X 18	2 1/8	14	2	20
SA-211F	2 1/2	1/2	20 X 20	2 5/8	15	2 1/4	22

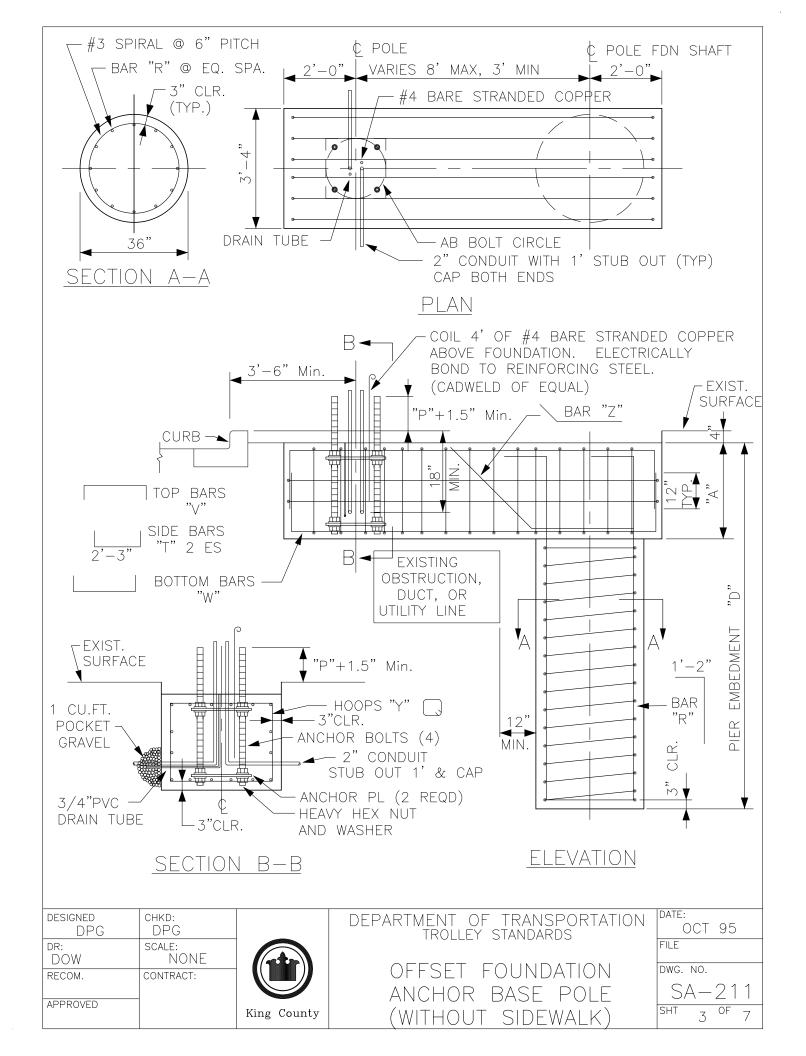

ANCHOR PLATE
DETAIL

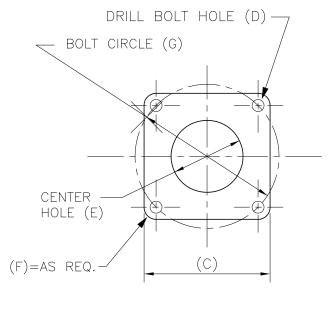

TYP. ANCHOR BOLT

COMPLETE WITH 6 NUTS
6 FLAT WASHERS & 1 LOCK WASHER

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DEPARTMENT OF TRANSPORTATION TROLLEY STANDARDS

DATE:
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DWG. NO.
SA-211
SHT 5 OF 7

GENERAL NOTES

1. CONCRETE AND REINFORCING STEEL

- 1.1 All work shall be done per City of Seattle Board of Public Works Rules: Chapter 40.4 — Street and Sidewalk Pavement Opening and Restoration Rules if in Street Right Of Way.
- 1.2 Concrete shall be City of Seattle Class AX air entrained, 3/4" max aggregate, and with a minimum compressive strength of 4000 PSI at 28 days.
- 1.3 All reinforcing bars shall be deformed billet steel conforming to ASTM A615 Grade 60.
- 1.4 Minimum clear concrete cover shall be 3 inches.
- 1.5 Reinforcing details and fabrication shall be as recommended in ACI 315 "Details & Detailing of Concrete Reinforcement."
- 1.6 No construction joints shall be permitted.

2. ANCHOR PLATES, BOLTS, NUTS AND WASHERS

- 2.1 Anchor bolts including nuts and flat washers shall conform to ASTM F1554-99 Grade 105 class 2a including supplementary requirements S2, S3, and S5. Threads shall conform to the ANSI Standard B1.1 for UNC thread. Anchor bolts shall have 36 inches of thread on exposed end and 12 inches of thread on the embedded end, or shall be fully threaded.
- 2.2 Anchor plates shall conform to ASTM A36.

3. GALVANIZING

3.1 Anchor plates, anchor bolts, anchor bolt nuts and washers shall be hot—dip galvanized in conformance to ASTM A153 or ASTM A123.

4. SOIL

4.1 Embedment depth is adequate for three times the working moment in cohesive soils of c=1000PSF and \emptyset =0° or better and cohesionless soils of c=0PSF and \emptyset =26° or better.

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GENERAL NOTES

4.2 Embedment depth is adequate for three times the working moment in cohesive soils of c=1000PSF and \emptyset =0° or better and cohesionless soils of c=0PSF and \emptyset =26° or better.

5. <u>SUBMITTALS</u>

- 5.1 Reinforcing steel shop drawings and certificate of compliance.
- 5.2 Concrete mix proportions, admixtures and slump.
- 5.3 Anchor plate, anchor bolt, anchor bolt nuts and washers certificates of compliance.
- 5.4 A test report shall be provided in accordance with ASTM F1554—99 and supplementary requirements.

6. <u>INSPECTION</u>

6.1 Concrete shall not be placed until the Engineer has inspected the excavation, the grounding, the anchor bolts, and the placement of the reinforcing bar cage.

7. ANCHOR BOLT SETTING

- 7.1 Cover exposed anchor bolt threads and nuts with at least 3 layers of plastic tape before placing concrete.
- 7.2 Anchor bolt template shall by used temporarily at the top of anchor bolts for accurate positioning and aligning.

8. CONDUIT

8.1 Conduit from foundation shall be schedule 80 PVC. Conduit bends shall have a minimum radius of 12".


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DEPARTMENT OF TRANSPORTATION TROLLEY STANDARDS

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EMBEDDED FOUNDATION SCHEDULE								
FOUNDATION	NORMAL WORKING	PIER EMBEDMENT	REBAR REG	UIREMENTS				
TYPE	MOMENT (LB-FT)	DEPTH (D) (FEET)	VERTICAL	SPIRAL TIES				
SA-212-B	40,000	8.5	8-#8	#3 @ 6"				
SA-212-D	80,000	10.5	12-#8	#3 @ 6"				
SA-212-F	155,000	13	12-#8	#3 @ 6"				



INCLINED CONDITION & CONE DETAIL

REBAR NOT SHOWN FOR CLARITY
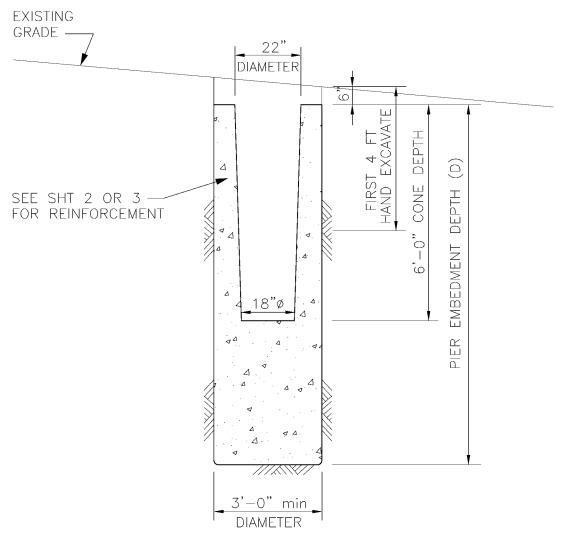
<u>NOTES</u>

1. SEE SHEET 4 FOR GENERAL NOTES.


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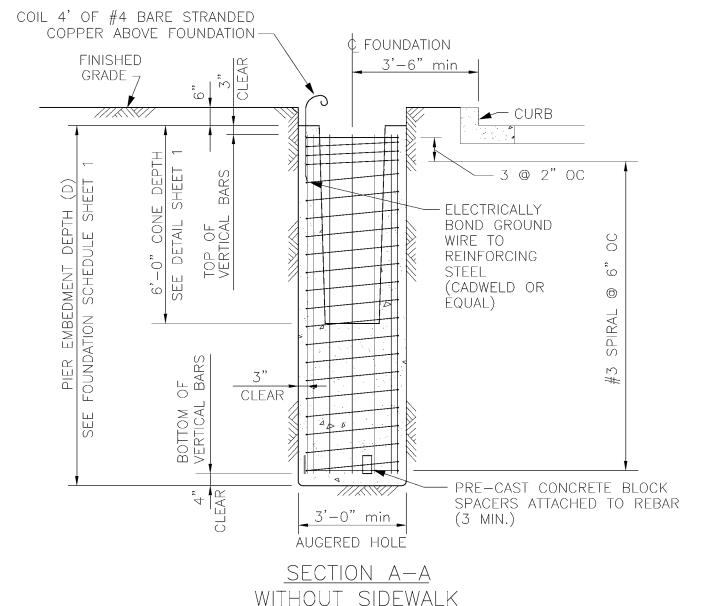


METRO TRANSIT DIVISION TROLLEY STANDARDS EMBEDDED STEEL POLE FOUNDATION

STANDARD FOUNDATION

DATE: JULY 2006	<u>5</u>
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NOTES

SEE SHEET 4 FOR GENERAL NOTES.

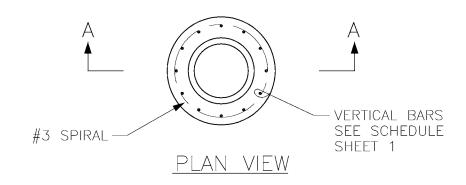
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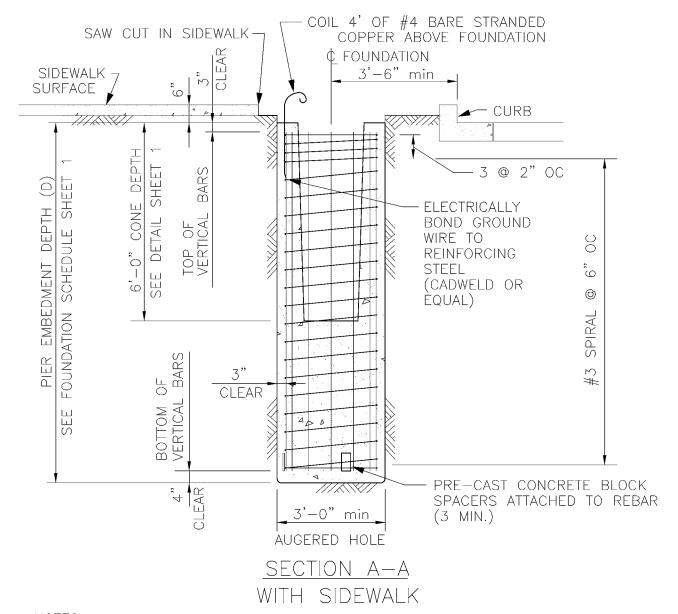


METRO TRANSIT DIVISION TROLLEY STANDARDS EMBEDDED STEEL POLE FOUNDATION

STANDARD FOUNDATION

DATE: JULY 2006
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METRO TRANSIT DIVISION TROLLEY STANDARDS EMBEDDED STEEL POLE FOUNDATION

STANDARD FOUNDATION

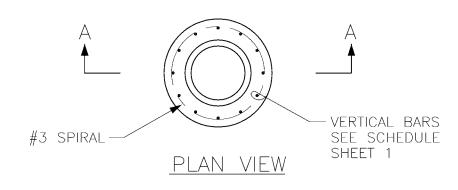DATE:	
JULY	2006
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DWG. NO.	
SA-	212
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1. CONCRETE

- 1.1 All work shall be done per City of Seattle Board of Public Works Rules: Chapter 40.4 — Street and Sidewalk Pavement Opening and Restoration Rules if in Street Right Of Way.
- 1.2 Concrete shall be City of Seattle Class AX air entrained, 3/4" max aggregate, and with a minimum compressive strength of 4000 PSI at 28 days.
- 1.3 All reinforcing bars shall be deformed billet steel conforming to ASTM A615 Grade 60.
- 1.4 Minimum clear concrete cover shall be 3 inches.
- 1.5 Reinforcing details and fabrication shall be as recommended in ACI 315 "Details & Detailing of Concrete Reinforcement."
- 1.6 No construction joints shall be permitted.

2. SOIL

- 2.1 Embedment depth is based upon research report numbers 105-1, 105-2 Resistance of a drilled shaft footing to overturning loads by Texas Transportation Institute, 1968.
- 2.2 Embedment depth is adequate for three times the working moment in cohesive soils of c=1000PSF and \emptyset =0° or better and cohesionless soils of c=0PSF and \emptyset =26° or better.

3. <u>SUBMITTALS</u>

- 3.1 Reinforcing steel shop drawings and certificate of compliance.
- 3.2 Concrete mix proportions, admixtures and slump.

4. INSPECTION

4.1 Concrete shall not be placed until the Engineer has inspected the excavation, the grounding, the cone, and the placement of the reinforcing bar cage.

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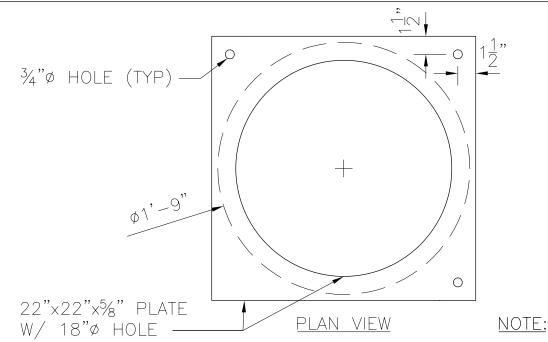


METRO TRANSIT DIVISION TROLLEY STANDARDS EMBEDDED STEEL POLE FOUNDATION


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SA-212 SHT 4 OF 6



ALL MATERIAL SHALL BE ASTM A36.



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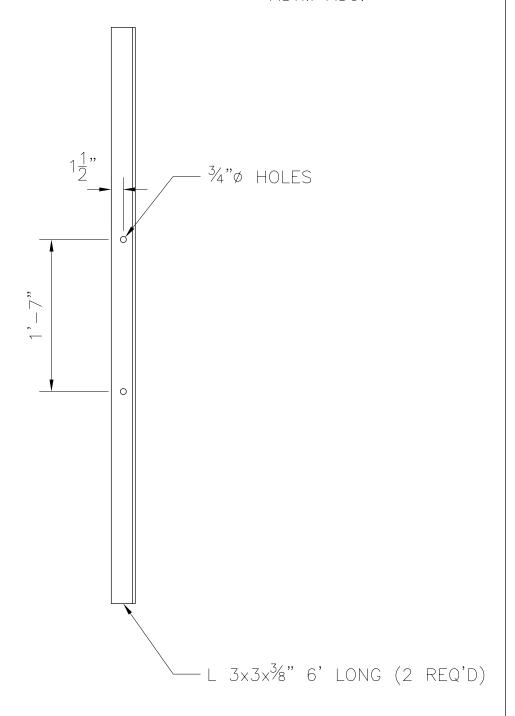
METRO TRANSIT DIVISION TROLLEY STANDARDS EMBEDDED STEEL POLE FOUNDATION

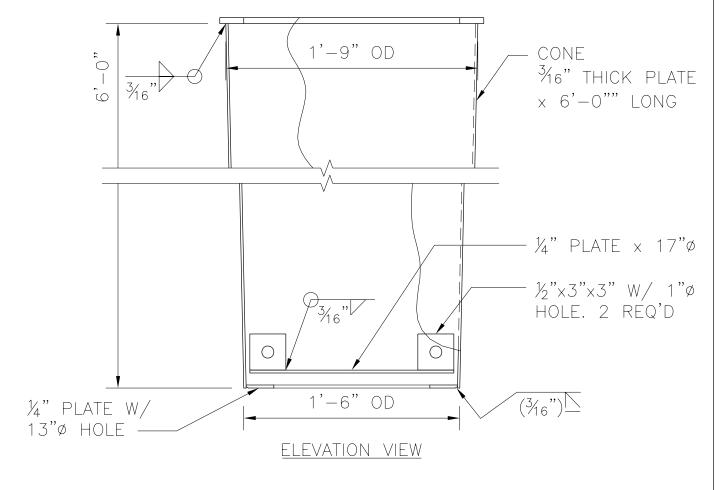INTERIOR CONE FORM FOR SA-212

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NOTE:

MATERIAL SHALL BE ASTM A36.




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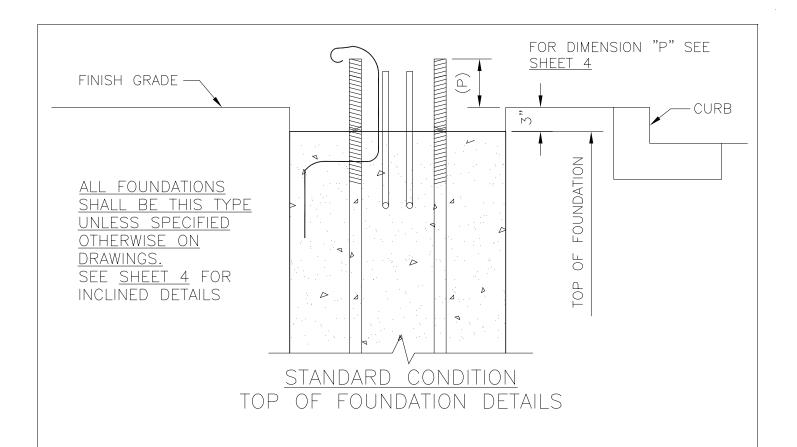



METRO TRANSIT DIVISION TROLLEY STANDARDS EMBEDDED STEEL POLE FOUNDATION

INTERIOR CONE FORM FOR SA-212

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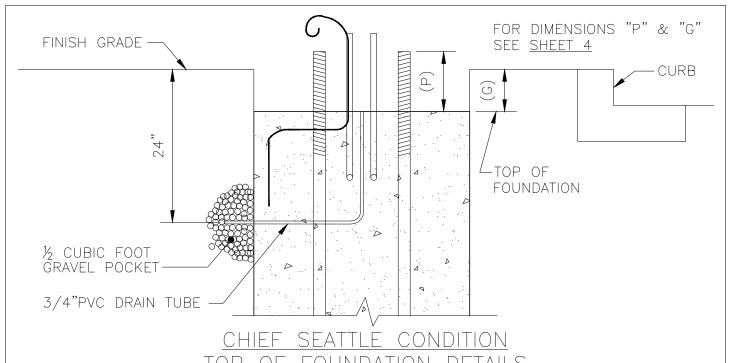
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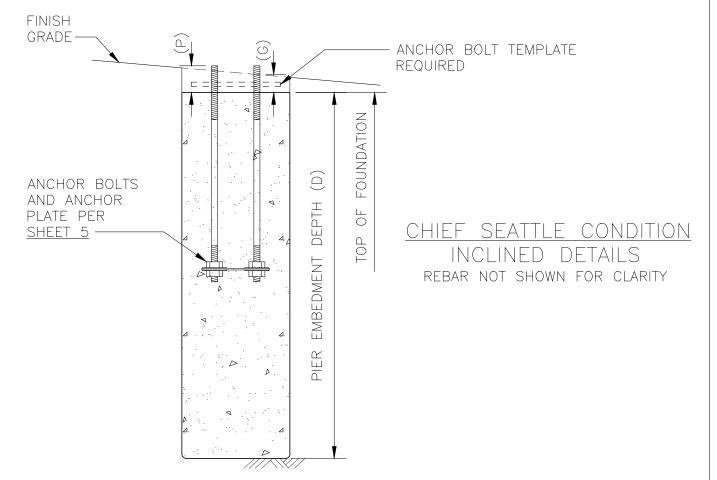
STANDARD FOUNDATION (ANCHOR BASE STEEL POLE)

DATE: JULY	2012
FILE	2012

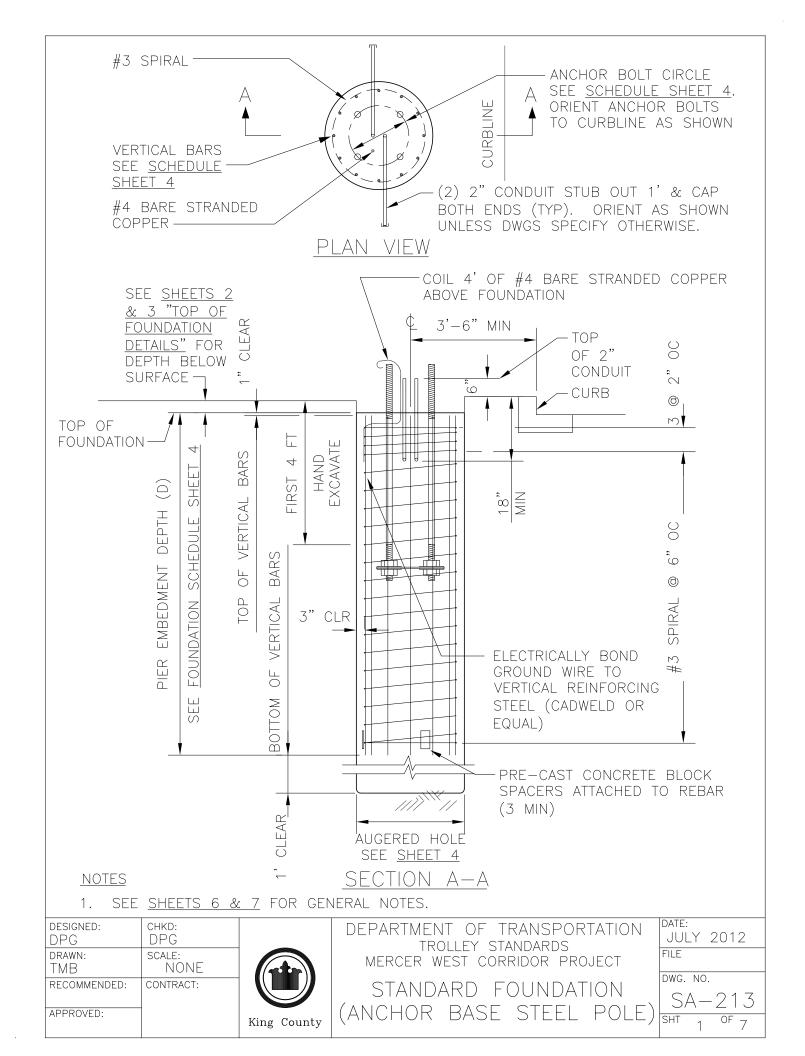DWG. NO.

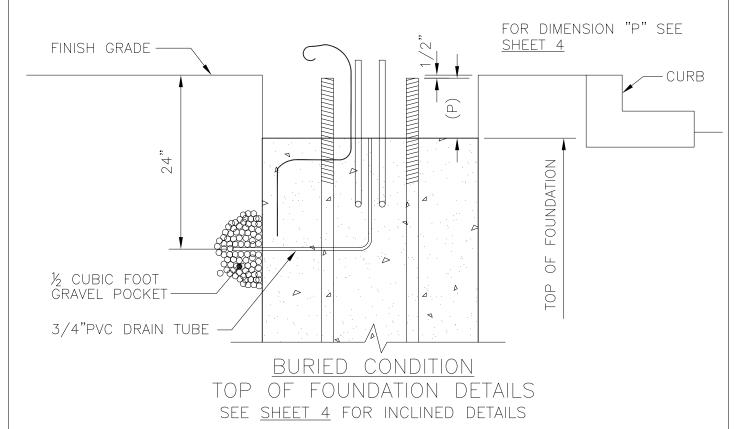

FOUNDATION USE ONLY WHERE NOTED ON DRAWINGS



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DEPARTMENT OF TRANSPORTATION TROLLEY STANDARDS


STANDARD FOUNDATION (ANCHOR BASE STEEL POLE)


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ANCHOR BASE FOUNDATION SCHEDULE									
FOUNDATION TYPE	POLE My STANDARD/ MAXIMUM	PII EMBEI DEPTI	DMENT	PIER DIAMETER		EBAR REMENTS	BOLT CIRCLE INCHOR	BOLT PROJ NCHOR	ONLY CHIEF EATTLE
	(KIP-FT)	4 BLOWS PER FT	2 BLOWS PER FT	(FEET)	VERTICAL*	CONTINUOUS TIES			"G"
SA-213-A	110/180	9	14	3'-0"	8-#8	#3	15"	8.5"	6"
SA-213-B	110/180	9	14	3'-0"	8-#8	#3	18"	9"	6.5"
SA-213-D	180/270	10.5	16	3'-0"	12-#8	#3	20"	10"	7"
SA-213-F	330/400	13	19	3'-0"	12-#9	#3	22"	11.5"	8"
SA-213-H	600/600	15.5	21	3'-6"	14-#9	#3	24"	12"	8½"

*ADD (1) #8 VERTICAL FOR GROUNDING



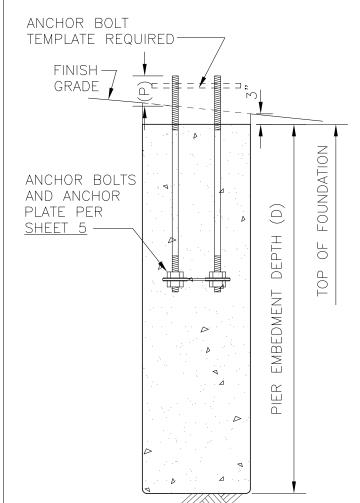

STANDARD CONDITION
INCLINED DETAILS
REBAR NOT SHOWN FOR CLARITY

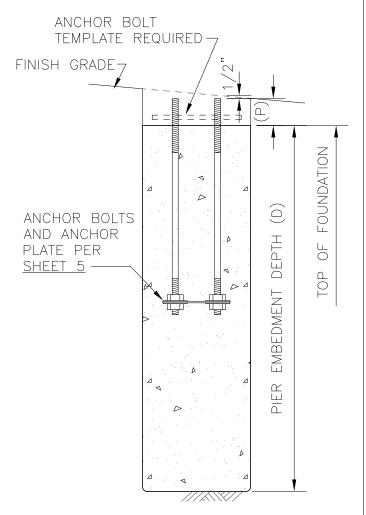BURIED CONDITION
INCLINED DETAILS
REBAR NOT SHOWN FOR CLARITY

DESIGNED:	CHKD:
DPG	DPG
DRAWN:	scale:
BFB/LSA	NONE
RECOMMENDED:	CONTRACT:
APPROVED:	




DEPARTMENT OF TRANSPORTATION TROLLEY STANDARDS MERCER WEST CORRIDOR PROJECT

STANDARD FOUNDATION (ANCHOR BASE STEEL POLE)

DATE:
JULY 2012
FILE
DWO NO


SA-213

	ANCHOR BOLT		ANC	hor plate (inch	E DIMENSIC HES)	NS	
FOUNDATION TYPE	DIAMETER (INCHES) (A)	PLATE THICKNESS (B)	PLATE WIDTH (C)	BOLT HOLE (D)	CENTER HOLE (E)	CORNER RADIUS (F)	BOLT CIRCLE (G)
			16				
SA-213-A	1 1/2	3/8	X	1 5/8	10 1/2	1 1/2	15
			16				
			16				
SA-213-B	1 3/4	3/8	Χ	1 7/8	12 1/2	1 5/8	18
			16				
		3/8	18				
SA-213-D	2	,	X	2 1/8	14	2	20
			18				
			20				
SA-213-F	2 1/2	3/8	X	2 5/8	15	2 1/4	22
			20				
			22				
SA-213-H	2 3/4	1/2	X	2 7/8	16.5	2 1/2	24
			22				

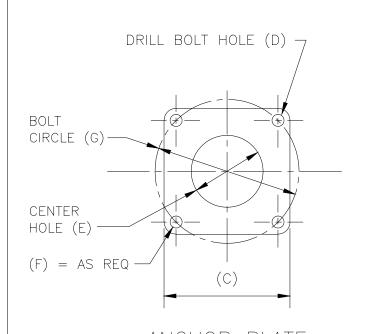

<u>anchor plate</u> <u>detail</u>

SEE GENERAL NOTES SHEETS 6 & 7

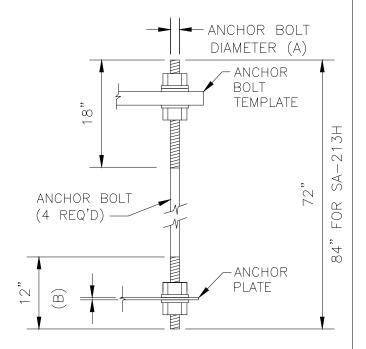

TYPICAL ANCHOR BOLT COMPLETE WITH 4 NUTS 4 FLAT WASHERS & 1 LOCK WASHER. SEE GENERAL NOTES/SHEETS 6 & 7

DESIGNED: DPG	CHKD: DPG
DRAWN: TMB/LSA	scale: NTS
RECOMMENDED:	CONTRACT:
APPROVED:	



DEPARTMENT OF TRANSPORTATION
TROLLEY STANDARDS

STANDARD FOUNDATION (ANCHOR BASE STEEL POLE)

DATE:			
AF	ìR	201	2
FILE			
DWG.	NO.		
SA	/ —	21	3
SHT		OF	7

GENERAL NOTES

1. CONCRETE AND REINFORCING STEEL

- 1.1 All work shall be done per <u>Seattle Sidewalk and Street Paving and Restoration</u> <u>Rules and Regulations</u> if in Street Right Of Way.
- 1.2 Concrete shall be City of Seattle Class AX air entrained, 3/4" max aggregate, and with a minimum compressive strength of 4000 PSI at 28 days.
- 1.3 All reinforcing bars shall be deformed billet steel conforming to ASTM A615 Grade 60.
- 1.4 Minimum clear concrete cover shall be 3" from sides and bottom and 1" from the top
- 1.5 Reinforcing details and fabrication shall be as recommended in ACI 315 "Details & Detailing of Concrete Reinforcement."
- 1.6 No construction joints shall be permitted.

2. ANCHOR PLATES, BOLTS, NUTS AND WASHERS

- 2.1 Anchor bolts including nuts and flat washers shall conform to ASTM F1554—99 Grade 105 Class 2A including supplementary requirements S2, S3 and S5. Threads shall conform to the ANSI Standard B1.1 for UNC thread. Anchor bolts shall have 18 inches of thread on exposed end and 12 inches of thread on the embedded end.
- 2.2 Anchor plates shall conform to ASTM A36.

3. GALVANIZING

3.1 Anchor plates, anchor bolts, anchor bolt nuts and washers shall be hot—dip galvanized in conformance to ASTM A153 or ASTM A123.

4. SOIL

4.1 <u>Embedment depth</u> is adequate for three times the working moment in cohesive soils of c=1000PSF and \emptyset =0° or better and cohesionless soils of c=0PSF and \emptyset =26° or better.

5. <u>SUBMITTALS</u>

- 5.1 Reinforcing steel shop drawings and certificate of compliance.
- 5.2 Concrete mix proportions, admixtures and slump.
- 5.3 Anchor plate, anchor bolt, anchor bolt nuts and washers certificates of compliance.
- 5.4 A test report shall be provided in accordance with ASTM F1554—99 and supplementary requirements.

(continued, sheet 7 of 7)

designed: DPG	CHKD: DPG	
drawn: BFB/LSA	scale: NONE	
RECOMMENDED:	CONTRACT:	
APPROVED:		



DEPARTMENT OF TRANSPORTATION
TROLLEY STANDARDS
MERCER WEST CORRIDOR PROJECT
STANDARD FOUNDATION

FILE DWG. NO. SA-213

JULY 2012

DATE:

(ANCHOR BASE STEEL POLE)

GENERAL NOTES

(continued from sheet 6 of 7)

6. INSPECTION

6.1 Concrete shall not be placed until the King County Project Representative has inspected the excavation, the grounding, the anchor bolts, and the placement of the reinforcing bar cage.

7. ANCHOR BOLT SETTING

- 7.1 Cover exposed anchor bolt threads and nuts with at least 3 layers of plastic tape before placing concrete.
- 7.2 Anchor bolt template shall by used temporarily at the top of anchor bolts for accurate positioning and aligning.
- 7.3 Anchor bolts shall not exceed $\frac{1}{8}$ " from vertical over the entire length of bolt upon completion of foundation.

8. CONDUIT

8.1 Conduit from foundation shall be schedule 80 PVC. Conduit bends shall have a minimum radius of 12".

DESIGNED:	CHKD: DPG
DRAWN: DOW/LSA	scale: NONE
RECOMMENDED:	CONTRACT:
APPROVED:	1



DEPARTMENT OF TRANSPORTATION
TROLLEY STANDARDS


STANDARD FOUNDATION (ANCHOR BASE STEEL POLE)

DATE:	
APR	2012
FILE	

DWG. NO.

SA - 213

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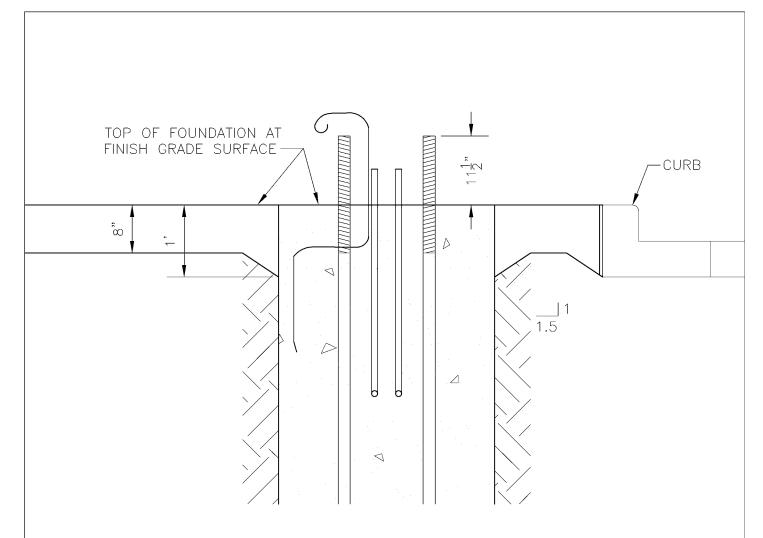
(ANCHOR BASE STEEL POLE)

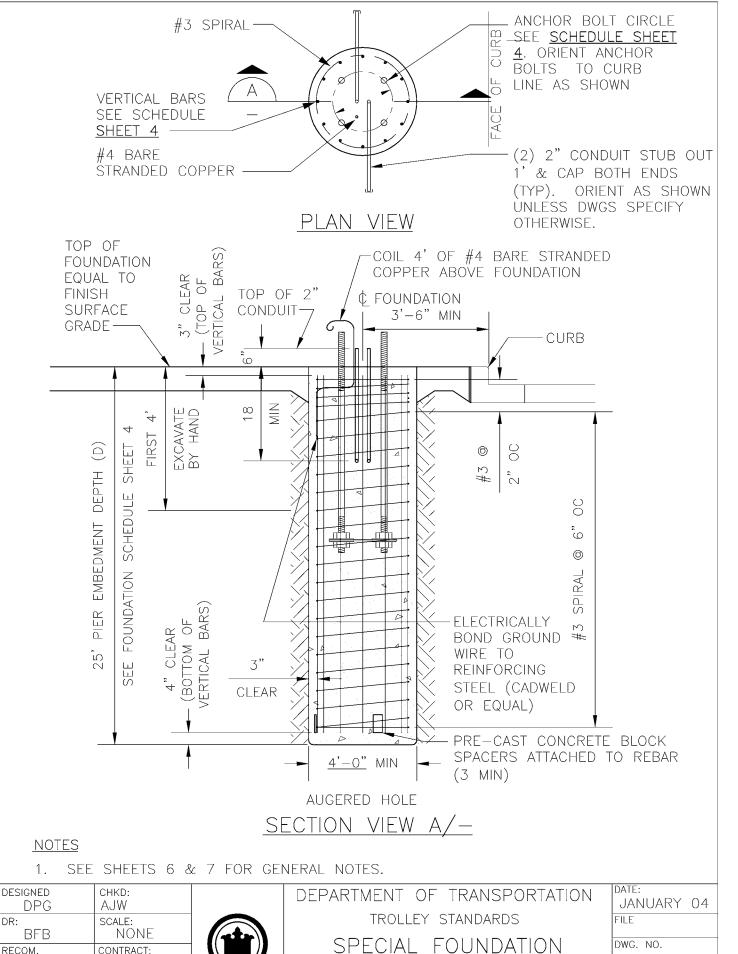SA - 213(S)

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CONTRACT:

King County



<u>TYPICAL</u> <u>TOP OF POLE FOUNDATION</u>

DETAIL

SCALE: 3/4" = 1'-0"

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DEPARTMENT OF TRANSPORTATION TROLLEY STANDARDS

SPECIAL FOUNDATION FOR ANCHOR BASE STEEL POLE

DATE:	
JANUARY 04	_
FILE	
2006	_
DWG. NO.	
SA-213(S	٠
SHT o OF 7	
9 9 /	

ANCHOR BASE FOUNDATION SCHEDULE						
FOUNDATION TYPE	GROUND LINE Mö (LB-FT)	PIER EMBEDMENT DEPTH (D) (FEET)		EBAR REMENTS CONTINUOUS TIES	ANCHOR BOLT CIRCLE	ANCHOR J. BOLT PROJ.
SA-213-(S)	480,000	25	16-#9	#3	22"	11.5"

DESIGNED	CHKD:	
DPG		
DR:	SCALE:	
AJW	NONE	
RECOM.	CONTRACT:	
APPROVED		




DEPARTMENT OF TRANSPORTATION TROLLEY STANDARDS


ANCHOR BASE FOUNDATION SCHEDULE

	DATE:	
	JANUARY	04
	FILE	
1	DWG. NO.	

SA-213(S)
SHT 4 OF 7

	ANCHOR BOLT		ANC	hor plate (inch	E DIMENSIC HES)	NS				
FOUNDATION TYPE	DIAM. (INCHES) (A)	PLATE THICK. (B)	PLATE WIDTH (C)	BOLT HOLE (D)	CENTER HOLE (E)	CORNER RADIUS (F)	BOLT CIRCLE (G)			
SA-213-(S)	2 1/2	1/2	20 X 20	2 5/8	15	2 1/4	22			

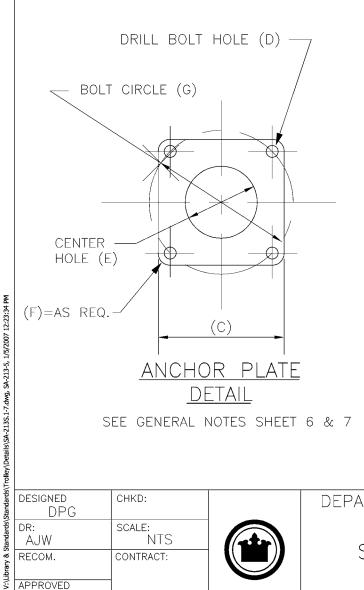

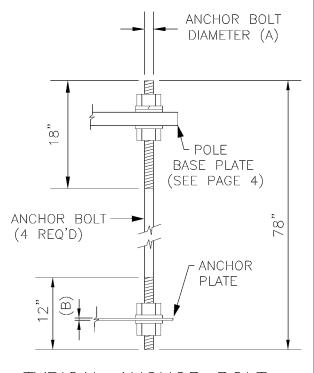

COMPLETE WITH 4 NUTS 4 FLAT WASHERS & 1 LOCK WASHER SEE GENERAL NOTES SHEET 6 & 7

DESIGNED	CHKD:	
DPG		
DR:	SCALE:	
WLA	NTS	
RECOM.	CONTRACT:	
APPROVED		



DEPARTMENT OF TRANSPORTATION TROLLEY STANDARDS

SPECIAL FOUNDATION (ANCHOR BASE STEEL POLE)

DATE:
JANUARY 04
FILE
DWG. NO.
SA-213(S)
SHT 5 OF 7

GENERAL NOTES

1. CONCRETE AND REINFORCING STEEL

- 1.1 All work shall be done per City of Seattle Board of Public Works Rules: Chapter 40.4 — Street and Sidewalk Pavement Opening and Restoration Rules if in Street Right Of Way.
- 1.2 Concrete shall be City of Seattle Class AX air entrained, 3/4" max aggregate, and with a minimum compressive strength of 4000 PSI at 28 days.
- 1.3 All reinforcing bars shall be deformed billet steel conforming to ASTM A615 Grade 60.
- 1.4 Minimum clear concrete cover shall be 3 inches.
- 1.5 Reinforcing details and fabrication shall be as recommended in ACI 315 "Details & Detailing of Concrete Reinforcement."
- 1.6 No construction joints shall be permitted.

2. ANCHOR PLATES, BOLTS, NUTS AND WASHERS

- 2.1 Anchor bolts including nuts and flat washers shall conform to ASTM F1554-99 Grade 105 Class 2A including supplementary requirements S2,S3,and S5. Threads shall conform to the ANSI Standard B1.1 for UNC thread. Anchor bolts shall have 18 inches of thread on exposed end and 12 inches of thread on the embedded end.
- 2.2 Anchor plates shall conform to ASTM A36.

3. **GALVANIZING**

3.1 <u>Anchor plates, anchor bolts, anchor bolt nuts and washers</u> shall be hot—dip galvanized in conformance to ASTM A153 or ASTM A123.

	DESIGNED	CHKD:	
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DEPARTMENT OF TRANSPORTATION TROLLEY STANDARDS

SPECIAL FOUNDATION ANCHOR BASE STEEL POLE DATE:
JANUARY 04
FILE
DWG. NO.
SA - 213(S)

GENERAL NOTES

4. SUBMITTALS

- 4.1 Reinforcing steel shop drawings and certificate of compliance.
- 4.2 Concrete mix proportions, admixtures and slump.
- 4.3 Anchor plate, anchor bolt, anchor bolt nuts and washers certificates of compliance.
- 4.4 A test report shall be provided in accordance with ASTM F1554-99 and supplementary requirements.

5. INSPECTION

5.1 Concrete shall not be placed until the Engineer has inspected the excavation, the grounding, the anchor bolts, and the placement of the reinforcing bar cage.

6. ANCHOR BOLT SETTING

- 6.1 Cover exposed anchor bolt threads and nuts with at least 3 layers of plastic tape before placing concrete.
- 6.2 Anchor bolt template shall by used temporarily at the top of anchor bolts for accurate positioning and aligning.

7. CONDUIT

7.1 Conduit from foundation shall be schedule 80 PVC. Conduit bends shall have a minimum radius of 12".

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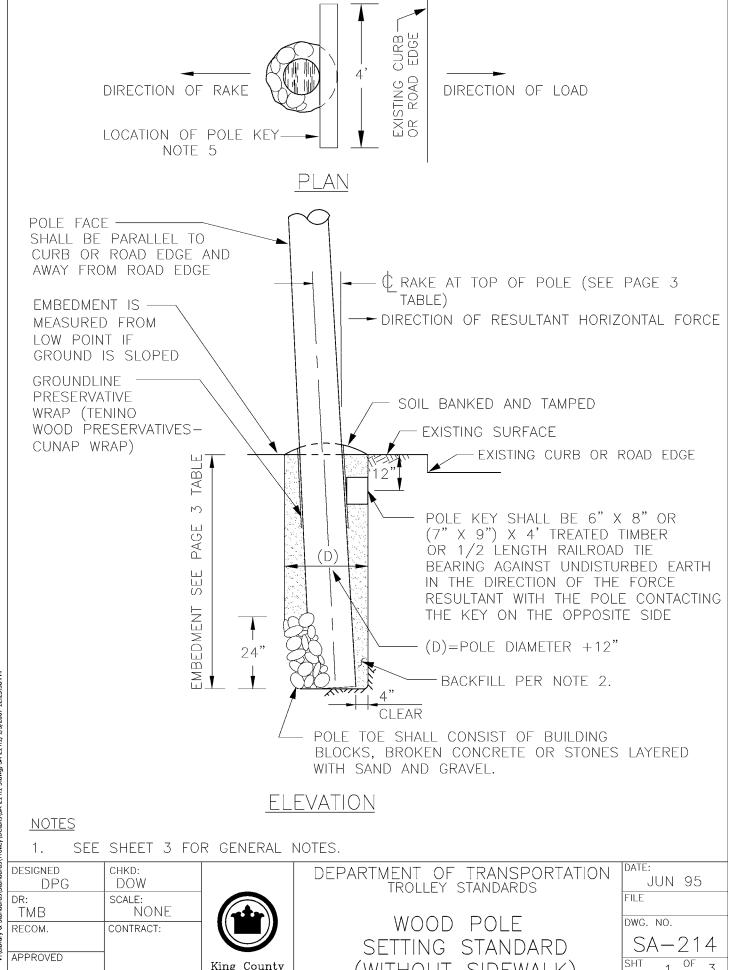


DEPARTMENT OF TRANSPORTATION TROLLEY STANDARDS

STANDARD FOUNDATION
(ANCHOR BASE
STEEL POLE)

DATE:
JANUARY 04
FILE
DWG. NO.

SA-213(S)




(WITHOUT SIDEWALK)

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King County

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SEE SHEET 3 FOR GENERAL NOTES.

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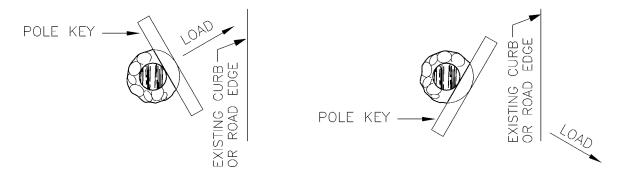
DEPARTMENT OF TRANSPORTATION TROLLEY STANDARDS
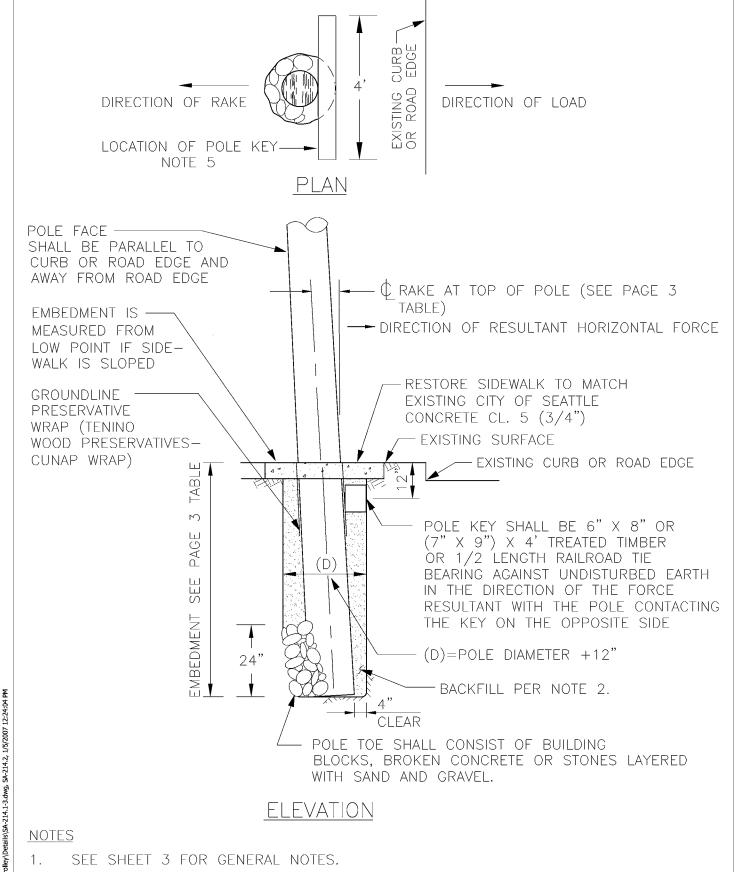
> WOOD POLE SETTING STANDARD (WITH SIDEWALK)

DATE: JUN 95 FILE DWG. NO. OF

NOTES:

- THIS DETAIL APPLIES TO SOIL FREE OF PEAT, MUCK OR OTHER ORGANIC MATTER. SOILS HAVING THE ABOVE MENTIONED QUALITIES SHALL REQUIRE SPECIAL INVESTIGATION.
- 2. SOIL USED FOR BACKFILL SHALL BE WELL GRADED SAND AND GRAVEL MIX FREE FROM SOD, GRASS, WEEDS AND ALL SIMILAR ORGANIC MATERIALS AND SUITABLY DRY FOR COMPACTION. SAND AND GRAVEL MIX CAN BE EITHER EXCAVATED SOIL OR IMPORTED.
- 3. ALL WATER IN HOLE SHALL BE REMOVED BEFORE SETTING AND TAMPING THE HOLE.
- 4. IN BACKFILLING, THE SAND AND GRAVEL MIX SHALL BE REPLACED IN EVEN LAYERS APPROXIMATELY 6" THICK AND FIRMLY AND THROUGHLY TAMPED TO A DRY DENSITY NOT LESS THAN THE NATURAL IN-PLACE DRY DENSITY OF THE SURROUNDING EARTH. IF HAND TAMPING BARS ARE USED, NOT MORE THAN ONE PERSON SHALL SHOVEL WHILE THREE PERSONS ARE TAMPING.
- 5. POLE KEY SHALL BE INSTALLED PERPENDICULAR TO DIRECTION OF LOAD, AND MAY NOT BE PARALLEL TO EXISTING CURB OR ROAD EDGE. SEE PLAN EXAMPLES BELOW.



6. DELETE POLE KEY & POLE TOE IF POLE IS GUYED WITH SA-231, SA-232, OR SA-233.

EME	BEDMENT AN	ND RAKE	SCHED	ULE
POLE	EMBEDMENT		RAK	Œ
LENGTH (ft)	(ft)	UNGUYED	GUYED	BRACKET ARM
35	8'-0"	17"	7"	7"
40	8'-0"	20"	8"	8"


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DEPARTMENT OF TRANSPORTATION TROLLEY STANDARD

WOOD POLE SETTING STANDARD

DATE:			
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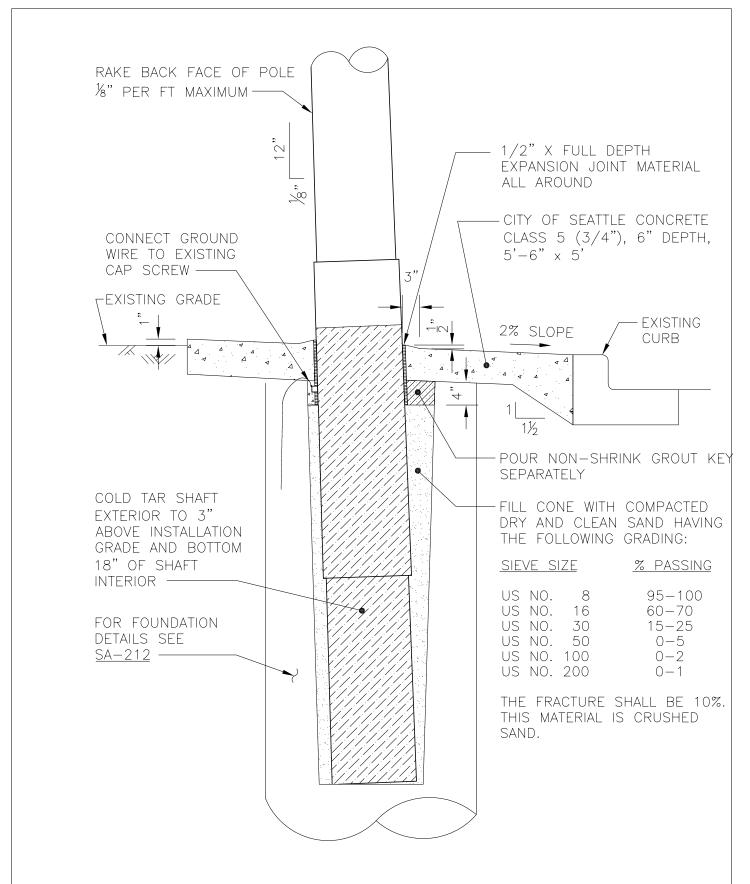
DESIGNED A WOLAK	CHKD: D GREER
DR: B FARISSB	scale: NONE
RECOM.	IBIS NO:
APPROVED J DAVIS	CONTRACT NO:



METRO TRANSIT DIVISION TROLLEY STANDARDS

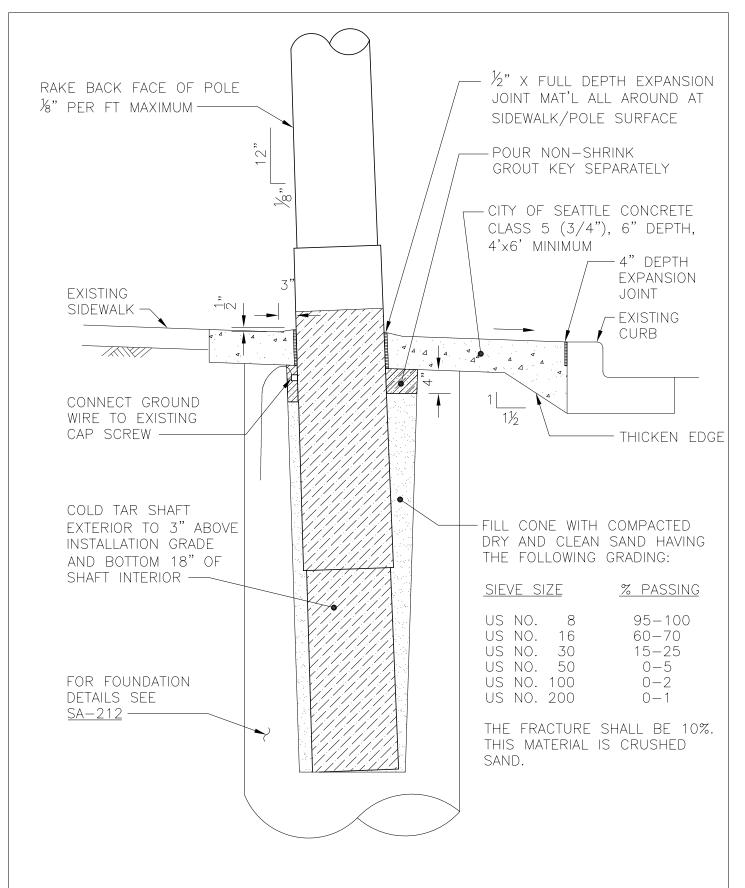EMBEDDED STEEL POLE INSTALLATION WITH SIDEWALK

DATE:
JUNE 2008
FILE
DWO NO
DWG. NO.
SA-215
SHT . OF -




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A WOLAK	D GREER
DR:	scale:
B FARISSB	NONE
RECOM.	IBIS NO:
APPROVED J DAVIS	CONTRACT NO:



METRO TRANSIT DIVISION TROLLEY STANDARDS

EMBEDDED STEEL POLE INSTALLATION WITHOUT SIDEWALK

DATE:
JUNE 2008
FILE
DWG. NO.
SA-215
SHT 2 OF 3

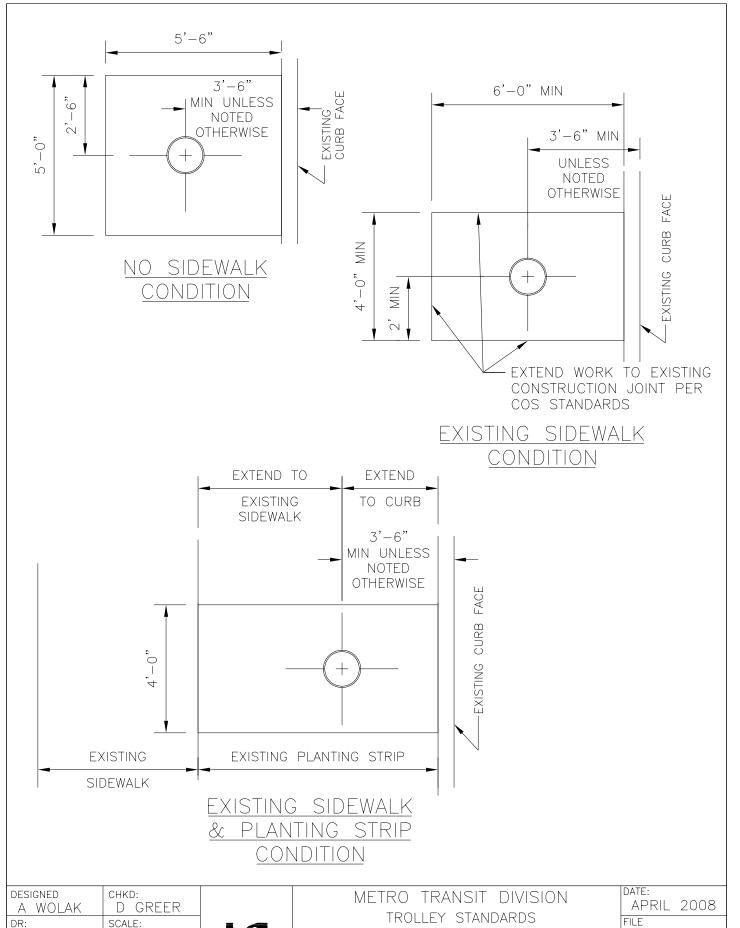


DESIGNED A WOLAK	CHKD: D GREER	
DR: B FARISSB	scale: NONE	
RECOM.	IBIS NO:	
APPROVED J DAVIS	CONTRACT NO:	



EMBEDDED STEEL POLE INSTALLATION

date: APRIL 2008
FILE
DWG. NO.
SA - 215
SHT 3 OF 3

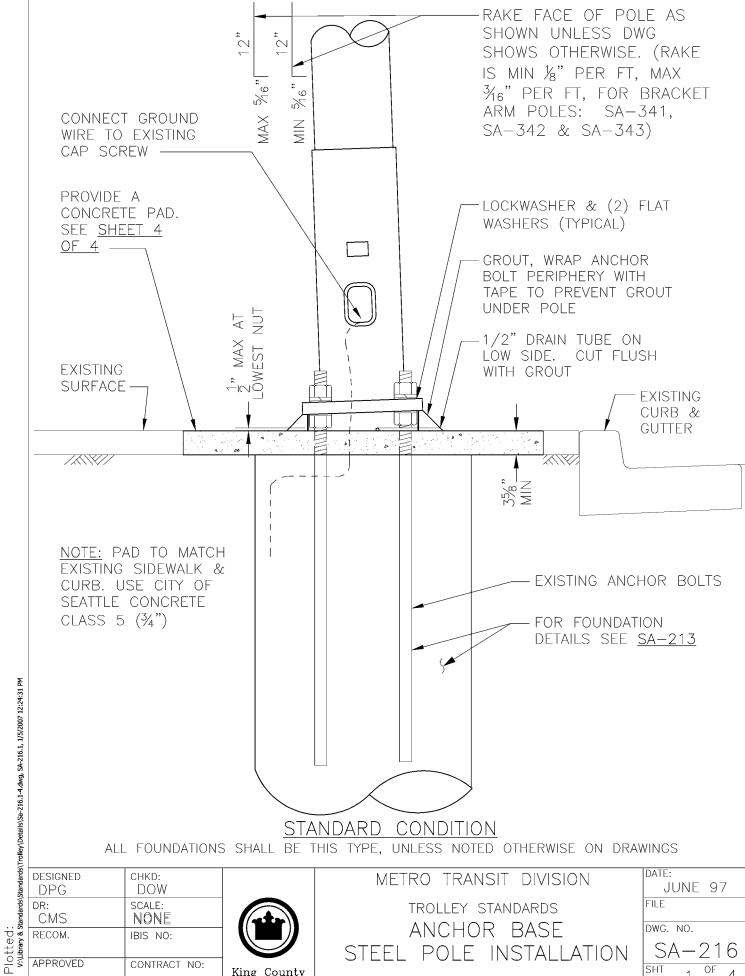

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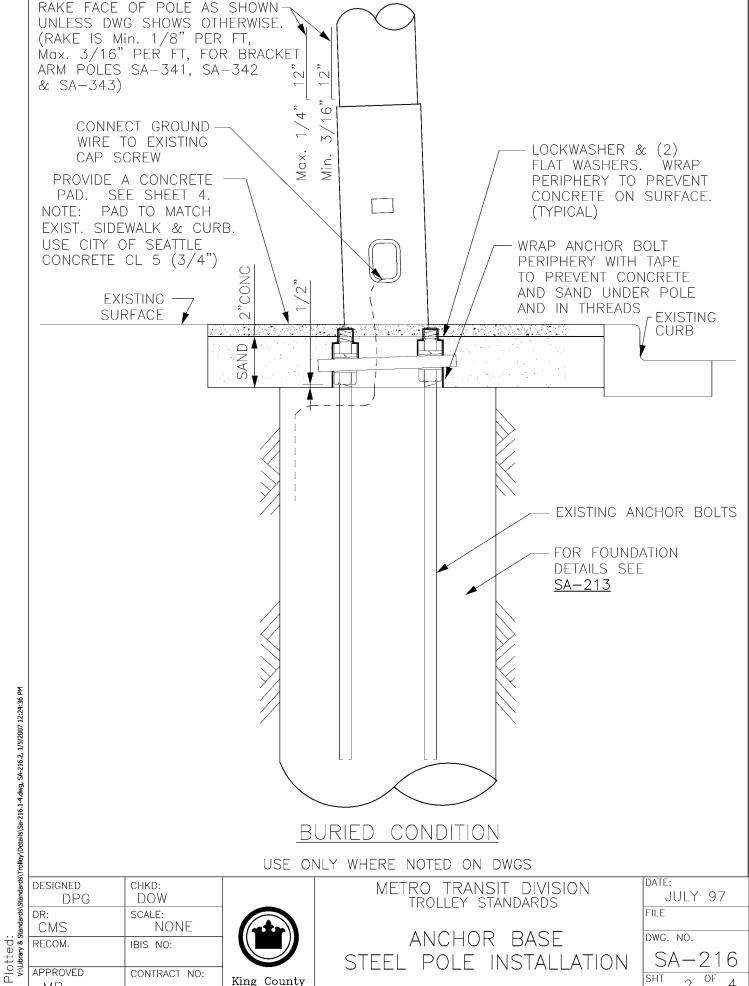
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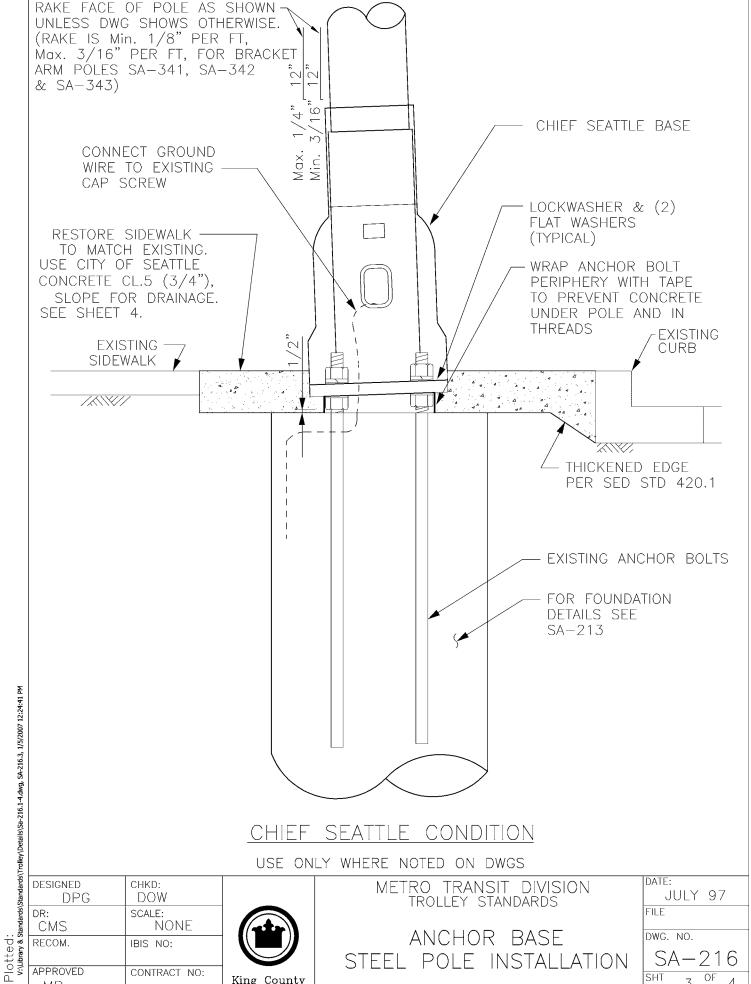
CONTRACT NO:

TROLLEY STANDARDS ANCHOR BASE STEEL POLE INSTALLATION

DATE:
JUNE 97
FILE
DWG. NO.
SA - 216
SHT 1 OF 4



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STEEL POLE INSTALLATION

OF

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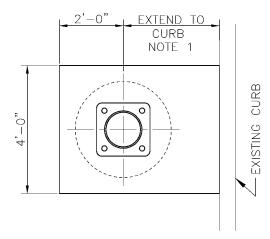
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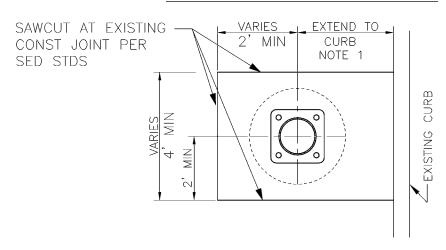
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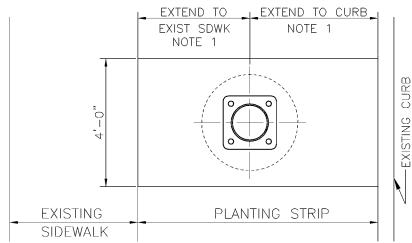
King County



NO SIDEWALK CONDITION



EXISTING SIDEWALK CONDITION



EXISTING SIDEWALK & PLANTING STRIP CONDITION

NOTE 1: 2 FT MIN DIMENSION MAY BE USED IF DIMENSION EXCEEDS 6 FT.


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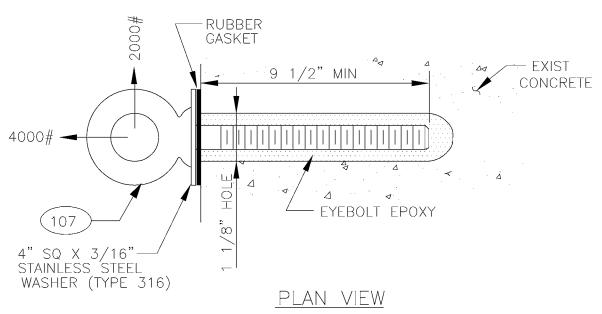


METRO TRANSIT DIVISION TROLLEY STANDARDS

ANCHOR BASE STEEL POLE INSTALLATION

DATE	:		
	JAN	97	
FILE			
DWG.	NO.		
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SHT	4	OF	4



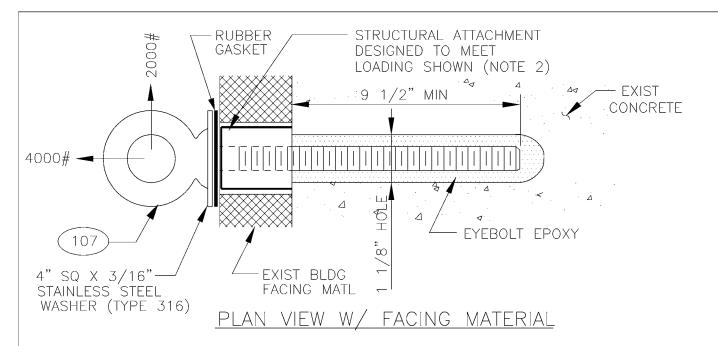

NOTES:

- 1. INSTALL EYEBOLT EYE IN A HORIZONTAL ORIENTATION.
- 2. USE ITW RAMSET/REDHEAD EPCON EPOXY ANCHORING SYSTEM TO SET THE EYEBOLT. AN EPCON E101 HAND TOOL INJECTOR WITH AN E24 NOZZLE SHALL BE USED TO INJECT CERAMIC 6 EPOXY. INSTALL PER THE MANUFACTURES RECOMMENDATIONS.
- 3. TO PREVENT SPALLING, DEFLECTION RESULTING FROM SHEAR LOADING SHALL NOT ALLOW THE EYEBOLT TO CONTACT BUILDING FACING MATERIAL.
- 4. EYEBOLT SHOULDER SHALL BE SEATED.
- 5. A TWO FOOT MINIMUM SPACING IS REQUIRED BETWEEN EYEBOLTS.


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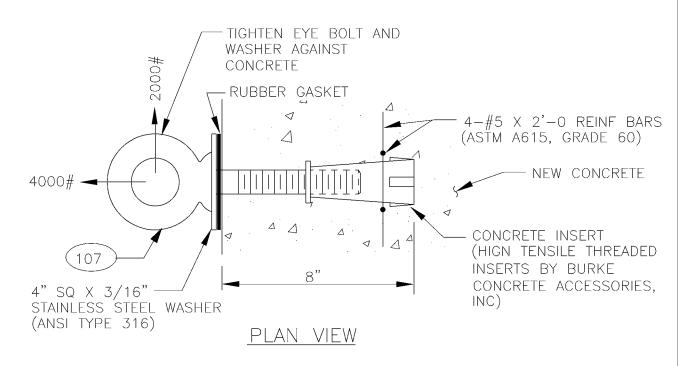
DEPARTMENT OF TRANSPORTATION TROLLEY STANDARDS

BLDG EYEBOLT INSTALLATION (EXISTING CONCRETE STRUCTURE)

	DATE:
	JAN 98
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	SA-221
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PLAN VIEW W/FACING



NOTES:

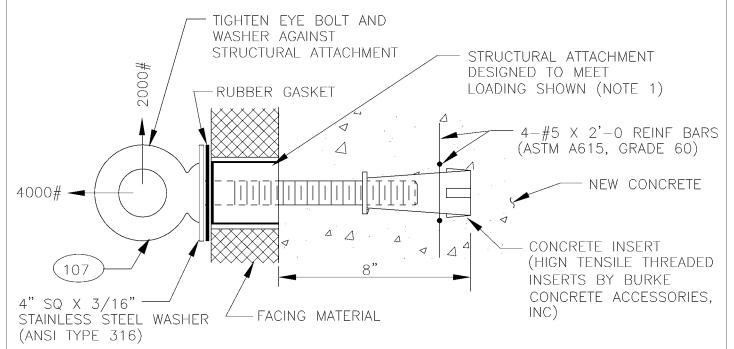- TO PREVENT SPALLING, DEFLECTION RESULTING FROM SHEAR LOADING SHALL NOT ALLOW THE EYEBOLT TO CONTACT BUILDING FACING MATERIAL.
- 2. INSTALL EYEBOLT EYE IN A HORIZONTAL ORIENTATION.
- 3. A TWO FOOT MINIMUM SPACING IS REQUIRED BETWEEN EYEBOLTS.

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DEPARTMENT OF TRANSPORTATION TROLLEY STANDARDS

BLDG EYEBOLT INSTALLATION DWG. NO. (NEW CONCRETE STRUCTURE)

DATE: JUN 97 FILE

OF

NOTES:

- 1. A TWO FOOT MINIMUM SPACING IS REQUIRED BETWEEN EYEBOLTS.
- 2. INSTALL EYEBOLT EYE IN A HORIZONTAL ORIENTATION.

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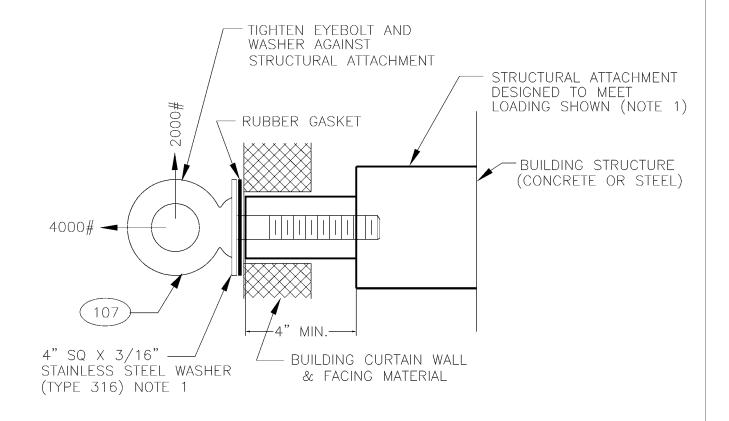
DEPARTMENT OF TRANSPORTATION TROLLEY STANDARDS

BLDG EYEBOLT INSTALLATION (MASONRY STRUCTURE)

	DATE:	
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SA-221

SHT 3 OF 5



PLAN VIEW

NOTES:

- TO PREVENT BREAKAWAY, DEFLECTION RESULTING FROM SHEAR FORCE SHALL NOT 1. ALLOW THE STRUCTURAL ATTACHMENT TO CONTACT EXISTING BUILDING FACING MATERIAL.
- 2. INSTALL EYEBOLT EYE IN A HORIZONTAL ORIENTATION.
- 3. A TWO FOOT MINIMUM SPACING IS REQUIRED BETWEEN EYEBOLTS.

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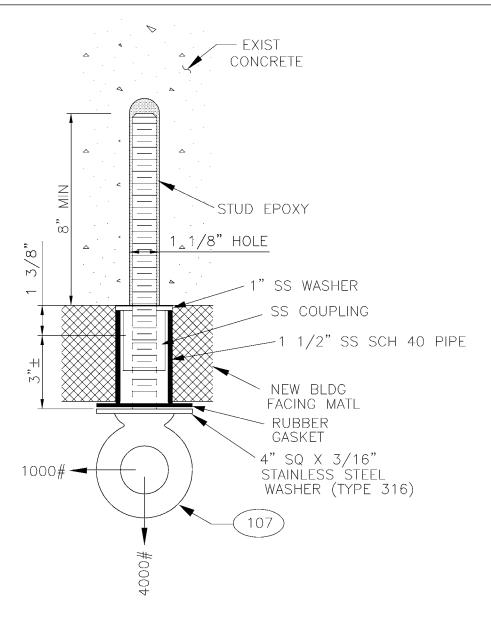


DEPARTMENT OF TRANSPORTATION TROLLEY STANDARDS

BLDG EYEBOLT INSTALLATION DWG. NO. (CURTAIN WALL STRUCTURE)

DATE: JUN 97 FILE

OF 5 4



PLAN VIEW W/ FACING MATERIAL

NOTES:

- 1. INSTALL EYEBOLT EYE IN A HORIZONTAL ORIENTATION.
- 2. USE ITW RAMSET/REDHEAD EPCON EPOXY ANCHORING SYSTEM TO SET THE STUD. AN EPCON E101 HAND TOOL INJECTOR WITH AN E24 NOZZLE SHALL BE USED TO INJECT CERAMIC 6 EPOXY. INSTALL PER THE MANUFACTURES RECOMMENDATIONS.
- 3. TO PREVENT SPALLING, DEFLECTION RESULTING FROM SHEAR LOADING SHALL NOT ALLOW THE EYEBOLT TO CONTACT BUILDING FACING MATERIAL.
- 4. EYEBOLT SHOULDER SHALL BE SEATED.
- A TWO FOOT MINIMUM SPACING IS REQUIRED BETWEEN ADJACENT EYEBOLTS.


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DEPARTMENT OF TRANSPORTATION TROLLEY STANDARDS

BLDG EYEBOLT INSTALLATION (EXISTING CONCRETE STRUCTURE WITH FACING)

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Λ	DWG. NO.
	SA - 221
	SHT 5 OF 5



- 1. INSTALLATION HEIGHT AND LOCATION OF ANCHOR IS INDICATED ON THE OVERHEAD DWGS.
- SCREW ANCHOR SHALL HAVE TWO 8" HELIXES FOR GLACIAL TILL WITH A 1-1 1/2" HUB 2. CAPABLE OF DEVELOPING 7000 FT-LBS MAXIMUM WORKING TORQUE. THE ANCHOR ROD SHALL BE 1" DIA. WITH A TRIPLE EYE.
- MINIMUM INSTALLATION TORQUE FOR THE SCREW ANCHORS SHALL BE 3500 FOOT-LBS 3. THIS TORQUE VALUE WILL REQUIRE THE USE OF 7 SHEAR PINS FOR USE WITH THE A.B. CHANCE TORQUE INDICATOR, CATALOG # C303-044.

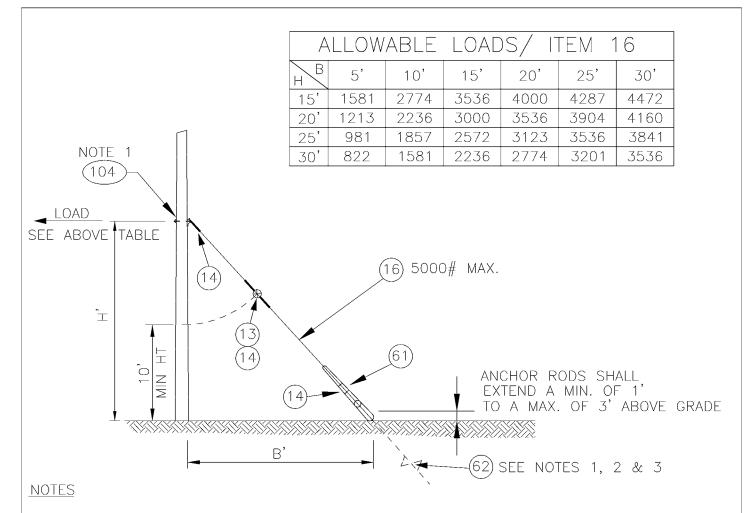MATERIAL LICT

	MATERIAL LIST					
ITEN	Л #	QTY	DESCRIPTION	MANUFACTURER	CAT. NO.	
13 1 GUY STRAIN INSUL PORCELAIN PRODUCTS CO.					506	
14	1	4	GUY GRIP DEADEND	PREFORMED	CDE-3115	
16	5	VARIES	GUY STRAND	COPPERWELD	16M	
61	61 1 GUY GUARD, 8 FT, PREFORMED PG 5518 FOR USE ON 3/16" TO 1/2" STRAND					
62	62 1 POWER INSTALLED SCREW ANCHOR CHANCE E102-1219				E102-1219	
10	104 VARIES WOOD POLE DOWNGUY ASSEMBLY METRO STD SA-104				SA-104	
DEDARTMENT OF TRANSCOOPTATION DATE:					. DATE:	


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DEPARTMENT OF TRANSPORTATION TROLLEY STANDARDS

DOWN GUY

OCT 95 FILE DWG. NO. OF 1



NOTES:

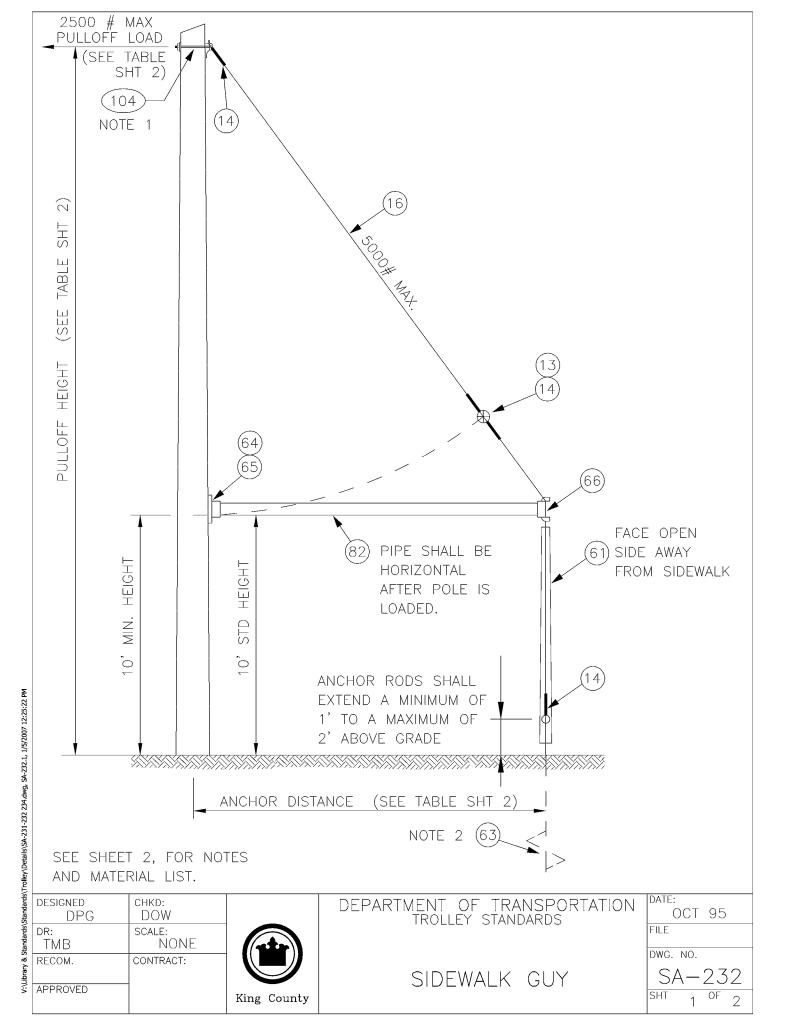- INSTALLATION HEIGHT AND LOCATION OF ANCHOR IS INDICATED ON THE OVERHEAD DRAWINGS.
- SCREW ANCHOR SHALL HAVE TWO 8" HELIXES FOR GLACIAL TILL WITH A 1 1/2" HUB 2. CAPABLE OF DEVELOPING 7000 FT-LBS MAX. WORKING TORQUE. THE ANCHOR ROD SHALL BE 1" DIAMETER WITH A TRIPLE EYE. MINIMUM INSTALLATION TORQUE FOR S

ALLOWABLE PULLOFF LOADING PER GUY

2236 1923 2236 `0 1682 1970 2236 2480 1756 2236 2500 1491 2004 2451 2030 1338 1581 1812 2236 2428 2500 2052 1213 1437 1652 1857 2236 2410 2500

* = MAXIMUM LOAD OF 2500 # APPLIES.

MATERIAL LIST

	ITEM #	QTY			DESCRIPT	ION	MANUFACTURER	CAT. NO.
•	13	13 1			TRAIN INSUL		PORCELAIN	506
						PRODUCTS CO.		
	14	4	-	GUY G	RIP DEADEND)	PREFORMED	CDE-3115
₩	16	VAR	IES	GUY S	TRAND		COPPERWELD	16M
:25:27	61	1		GUY G	UARD, 8 FT,		PREFORMED	PG 5518
007 12				FOR U	FOR USE ON 3/16" TO 1/2" STRAND			
, 1/5/2	63	1		POWER	INSTALLED	SCREW ANCHOR	CHANCE	C102-1260
\-232.2	64	1		POLE I	PLATE, 2 1/	2" PIPE	JOSLYN	J0521
Wg, S/	65	4 LA(LAG SO	LAG SCREW, FETTER DRIVE, 1/2" x 4"		JOSLYN	J8754
2 234.d	66 1 END			END FITTING, 2 1/2" PIPE		COOPER	DG5G1	
31-23						POWER SYSTEM		
Is\SA-2	82 VARIES		2 1/2	" DIA ASTM	A53 GRB STD WT			
\Detai		GAL		GALV S	STEEL PIPE			
Trolley	104	VAR	IES	WOOD	WOOD POLE DOWNGUY ASSEMBLY		METRO STD	SA-104
V:\Library & Standards\Standards\Trolley\Details\SA-231-232 234.dwg, SA-232.2, 1/5/2007 12:25;27 PM	DESIGNED DPG					DEPARTMENT OF T TROLLEY ST.	RANSPORTATIOI ANDARDS	001 90
ndards	dr: TMB		SCALE:	ALE: NONE				FILE
& Sta			CONTRACT:					DWG. NO.
APPROVED					SIDEWAL	K GUY	SA-232	



OCT 96 FILE DWG. NO. OF

		MATERIAL LIST		
ITEM #	QTY	DESCRIPTION	MANUFACTURER	CAT. NO.
17 4 THIMBLE, 1/2" XHD, OPEN		CROSBY	G414	
55	VARIES	PHILLYSTRAN (3/8")	PHILLYSTRAN INC	HPTG 67001
56	4	PHILLYSTRAN BIG GRIP	PHILLYSTRAN INC	PLP 2755
90	1	HEAVY PIPE CLAMP, GALV, 3" IPS	GRINNELL	FIG. 216
102	VARIES	FORGED THREE—PIECE ADJUSTABLE POLE BAND, ANNEALED & GALVANIZED	KORTICK MFG CO	
103	VARIES	WOOD POLE EYEBOLT	METRO STD	SA-103

NOTES

1. A POLE COLLAR OR POLE EYEBOLT IS REQUIRED PER SA-102 OR SA-103. INSTALLATION HEIGHT IS 1 FOOT ABOVE THE BRACKET ARM UNLESS DWGS SPECIFY OTHERWISE.

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	DPG	DPG
	DR:	SCALE:
	DOW	NONE
	RECOM.	CONTRACT:
	APPROVED	

King	County

DEPARTMENT OF TRANSPORTATION TROLLEY STANDARDS

BRACKET ARM GUY

DATE:
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FILE
DWG. NO.
SA - 234
SHT 2 OF 2

NOTES

- A POLE COLLAR OR POLE EYEBOLT IS REQUIRED PER SA-102 OR SA-103 UNLESS A BUILDING EYEBOLT ATTACHMENT IS USED. GUY TENSION IS INDICATED ON THE OVERHEAD DRAWINGS.
- 2 PROVIDE TENSION ADJUSTMENT POINTS AT LOCATIONS INDICATED BY "\[
 \bigcirc\]".
 PROVIDE TWO WIRE ROPE CLIPS AT THESE LOCATIONS. SEE SA-166.
- 3 SEE SA-167 FOR INSULATED GUY CRITERIA.

MATERIAL LIST								
ITEM #	QTY	DESCRIPTION	MANUFACTURER	CAT. NO.				
SA-233	SA-233LGUY TENSIONS 0-2500 LBS							
03	2	GUY STRAIN INSUL	WABCO	31504-3060				
04	5	GUY GRIP DEADEND	PREFORMED	CDE-3106				
05	2	WIRE ROPE CLIP, 5/16"	CROSBY	G450				
06	AS REQD	FRICTION TAPE, 3/4" 6 WRAPS						
07	2	THIMBLE, 3/8" XHD, OPEN	CROSBY	G414				
08	VARIES	GUY STRAND	COPPERWELD	8M-NOTE 3				
SA-233	SHGU	Y TENSIONS 2500-5000 LBS						
06	AS REQD	FRICTION TAPE, 3/4" 6 WRAPS						
13	2	GUY STRAIN INSUL.	WABCO	31506-3060				
14	5	GUY GRIP DEADEND	PREFORMED	CDE-3115				
15	4	WIRE ROPE CLIP, 5/16"	CROSBY	G450				
16	VARIES	GUY STRAND	COPPERWELD	16M-NOTE 3				
17	2	THIMBLE, 1/2" XHD, OPEN	CROSBY	G414				
ALSO SA-233L & SA-233H								
102	VARIES	STEEL POLE COLLAR	METRO	SA-102				
103	VARIES	WOOD POLE EYEBOLT	METRO	SA-103				

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TMB NONE

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APPROVED CONTRACT NO:




METRO TRANSIT DIVISION TROLLEY OVERHEAD SYSTEM STANDARDS STANDARD HEAD GUY DATE:
JUN 93

FILE

DWG. NO.

SA-233

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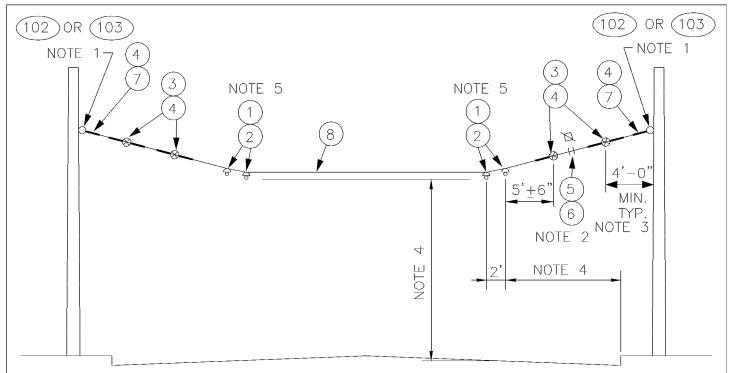
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RECOM. APPROVED	TROLLEY STANDARDS	BRACKET ARM GUY	SA-234 SHT 1 OF 2

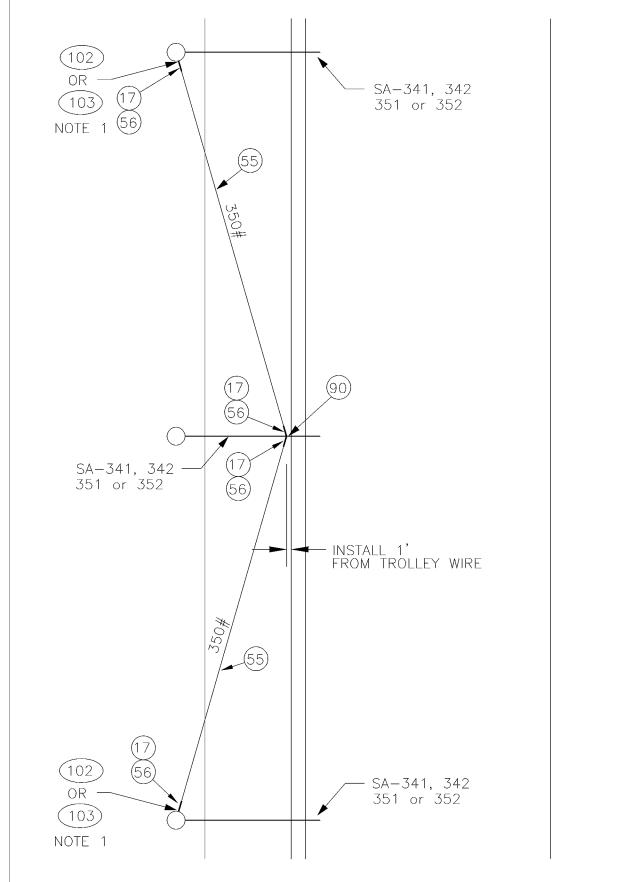MATERIAL LIST					
ITEM #	QTY	DESCRIPTION	MANUFACTURER	CAT. NO.	
17	4	THIMBLE, ½" XHD, OPEN	CROSBY	G414	
55	VARIES	PHILLYSTRAN (¾")	PHILLYSTRAN INC	HPTG 67001	
56	4	PHILLYSTRAN BIG GRIP	PHILLYSTRAN INC	PLP2755	
90	1	HEAVY PIPE CLAMP, GALV 3" IPS	GRINNELL	FIG. 216	
102	VARIES	FORGED 3—PIECE ADJUSTABLE POLE BAND, ANNEALED & GALVANIZED	KORTICK MFG CO		
103	VARIES	WOOD EYEBOLT	METRO STD	SA-103	

NOTE

1. A POLE COLLAR OR POLE EYEBOLT IS REQUIRED PER SA-102 OR SA-103. INSTALLATION HEIGHT IS 1 FOOT ABOVE THE BRACKET ARM UNLESS SRAWINGS SPECIFY OTHERWISE.

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RECOM. APPROVED	TROLLEY STANDARDS	BRACKET ARM GUY	SA-234



NOTES

- 1. A POLE COLLAR OR POLE EYEBOLT IS REQUIRED PER SA-102 OR SA-103 UNLESS A BUILDING EYEBOLT ATTACHMENT IS USED. INSTALLATION HEIGHT IS INDICATED ON THE OVERHEAD DRAWINGS.
- 2. PROVIDE TENSION ADJUSTMENT POINTS AT LOCATIONS INDICATED BY "□". PROVIDE WIRE ROPE CLIPS AT THESE LOCATIONS. SEE SA-166.
- 3. SEE SA-370 FOR LIMITED SPACE VARIANCES.
- 4. SEE SA-164 FOR VERTICAL & HORIZONTAL DIMENSIONS TO TROLLEY WIRE.
- 5. MAXIMUM ANGLE IS 0.5°. SEE SA-307, PLAN VIEW.

MATERIAL LIST						
ITEM #	QTY		DESCRIPT	TON	MANUFACTURER	CAT. NO.
01	4	DETRO	IT CLAMP AS	SY	WABCO	19293-3007
02	4	AGC TA	ANGENT SPAN	N HANGER	WABCO	19360-2000
03	4	GUY S	TRAIN INSUL		PORCELAIN	504
					PRODUCTS CO.	
04	9	GUY G	RIP DEADENE)	PREFORMED	CDE-3106
05	2	WIRE F	WIRE ROPE CLIP, 5/16"		CROSBY	G450
06	AS REQD	FRICTIO	ON TAPE, 3/	4" (6 WRAPS)		
07	2	THIMBL	_E, 3/8" XH[D, OPEN	CROSBY	G414
08	VARIES	GUY STRAND		COPPERWELD	8M	
102	VARIES	FORGED THREE-PIECE ADJUSTABLE		KORTICK		
		POLE	BAND, ANNEA	ALED & GALVANIZED	MFG CO	
103	VARIES	WOOD POLE EYEBOLT			METRO STD	SA-103
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King County


DEPARTMENT OF TRANSPORTATION TROLLEY STANDARDS

TANGENT SPAN TWO-WAY TRAFFIC OCT 95
FILE

DWG. NO.

SA - 301

SHT 1 OF 1

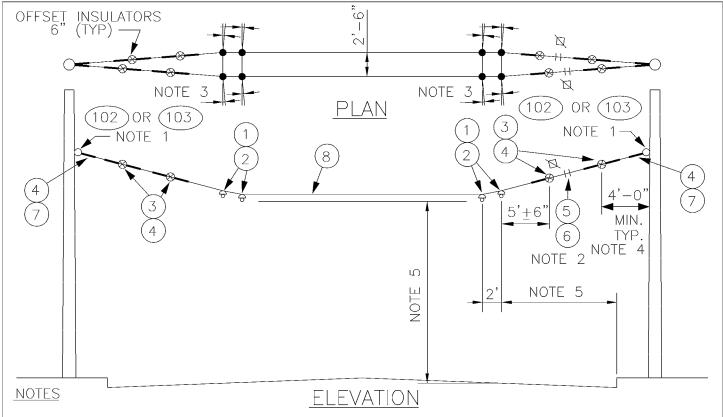

- A POLE COLLAR OR POLE EYEBOLT IS REQUIRED PER SA-102 OR SA-103 UNLESS A BUILDING EYEBOLT ATTACHMENT IS USED. INSTALLATION HEIGHT IS INDICATED ON THE OVERHEAD DRAWINGS.
- PROVIDE TENSION ADJUSTMENT POINTS AT LOCATIONS INDICATED BY "". 2. PROVIDE WIRE ROPE CLIPS AT THESE LOCATIONS. SEE SA-166.
- MAXIMUM ANGLE 1°, 0.5° PER SPAN HANGER. 3.
- SEE SA-370 FOR LIMITED SPACE VARIANCES.
- SEE SA-164 FOR VERTICAL & HORIZONTAL DIMENSIONS TO TROLLEY WIRE.

MATERIAL LIST					
ITEM #	QTY	DESCRIPTION	MANUFACTURER	CAT. NO.	
01	8	DETROIT CLAMP ASSY	WABCO	19293-3007	
02	8	AGC TANGENT SPAN HANGER	WABCO	19360-2000	
03	8	GUY STRAIN INSUL	PORCELAIN	504	
			PRODUCTS CO.		
04	18	GUY GRIP DEADEND	PREFORMED	CDE-3106	
05	4	WIRE ROPE CLIP, 5/16"	CROSBY	G450	
06	AS REQD	FRICTION TAPE, 3/4" (6 WRAPS)			
07	4	THIMBLE, 3/8" XHD, OPEN	CROSBY	G414	
08	VARIES	GUY STRAND	COPPERWELD	8M	
102	VARIES	FORGED THREE-PIECE ADJUSTABLE	KORTICK		
		POLE BAND, ANNEALED & GALVANIZED	MFG CO		
103	VARIES	WOOD POLE EYEBOLT	METRO STD	SA-103	
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TROLLEY STANDARDS

HOLDUP TANGENT SPAN

TWO-WAY TRAFFIC

FILE

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SCALE:

CONTRACT:

NONE

King County

NOTES

- 1. A POLE COLLAR OR POLE EYEBOLT IS REQUIRED PER SA-102 OR SA-103 UNLESS A BUILDING EYEBOLT ATTACHMENT IS USED. INSTALLATION HEIGHT IS INDICATED ON THE OVERHEAD DRAWINGS.
- 2. PROVIDE TENSION ADJUSTMENT POINTS AT LOCATIONS INDICATED BY "♥". PROVIDE WIRE ROPE CLIPS AT THESE LOCATIONS. SEE SA-166.
- 3. MAXIMUM ANGLE 0.5 DEGREE. SEE SA-307, PLAN VIEW.
- 4. SEE SA-370 FOR LIMITED SPACE VARIANCES.
- 5. SEE SA-164 FOR VERTICAL & HORIZONTAL DIMENSIONS TO TROLLEY WIRE.

MATERIAL LIST					
ITEM #	QTY	DESCRIPTION	MANUFACTURER	CAT. NO.	
01	4	DETROIT CLAMP ASSY	WABCO	19293-3007	
03	4	GUY STRAIN INSUL	PORCELAIN	504	
			PRODUCTS CO.		
04	10	GUY GRIP DEADEND	PREFORMED	CDE-3106	
05	8	WIRE ROPE CLIP, 5/16"	CROSBY	G450	
06	AS REQD	FRICTION TAPE, 3/4" (6 WRAPS)			
07	4	THIMBLE, 3/8" XHD, OPEN	CROSBY	G414	
08	VARIES	GUY STRAND	COPPERWELD	8M	
10	2	HI-LITE DOUBLE CURVE HANGER	WABCO	54962-3001	
102	VARIES	FORGED THREE-PIECE ADJUSTABLE	KORTICK		
		POLE BAND, ANNEALED & GALVANIZED	MFG CO		
103	VARIES	WOOD POLE EYEBOLT	SA-103		
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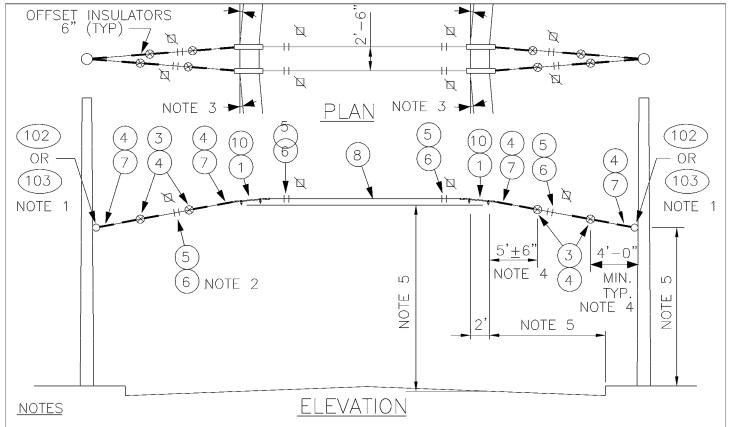
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DEPARTMENT OF TRANSPORTATION TROLLEY STANDARDS

INVERTED TANGENT SPAN
TWO-WAY TRAFFIC



- A POLE COLLAR OR POLE EYEBOLT IS REQUIRED PER SA-102 OR SA-103 UNLESS A BUILDING EYEBOLT ATTACHMENT IS USED. INSTALLATION HEIGHT IS INDICATED ON THE OVERHEAD DRAWINGS.
- PROVIDE TENSION ADJUSTMENT POINTS AT LOCATIONS INDICATED BY "". 2. PROVIDE WIRE ROPE CLIPS AT THESE LOCATIONS. SEE SA-166.
- 3. MAXIMUM ANGLE 1°, 0.5° PER DOUBLE CURVE HANGER.

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4. SEE SA-370 FOR LIMITED SPACE VARIANCES.

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CONTRACT:

NONE

SCALE:

5. SEE SA-164 FOR VERTICAL & HORIZONTAL DIMENSIONS TO TROLLEY WIRE.

	MATERIAL LIST						
ITEM #	QTY	,		DESCRIPT	ION	MANUFACTURER	CAT. NO.
01	8		DETROI	T CLAMP AS:	SY	WABCO	19293-3007
03	8		GUY S	TRAIN INSUL		PORCELAIN	504
						PRODUCTS CO.	
04	20		GUY G	RIP DEADEND)	PREFORMED	CDE-3106
05	16		WIRE F	E ROPE CLIP, 5/16"		CROSBY	G450
06	AS RE	EQD	FRICTIC	FRICTION TAPE, 3/4" (6 WRAPS)			
07	8		THIMBLE, 3/8" XHD, OPEN		CROSBY	G414	
08	08 VARIES GUY STRAND		COPPERWELD	8M			
10	4		HI-LITE	HI-LITE DOUBLE CURVE HANGER		WABCO	54962-3001
102	VARIE	ES	FORGE	ORGED THREE-PIECE ADJUSTABLE		KORTICK	
:			POLE E	POLE BAND, ANNEALED & GALVANIZED		MFG CO	
103	VARIE	-S	WOOD	POLE EYEBO	POLE EYEBOLT		SA-103
DESIGNED CHKD: DPG DOW				DEPARTMENT OF THE TROLLEY STA		DATE: OCT 95	

HOLDDOWN TANGENT SPAN

TWO-WAY TRAFFIC


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BRIDLE TANGENT SPAN TWO-WAY TRAFFIC

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BRIDLE TANGENT SPAN TWO-WAY TRAFFIC

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DOUBLE BRIDLE TANGENT SPAN TWO-WAY TRAFFIC

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		MATERIAL LIST	
ITEM #	QTY	DESCRIPTION	MANUFACTURER CAT. NO.
01	4	DETROIT CLAMP ASSY	WABCO 19293-3007
02	4	AGC TANGENT SPAN HANGER	WABCO 19360-2000
03	VARIES	GUY STRAIN INSUL	PORCELAIN 504 PRODUCTS CO.
04	VARIES	GUY GRIP DEADEND	PREFORMED CDE-3106
05	VARIES	WIRE ROPE CLIP, 5/16"	CROSBY G450
06	AS REQD	FRICTION TAPE, 3/4" (6 WRAPS)	
07	VARIES	THIMBLE, 3/8" XHD, OPEN	CROSBY G414
80	VARIES	GUY STRAND	COPPERWELD 8M
09	2	BULL RING	WABCO 18567-2000
13	VARIES	GUY STRAIN INSUL	PORCELAIN 506 PRODUCTS CO.
14	VARIES	GUY GRIP DEADEND	PREFORMED CDE-3115
15	VARIES	WIRE ROPE CLIP, 3/8"	CROSBY G450
16	VARIES	GUY STRAND	COPPERWELD 16M
17	VARIES	THIMBLE, 1/2" XHD, OPEN	CROSBY G414
102	VARIES	FORGED THREE-PIECE ADJUSTABLE	KORTICK
		POLE BAND, ANNEALED & GALVANIZED	MFG CO
103	VARIES	WOOD POLE EYEBOLT	METRO STD SA-103

- 1. A POLE COLLAR OR POLE EYEBOLT IS REQUIRED PER SA-102 OR SA-103 UNLESS A BUILDING EYEBOLT ATTACHMENT IS USED. INSTALLATION HEIGHT IS INDICATED ON THE OVERHEAD DRAWINGS.
- PROVIDE TENSION ADJUSTMENT POINTS AT LOCATIONS INDICATED BY "\(\subseteq\)".
 PROVIDE WIRE ROPE CLIPS AT THESE LOCATIONS. SEE SA-166.
- 3. SEE SA-370 FOR LIMITED SPACE VARIANCES.
- 4. SEE SA-164 FOR VERTICAL & HORIZONTAL DIMENSIONS TO TROLLEY WIRE.
- 5. MAXIMUM ANGLE IS 0.5°. SEE SA-307, PLAN VIEW.
- 6. IF LOAD SHOWN ON OVERHEAD DRAWINGS IS LESS THAN 2500 LBS, THEN ITEM 8 MAY BE USED INSTEAD OF ITEM 16. THE ASSOCIATED ITEMS SHALL ALSO BE CHANGED I.E. 3 FOR 13, 4 FOR 14, 5 FOR 15 AND 7 FOR 17.
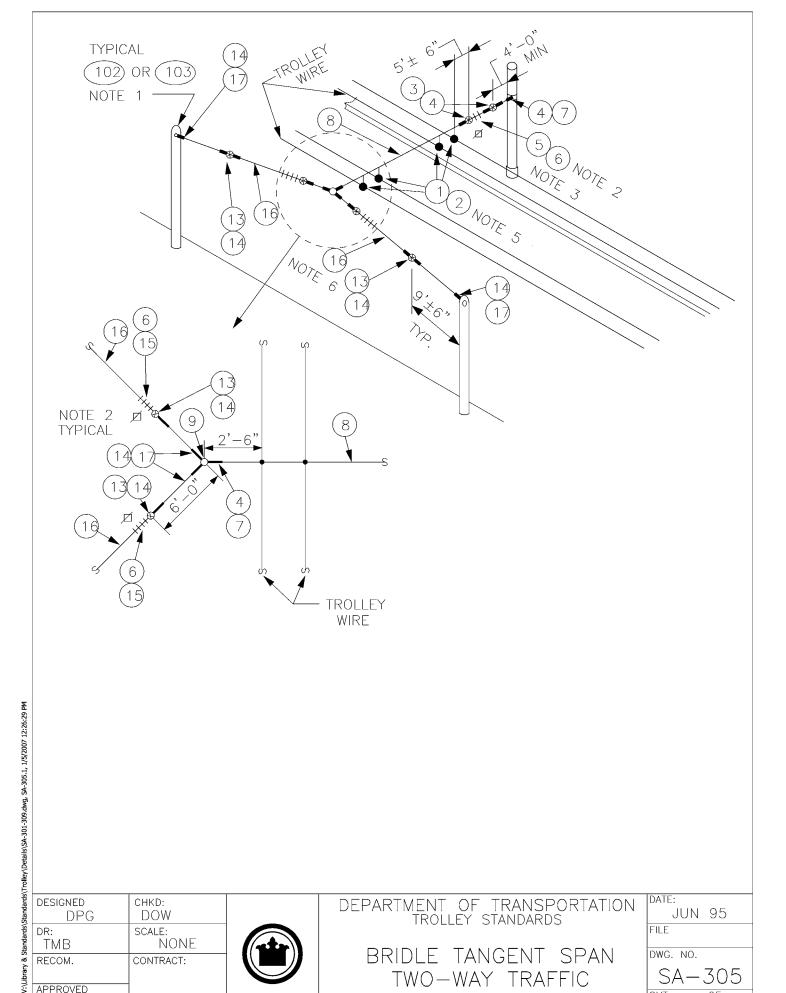
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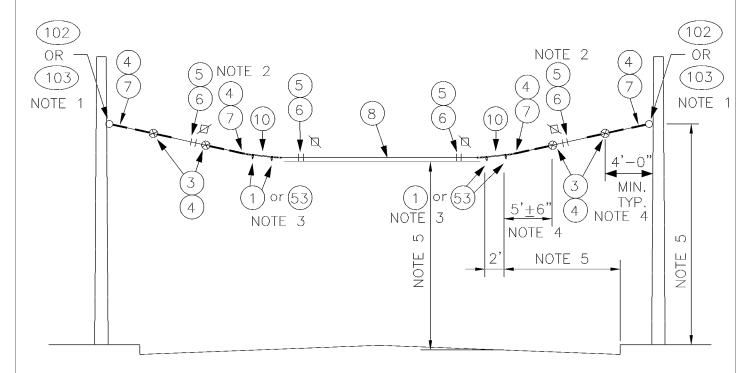
DEPARTMENT OF TRANSPORTATION TROLLEY STANDARDS

DOUBLE BRIDLE
TANGENT SPAN
TWO—WAY TRAFFIC

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PLAN



ELEVATION

NOTES

- 1. A POLE COLLAR OR POLE EYEBOLT IS REQUIRED PER SA-102 OR SA-103 UNLESS A BUILDING EYEBOLT ATTACHMENT IS USED. INSTALLATION HEIGHT IS INDICATED ON THE OVERHEAD DRAWINGS.
- 2. PROVIDE TENSION ADJUSTMENT POINTS AT LOCATIONS INDICATED BY " $\mbox{\cite{N}}$ ". PROVIDE WIRE ROPE CLIPS AT THESE LOCATIONS. SEE SA-166.
- 3. ANGLE VARIES FROM 1° TO 5°. USE ITEM 1 FOR 1° TO 2.5° ANGLE. USE ITEM 53 FOR 3° TO 5° ANGLE.
- 4. SEE SA-370 FOR LIMITED SPACE VARIANCES.
- SEE SA-164 FOR VERTICAL & HORIZONTAL DIMENSIONS TO TROLLEY WIRE.

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DEPARTMENT OF TRANSPORTATION TROLLEY STANDARDS

1° TO 5° CURVE SPAN WITH TWO FOOT CURVE RAILS TWO-WAY TRAFFIC

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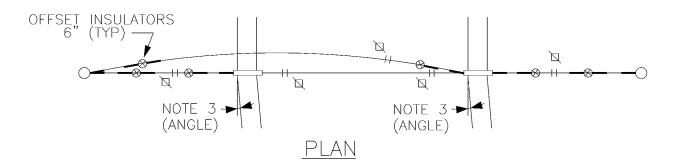
		MATERIAL LIST			
item #	QTY	DESCRIPTION	MANUFACTU	IRER	CAT. NO.
01	VARIES	DETROIT CLAMP ASSY	WABCO	19	9293-3007
03	4	GUY STRAIN INSUL	PORCELAIN PRODUCTS)4
04	10	GUY GRIP DEADEND	PREFORMED		CDE-3106
05	8	WIRE ROPE CLIP, 5/16"	CROSBY	G	450
06	AS REQD	FRICTION TAPE, 3/4" (6 WRAPS)			
07	4	THIMBLE, 3/8" XHD, OPEN	CROSBY	G	414
08	VARIES	GUY STRAND	COPPERWELD) (3M
10	2	HI-LITE DOUBLE CURVE HANGER	WABCO	5	4962-3001
53	VARIES	CURVE RAIL (3° TO 5° 2 FT LG)	K & M	851	B412/0
102	VARIES	FORGED THREE-PIECE ADJUSTABLE	KORTICK		
		POLE BAND, ANNEALED & GALVANIZED	MFG CO		
103	VARIES	WOOD POLE EYEBOLT	METRO STD	S	A-103
103	VARIES	WOOD POLE EYEBOLT	METRO STD	S	A-103


King County

DEPARTMENT OF TRANSPORTATION TROLLEY STANDARDS

1° TO 5° CURVE SPAN WITH TWO FOOT CURVE RAILS TWO-WAY TRAFFIC

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- 1. A POLE COLLAR OR POLE EYEBOLT IS REQUIRED PER SA-102 OR SA-103 UNLESS A BUILDING EYEBOLT ATTACHMENT IS USED. INSTALLATION HEIGHT IS INDICATED ON THE OVERHEAD DRAWINGS.
- 2. PROVIDE TENSION ADJUSTMENT POINTS AT LOCATIONS INDICATED BY " $\mbox{$\mathbb{Q}$}$ ". PROVIDE WIRE ROPE CLIPS AT THESE LOCATIONS. SEE SA-166.
- 3. ANGLE VARIES FROM 5.5° TO 7.5°.
- 4. SEE SA-370 FOR LIMITED SPACE VARIANCES. SEE SA-167 FOR INSULATED GUY CRITERIA.
- 5. SEE SA-164 FOR VERTICAL & HORIZONTAL DIMENSIONS TO TROLLEY WIRE.

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DEPARTMENT OF TRANSPORTATION TROLLEY STANDARDS

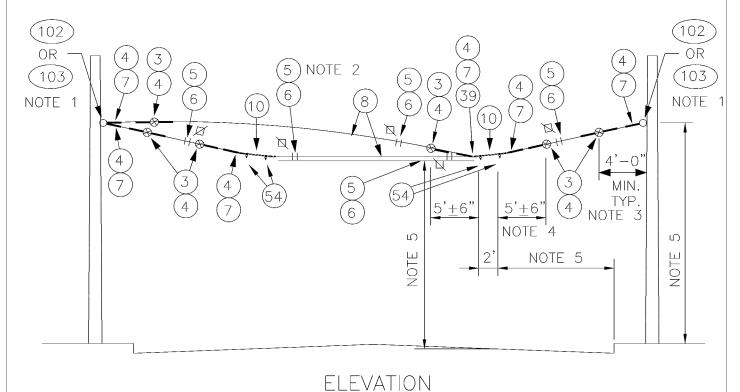5.5° TO 7.5° CURVE SPAN WITH 4 FOOT CURVE RAILS TWO-WAY TRAFFIC

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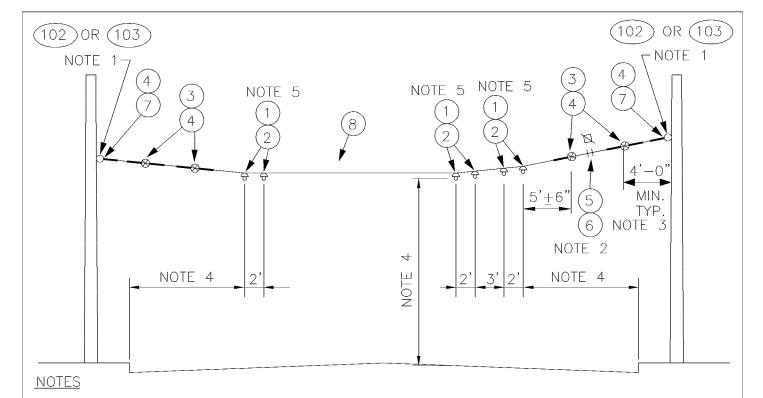
		MATERIAL LIST		
ITEM #	QTY	DESCRIPTION	MANUFACTURER	CAT. NO.
03	6	GUY STRAIN INSUL		04
			PRODUCTS CO.	
04	15	GUY GRIP DEADEND	PREFORMED	CDE-3106
05	10	WIRE ROPE CLIP, 5/16"	ROSBY G	450
06	AS REQD	FRICTION TAPE, 3/4" (6 WRAPS)		
07	6	THIMBLE, 3/8" XHD, OPEN	ROSBY G	414
08	VARIES	GUY STRAND	COPPERWELD	8M
10	2	HI-LITE DOUBLE CURVE HANGER	WABCO 5	4962-3001
39	1	5/8" SHACKLE	WABCO	13722-2000
54	VARIES	CURVE RAIL (5.5° TO 7.5° 4 FT LG) K &	M 851	B412/1
102	VARIES	FORGED THREE—PIECE ADJUSTABLE KO	RTICK	
		POLE BAND, ANNEALED & GALVANIZED N	FG CO	
103	VARIES	WOOD POLE EYEBOLT	METRO STD S	A-103

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3	DR:	SCALE:
3	TMB	NONE
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5.5° TO 7.5° CURVE SPAN WITH 4 FOOT CURVE RAILS TWO-WAY TRAFFIC

DATE:
OCT 95
FILE
DWG. NO.
SA-308
SHT 2 OF 2



- 1. A POLE COLLAR OR POLE EYEBOLT IS REQUIRED PER SA-102 OR SA-103 UNLESS A BUILDING EYEBOLT ATTACHMENT IS USED. INSTALLATION HEIGHT IS INDICATED ON THE OVERHEAD DRAWINGS.
- 2. PROVIDE TENSION ADJUSTMENT POINTS AT LOCATIONS INDICATED BY "♥". PROVIDE WIRE ROPE CLIPS AT THESE LOCATIONS. SEE SA-166.
- 3. SEE SA-370 FOR LIMITED SPACE VARIANCES.
- 4. SEE SA-164 FOR VERTICAL & HORIZONTAL DIMENSIONS TO TROLLEY WIRE.
- 5. MAXIMUM ANGLE IS 0.5°. SEE SA-307, PLAN VIEW.

	MATERIAL LIST				
ITEM #	QTY	DESCRIPTION	MANUFACTURER	CAT. NO.	
01	6	DETROIT CLAMP ASSY	WABCO	19293-3007	
02	6	AGC TANGENT SPAN HANGER	WABCO	19360-2000	
03	4	GUY STRAIN INSUL	PORCELAIN	504	
			PRODUCTS CO.		
04	9	GUY GRIP DEADEND	PREFORMED	CDE-3106	
05 06	2	WIRE ROPE CLIP, 5/16"	CROSBY	G450	
06	AS REQD	FRICTION TAPE, 3/4" (6 WRAPS)			
07	2	THIMBLE, 3/8" XHD, OPEN	CROSBY	G414	
08 VARIES GUY STRAND		COPPERWELD	8M		
07 08 102	VARIES	FORGED THREE-PIECE ADJUSTABLE KC	RTICK		
			FG CO		
103	VARIES	WOOD POLE EYEBOLT	METRO STD	SA-103	
DESIGNED CHKD: DEPARTMENT OF TRANSPORTATION				DATE:	

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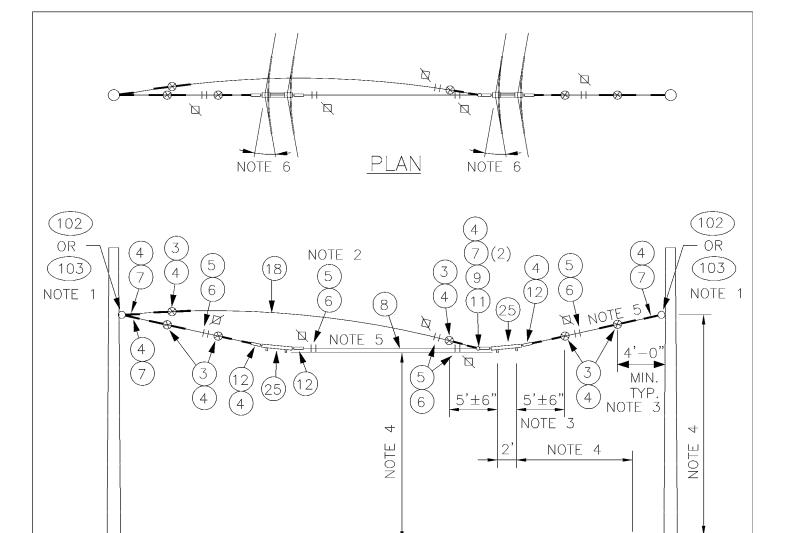
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DEPARTMENT OF TRANSPORTATION TROLLEY STANDARDS

TANGENT SPAN THREE TRACKS

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SA-		30	9
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1. A POLE COLLAR OR POLE EYEBOLT IS REQUIRED PER SA-102 OR SA-103 UNLESS A BUILDING EYEBOLT ATTACHMENT IS USED. INSTALLATION HEIGHT IS INDICATED ON THE OVERHEAD DRAWINGS.

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- 2. PROVIDE TENSION ADJUSTMENT POINTS AT LOCATIONS INDICATED BY "\(\Delta\)". PROVIDE WIRE ROPE CLIPS AT THESE LOCATIONS. SEE SA-166.
- 3. SEE SA-371 FOR LIMITED SPACE VARIANCES. SEE SA-167 FOR INSULATED GUY CRITERIA.
- 4. SEE SA-164 FOR VERTICAL & HORIZONTAL DIMENSIONS TO TROLLEY WIRE.
- 5. INSIDE PULLOFF MAY NOT BE REQUIRED, SEE DRAWINGS FOR EACH INSTALLATION.
- 6. ANGLE VARIES FROM 8° TO 30°.

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DEPARTMENT OF TRANSPORTATION TROLLEY STANDARDS

8° TO 30° CURVE SPAN WITH CURVE SEGMENTS TWO-WAY TRAFFIC

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ITEM #	QTY	DESCRIPTION	MANUFACTURER	CAT. NO.
03	6	GUY STRAIN INSUL	PORCELAIN	504
			PRODUCTS CO	
04	15	GUY GRIP DEADEND	PREFORMED	CDE-3106
05	10	WIRE ROPE CLIP, 5/16"	CROSBY	G450
06	AS	FRICTION TAPE, 3/4" (6 WRAPS)		
07	REQD	THIMBLE, 3/8" XHD, OPEN	CROSBY	G414
08	5	GUY STRAND	COPPERWELD	8M
09	VARIES	BULL RING	WABCO	18567-2000
12	1	7/8 TRANSLITE STRAIN INSUL CL-CL	WABCO	54975-6120
18	1	7/8 TRANSLITE STRAIN INSUL CL-EYE	WABCO	55339-6120
25	3	GUY STRAND, COVERED	COPPERWELD	8M
	VARIES	CURVE SEGMENT 8-12 DEG TYPE C	WABCO	22301-3014
	VARIES	CURVE SEGMENT 13-27 DEG TYPE C	WABCO	22302-3005
	SEE	CURVE SEGMENT 28-47 DEG TYPE C	WABCO	22303-3005
	PLAN	FORGED THREE-PIECE ADJUSTABLE POLE	KORTICK	
102	VARIES	BAND, ANNEALED & GALVANIZED	MFG CO	
103	VARIES	WOOD POLE EYEBOLT	METRO STD	SA-103
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MATERIAL LIST


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DEPARTMENT OF TRANSPORTATION TROLLEY STANDARDS

8° TO 30° CURVE SPAN WITH CURVE SEGMENTS TWO-WAY TRAFFIC

DATE:
OCT 95
FILE
DWG. NO.
SA - 310
SHT 2 OF 2



- 1. A POLE COLLAR OR POLE EYEBOLT IS REQUIRED PER SA-102 OR SA-103 UNLESS A BUILDING EYEBOLT ATTACHMENT IS USED. INSTALLATION HEIGHT IS INDICATED ON THE OVERHEAD DRAWINGS.
- 2. PROVIDE TENSION ADJUSTMENT POINTS AT LOCATIONS INDICATED BY "\"\".
 PROVIDE WIRE ROPE CLIPS AT THESE LOCATIONS. SEE SA-166.
- 3. SEE SA-370 FOR LIMITED SPACE VARIANCES.
- 4. SEE SA-164 FOR VERTICAL & HORIZONTAL DIMENSIONS TO TROLLEY WIRE.
- 5. MAXIMUM ANGLE IS 0.5°. SEE SA-317 PLAN VIEW.

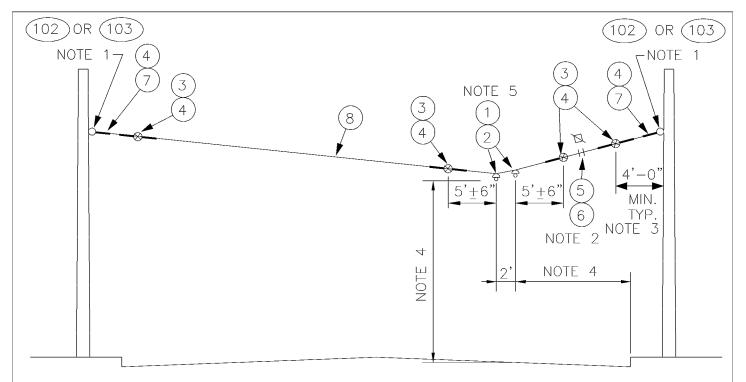	MATERIAL LIST				
ITEM #	QTY	DESCRIPTION	MANUFACTURER	CAT. NO.	
01	2	DETROIT CLAMP ASSY	WABCO	19293-3007	
02	2	AGC TANGENT SPAN HANGER	WABCO	19360-2000	
03	4	GUY STRAIN INSUL	PORCELAIN	504	
			PRODUCTS CO.		
04	9	GUY GRIP DEADEND	PREFORMED	CDE-3106	
05	2	WIRE ROPE CLIP, 5/16"	CROSBY	G450	
06	AS REQD	FRICTION TAPE, 3/4" (6 WRAPS)			
07	10	THIMBLE, 3/8" XHD, OPEN	CROSBY	G414	
08	VARIES	GUY STRAND	COPPERWELD	8M	
102	VARIES	FORGED THREE-PIECE ADJUSTABLE	KORTICK		
103		POLE BAND, ANNEALED & GALVANIZED	MFG CO		
103	VARIES	WOOD POLE EYEBOLT	METRO STD	SA-103	
DEPARTMENT OF TRANSPORTATION DATE:			DATE:		

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King County

DEPARTMENT OF TRANSPORTATION TROLLEY STANDARDS

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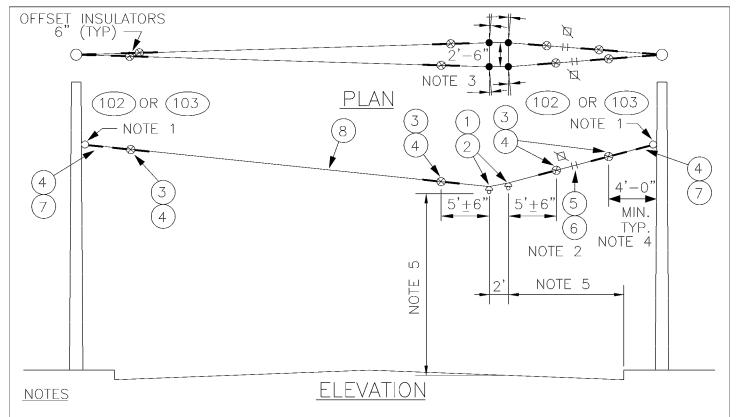
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DWG. NO.

SA-311

SHT 1 OF 1



- 1. A POLE COLLAR OR POLE EYEBOLT IS REQUIRED PER SA-102 OR SA-103 UNLESS A BUILDING EYEBOLT ATTACHMENT IS USED. INSTALLATION HEIGHT IS INDICATED ON THE OVERHEAD DRAWINGS.
- 2. PROVIDE TENSION ADJUSTMENT POINTS AT LOCATIONS INDICATED BY " $\mbox{$\mathbb{Q}$}$ ". PROVIDE WIRE ROPE CLIPS AT THESE LOCATIONS. SEE SA-166.
- 3. MAXIMUM ANGLE 1°, 0.5° PER SPAN HANGER.
- 4. SEE SA-370 FOR LIMITED SPACE VARIANCES.

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CONTRACT:

NONE

King County

5. SEE SA-164 FOR VERTICAL & HORIZONTAL DIMENSIONS TO TROLLEY WIRE.

	MATERIAL LIST				
ITEM #	QTY	DESCRIPTION	MANUFACTURER	CAT. NO.	
01	4	DETROIT CLAMP ASSY	WABCO	19293-3007	
02	4	AGC TANGENT SPAN HANGER	WABCD	19360-2000	
03	8	GUY STRAIN INSUL	PORCELAIN	504	
			PRODUCTS CO.		
04	18	GUY GRIP DEADEND	PREFORMED	CDE-3106	
05	4	WIRE ROPE CLIP, 5/16"	CROSBY	G450	
06	AS REQD	FRICTION TAPE, 3/4" (6 WRAPS)			
07	4	THIMBLE, 3/8" XHD, OPEN	CROSBY	G414	
08	VARIES	GUY STRAND	COPPERWELD	8M	
102	VARIES	FORGED THREE-PIECE ADJUSTABLE	KORTICK		
		POLE BAND, ANNEALED & GALVANIZED	MFG CD		
103	VARIES	WOOD POLE EYEBOLT	METRO STD	SA-103	
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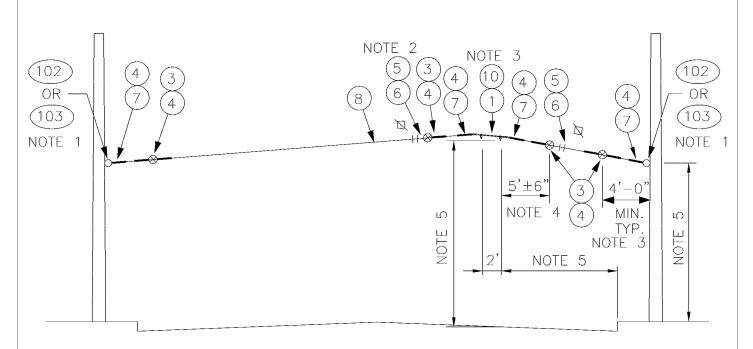
HOLDUP TANGENT SPAN

ONE-WAY TRAFFIC

FILE

DWG. NO.

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- 1. A POLE COLLAR OR POLE EYEBOLT IS REQUIRED PER SA-102 OR SA-103 UNLESS A BUILDING EYEBOLT ATTACHMENT IS USED. INSTALLATION HEIGHT IS INDICATED ON THE OVERHEAD DRAWINGS.
- 2. PROVIDE TENSION ADJUSTMENT POINTS AT LOCATIONS INDICATED BY "\(\bigvee\)". PROVIDE WIRE ROPE CLIPS AT THESE LOCATIONS. SEE SA-166.
- 3. MAXIMUM ANGLE 0.5°. SEE SA-317, PLAN VIEW.
- 4. SEE SA-370 FOR LIMITED SPACE VARIANCES.
- 5. SEE SA-164 FOR VERTICAL & HORIZONTAL DIMENSIONS TO TROLLEY WIRE.

	MATERIAL LIST				
ITEM #	QTY	DESCRIPTION	MANUFACTURER	CAT. NO.	
01	2	DETROIT CLAMP ASSY	WABCO	19293-3007	
03	4	GUY STRAIN INSUL	PORCELAIN PRODUCTS CO.	504	
04	10	GUY GRIP DEADEND	PREFORMED	CDE-3106	
05	4	WIRE ROPE CLIP, 5/16"	CROSBY	G450	
06	AS REQD	FRICTION TAPE, 3/4" (6 WRAPS)			
07	4	THIMBLE, 3/8" XHD, OPEN	CROSBY	G414	
08	VARIES	GUY STRAND	COPPERWELD	8M	
10	1	HI-LITE DOUBLE CURVE HANGER	WABCD	54962-3001	
102	VARIES	FORGED THREE-PIECE ADJUSTABLE	KORTICK		
		POLE BAND, ANNEALED & GALVANIZED	MFG CO		
103	VARIES	WOOD POLE EYEBOLT METRO STD SA-103		SA-103	
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TMB NONE

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DEPARTMENT OF TRANSPORTATION TROLLEY STANDARDS

INVERTED TANGENT SPAN ONE—WAY TRAFFIC DATE:
OCT 95
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DWG. NO.
SA — 313
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- A POLE COLLAR OR POLE EYEBOLT IS REQUIRED PER SA-102 OR SA-103 UNLESS A 1. BUILDING EYEBOLT ATTACHMENT IS USED. INSTALLATION HEIGHT IS INDICATED ON THE OVERHEAD DRAWINGS.
- PROVIDE TENSION ADJUSTMENT POINTS AT LOCATIONS INDICATED BY "". 2. PROVIDE WIRE ROPE CLIPS AT THESE LOCATIONS. SEE SA-166.
- MAXIMUM ANGLE 1 DEGREE. 0.5° PER DOUBLE CURVE HANGER. 3.
- SEE SA-370 FOR LIMITED SPACE VARIANCES. 4.
- 5. SEE SA-164 FOR VERTICAL & HORIZONTAL DIMENSIONS TO TROLLEY WIRE.

	MATERIAL LIST				
ITEM #	QTY	DESCRIPTION	MANUFACTURER	CAT. NO.	
01	4	DETROIT CLAMP ASSY	WABCO	19293-3007	
03	00	GUY STRAIN INSUL	PORCELAIN	504	
			PRODUCTS CO.		
04	20	GUY GRIP DEADEND	PREFORMED	CDE-3106	
05	8	WIRE ROPE CLIP, 5/16"	CROSBY	G450	
06	AS REQD	FRICTION TAPE, 3/4" (6 WRAPS)			
07	8	THIMBLE, 3/8" XHD, OPEN	CROSBY	G414	
08	VARIES	GUY STRAND	COPPERWELD	8M	
10	N	HI-LITE DOUBLE CURVE HANGER	WABCO	54962-3001	
102	VARIES	FORGED THREE-PIECE ADJUSTABLE	KORTICK		
		POLE BAND, ANNEALED & GALVANIZED	MFG CO		
103	VARIES	WOOD POLE EYEBOLT	METRO STD	SA-103	
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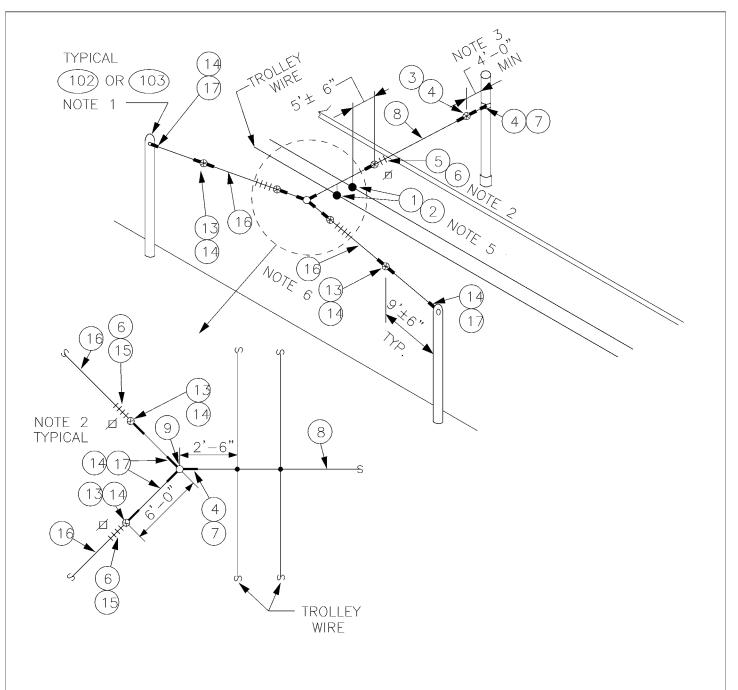
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DEPARTMENT OF TRANSPORTATION TROLLEY STANDARDS

HOLDDOWN TANGENT SPAN ONE-WAY TRAFFIC

OCT 95 FILE DWG. NO. SA - 314OF



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	TMB	NONE	
5	RECOM.	CONTRACT:	
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BRIDLE TANGENT SPAN ONE—WAY TRAFFIC

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JUN 95
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DWG. NO.
SA-315
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	MATERIAL LIST				
ITEM #	QTY	DESCRIPTION	MANUFACTURER	CAT. NO.	
01	2	DETROIT CLAMP ASSY	WABCD	19293-3007	
02	2	AGC TANGENT SPAN HANGER	WABCO	19360-2000	
03	VARIES	GUY STRAIN INSUL	PORCELAIN	504	
			PRODUCTS CO.		
04	VARIES	GUY GRIP DEADEND	PREFORMED	CDE-3106	
05	VARIES	WIRE ROPE CLIP, 5/16"	CROSBY	G450	
06	AS REQD	FRICTION TAPE, 3/4" (6 WRAPS)			
07	VARIES	THIMBLE, 3/8" XHD, OPEN	CROSBY	G414	
08	VARIES	GUY STRAND	COPPERWELD	8M	
09	1	BULL RING	WABCO	18567-2000	
13	VARIES	GUY STRAIN INSUL	PORCELAIN	506	
			PRODUCTS CO.		
14	VARIES	GUY GRIP DEADEND	PREFORMED	CDE-3115	
15	VARIES	WIRE ROPE CLIP, 3/8"	CROSBY	G450	
16	VARIES	GUY STRAND	COPPERWELD	16M	
17	VARIES	THIMBLE, 1/2" XHD, OPEN	CROSBY	G414	
102	VARIES	FORGED THREE-PIECE ADJUSTABLE	KORTICK		
		POLE BAND, ANNEALED & GALVANIZED	MFG CO		
103	VARIES	WOOD POLE EYEBOLT	METRO STD	SA-103	

- 1. A POLE COLLAR OR POLE EYEBOLT IS REQUIRED PER SA-102 OR SA-103 UNLESS A BUILDING EYEBOLT ATTACHMENT IS USED. INSTALLATION HEIGHT IS INDICATED ON THE OVERHEAD DRAWINGS.
- 2. PROVIDE TENSION ADJUSTMENT POINTS AT LOCATIONS INDICATED BY "□".
 PROVIDE WIRE ROPE CLIPS AT THESE LOCATIONS. SEE SA-166.
- 3. SEE SA-370 FOR LIMITED SPACE VARIANCES.
- 4. SEE SA-164 FOR VERTICAL & HORIZONTAL DIMENSIONS TO TROLLEY WIRE.
- 5. MAXIMUM ANGLE IS 0.5°. SEE SA-307, PLAN VIEW.
- 6. IF LOAD SHOWN ON OVERHEAD DRAWINGS IS LESS THAN 2500 LBS, THEN ITEM 8 MAY BE USED INSTEAD OF ITEM 16. THE ASSOCIATED ITEMS SHALL ALSO BE CHANGED I.E. 3 FOR 13, 4 FOR 14, 5 FOR 15 AND 7 FOR 17.


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DEPARTMENT OF TRANSPORTATION TROLLEY STANDARDS

BRIDLE TANGENT SPAN ONE—WAY TRAFFIC

DATE:
OCT 95
FILE
DWG. NO.
SA-315



DESIGNED CHKD: DOW DPG DR: SCALE: NONE TMB CONTRACT: RECOM. APPROVED

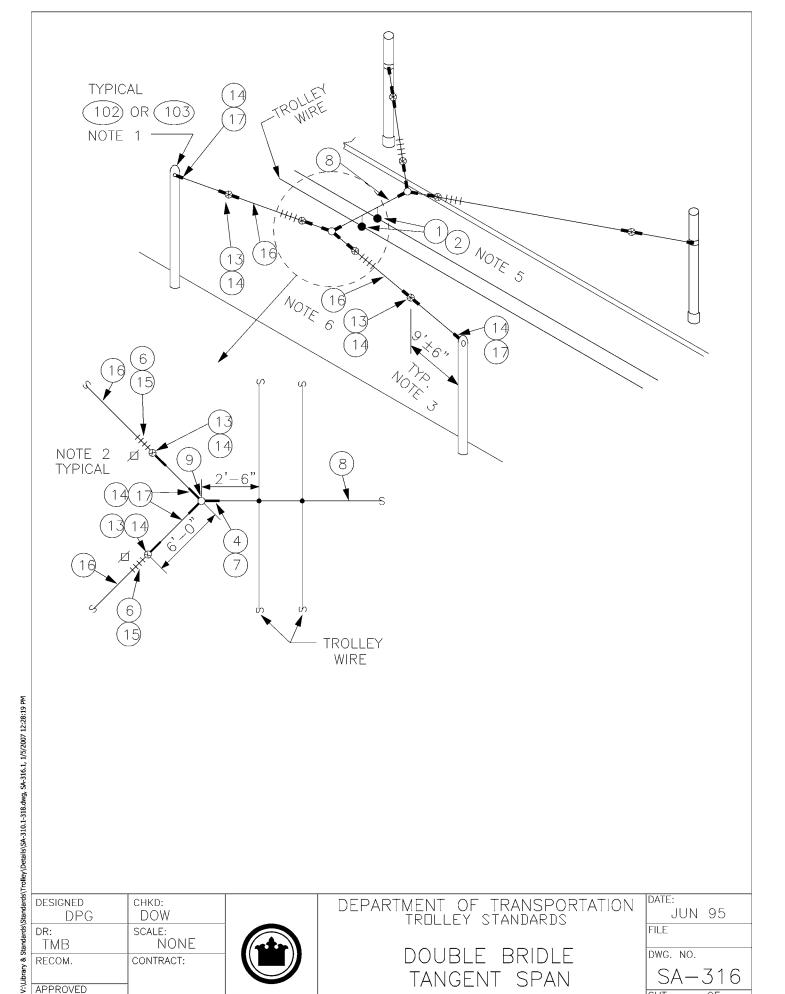

DEPARTMENT OF TRANSPORTATION TROLLEY STANDARDS

DOUBLE BRIDLE TANGENT SPAN ONE-WAY TRAFFIC

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JUN 95
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DWG. NO.
SA-316
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	MATERIAL LIST				
ITEM #	QTY	DESCRIPTION	MANUFACTURER	CAT. NO.	
01	2	DETROIT CLAMP ASSY	WABCO	19293-3007	
02	2	AGC TANGENT SPAN HANGER	WABCO	19360-2000	
03	VARIES	GUY STRAIN INSUL	PORCELAIN PRODUCTS CO.	504	
04	VARIES	GUY GRIP DEADEND	PREFORMED	CDE-3106	
05	VARIES	WIRE ROPE CLIP, 5/16"	CROSBY	G450	
06	AS REQD	FRICTION TAPE, 3/4" (6 WRAPS)			
07	VARIES	THIMBLE, 3/8" XHD, OPEN	CROSBY	G414	
08	VARIES	GUY STRAND	COPPERWELD	8M	
09	2	BULL RING	WABCO	18567-2000	
13	VARIES	GUY STRAIN INSUL	PORCELAIN PRODUCTS CO.	506	
14	VARIES	GUY GRIP DEADEND	PREFORMED	CDE-3115	
15	VARIES	WIRE ROPE CLIP, 3/8"	CROSBY	G450	
16	VARIES	GUY STRAND	COPPERWELD	16M	
17	VARIES	THIMBLE, 1/2" XHD, OPEN	CROSBY	G414	
102	VARIES	FORGED THREE-PIECE ADJUSTABLE	KORTICK		
		POLE BAND, ANNEALED & GALVANIZED	MFG CD		
103	VARIES	WOOD POLE EYEBOLT	METRO STD	SA-103	

- 1. A POLE COLLAR OR POLE EYEBOLT IS REQUIRED PER SA-102 OR SA-103 UNLESS A BUILDING EYEBOLT ATTACHMENT IS USED. INSTALLATION HEIGHT IS INDICATED ON THE OVERHEAD DRAWINGS.
- 2. PROVIDE TENSION ADJUSTMENT POINTS AT LOCATIONS INDICATED BY " \Q ". PROVIDE WIRE ROPE CLIPS AT THESE LOCATIONS. SEE SA-166.
- 3. SEE SA-370 FOR LIMITED SPACE VARIANCES.
- 4. SEE SA-164 FOR VERTICAL & HORIZONTAL DIMENSIONS TO TROLLEY WIRE.
- 5. MAXIMUM ANGLE IS 0.5°. SEE SA-307, PLAN VIEW.
- 6. IF LOAD SHOWN ON OVERHEAD DRAWINGS IS LESS THAN 2500 LBS, THEN ITEM 8 MAY BE USED INSTEAD OF ITEM 16. THE ASSOCIATED ITEMS SHALL ALSO BE CHANGED I.E. 3 FOR 13, 4 FOR 14, 5 FOR 15 AND 7 FOR 17.

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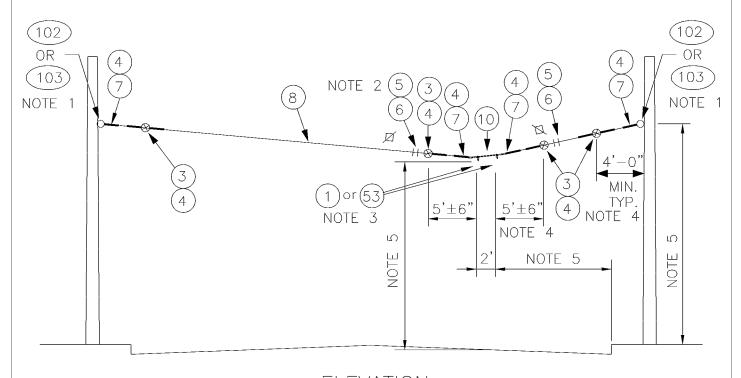
DEPARTMENT OF TRANSPORTATION TROLLEY STANDARDS

DOUBLE BRIDLE TANGENT SPAN ONE—WAY TRAFFIC

DATE:
OCT 95
FILE
DWG. NO.
SA-316
SHT 2 OF 2



PLAN



ELEVATION

NOTES

- 1. A POLE COLLAR OR POLE EYEBOLT IS REQUIRED PER SA-102 OR SA-103 UNLESS A BUILDING EYEBOLT ATTACHMENT IS USED. INSTALLATION HEIGHT IS INDICATED ON THE OVERHEAD DRAWINGS.
- 2. PROVIDE TENSION ADJUSTMENT POINTS AT LOCATIONS INDICATED BY "□".
 PROVIDE WIRE ROPE CLIPS AT THESE LOCATIONS. SEE SA-166.
- 3. ANGLE VARIES FROM 1° TO 5°. USE ITEM 1 FOR 1° TO 2.5° ANGLE. USE ITEM 53 FOR 3° TO 5° ANGLE.
- 4. SEE SA-370 FOR LIMITED SPACE VARIANCES.
- 5. SEE SA-164 FOR VERTICAL & HORIZONTAL DIMENSIONS TO TROLLEY WIRE.

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DEPARTMENT OF TRANSPORTATION TROLLEY STANDARDS

1° TO 5° CURVE SPAN WITH 2 FOOT CURVE RAILS ONE—WAY TRAFFIC

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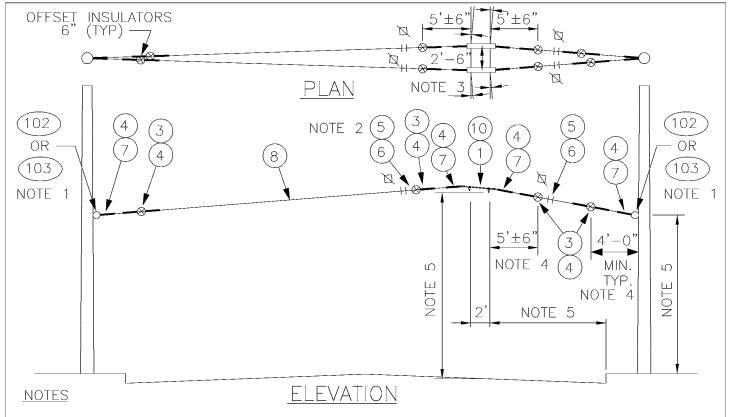
	MATERIAL LIST					
ITEM #	QTY	DESCRIPTION	MANUFACTURER	CAT. NO.		
01	VARIES	DETROIT CLAMP ASSY	WABCO	19293-3007		
03	4	GUY STRAIN INSUL	PORCELAIN	504		
			PRODUCTS CO.			
04	10	GUY GRIP DEADEND	PREFORMED	CDE-3106		
05	4	WIRE ROPE CLIP, 5/16"	CROSBY	G450		
06	AS REQD	FRICTION TAPE, 3/4" (6 WRAPS)				
07	4	THIMBLE, 3/8" XHD, OPEN	CROSBY	G414		
08	VARIES	GUY STRAND	COPPERWELD	8M		
10	1	HI-LITE DOUBLE CURVE HANGER	WABCO	54962-3001		
53	VARIES	CURVE RAIL (1° TO 5° 2 FT LG)	K & M	851 B412/0		
102	VARIES	FORGED THREE-PIECE ADJUSTABLE	KORTICK			
		POLE BAND, ANNEALED & GALVANIZED	MFG CO			
103	VARIES	WOOD POLE EYEBOLT	METRO STD	SA-103		

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1° TO 5° CURVE SPAN WITH 2 FOOT CURVE RAILS ONE—WAY TRAFFIC

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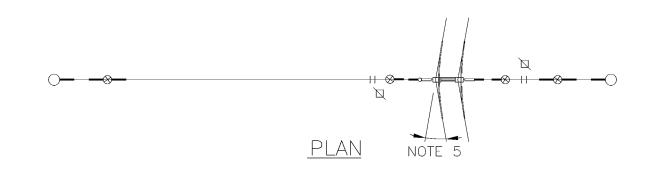
- A POLE COLLAR OR POLE EYEBOLT IS REQUIRED PER SA-102 OR SA-103 UNLESS A 1. BUILDING EYEBOLT ATTACHMENT IS USED. INSTALLATION HEIGHT IS INDICATED ON THE OVERHEAD DRAWINGS.
- PROVIDE TENSION ADJUSTMENT POINTS AT LOCATIONS INDICATED BY "". 2. PROVIDE WIRE ROPE CLIPS AT THESE LOCATIONS. SEE SA-166.
- MAXIMUM ANGLE 1 DEGREE, 0.5° PER DOUBLE CURVE HANGER. 3.
- SEE SA-370 FOR LIMITED SPACE VARIANCES. 4.
- SEE SA-164 FOR VERTICAL & HORIZONTAL DIMENSIONS TO TROLLEY WIRE.


		MATERIAL LIST							
	ITEM # QTY			DESCRIPT	TION		MANUFACTURER	CAT. NO.	
	01	4		DETRE	DIT CLAMP	ASSY		WABCO	19293-3007
	03	8		GUY S	STRAIN INS	UL		PORCELAIN	504
2 PM								PRODUCTS CO.	
12:28:4	04	20		GUY (GRIP DEADE	ND		PREFORMED	CDE-3106
SA-318, 1/5/2007 12:28:42 PM	05	8		WIRE	ROPE CLIP	, 5/16"		CROSBY	G450
18, 1/5	06	AS I	REQD	FRICT	TION TAPE,	3/4″ (6 W	/RAPS)		
						CROSBY	G414		
18.dwg	08	VAR]	ES	GUY S	TRAND			COPPERWELD	8M
10.1-3	10	2		HI-LI	TE DOUBLE	CURVE HAN	IGER	WABCO	54962-3001
IS\SA-3	102	VAR]	ES	FORGE	D THREE-P	IECE ADJUS	TABLE	KORTICK	
\Detail				POLE	BAND, ANNE	EALED & GA	LVANIZED	MFG CO	
Trolley	103	VAR	IES	$W \square \square D$	POLE EYEB	DLT		METRO STD	SA-103
\Standards\	08 VARIES GUY STRAND 10 2 HI-LITE DOUBLE CURVE HANGER 102 VARIES FORGED THREE-PIECE ADJUSTABLE POLE BAND, ANNEALED & GALVANIZED 103 VARIES WOOD POLE EYEBOLT DESIGNED CHKD: DPG DOW DR: TMB NONE RECOM. CONTRACT: APPROVED 08 VARIES GUY STRAND DUBLE CURVE HANGER DDUBLE STRAND TROLLEY ST WITH 4 FOOT (1)		RANSPORTATION ANDARDS	001 93					
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y & Sta				5.5° T	0 7.5° (curve span	DWG. NO.		
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5.5° TO 7.5° CURVE SPAN 4 FOOT CURVE RAILS ONE-WAY TRAFFIC

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<u>NOTES</u>

- 1. A POLE COLLAR OR POLE EYEBOLT IS REQUIRED PER SA-102 OR SA-103 UNLESS A BUILDING EYEBOLT ATTACHMENT IS USED. INSTALLATION HEIGHT IS INDICATED ON THE OVERHEAD DRAWINGS.
- 2. PROVIDE TENSION ADJUSTMENT POINTS AT LOCATIONS INDICATED BY "□".
 PROVIDE WIRE ROPE CLIPS AT THESE LOCATIONS. SEE SA-166.
- 3. SEE SA-370 FOR LIMITED SPACE VARIANCES.
- SEE SA-164 FOR VERTICAL & HORIZONTAL DIMENSIONS TO TROLLEY WIRE.
- 5. ANGLE VARIES FROM 8° TO 30°.

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DEPARTMENT OF TRANSPORTATION TROLLEY STANDARDS

8° TO 30° CURVE SPAN WITH CURVE SEGMENT ONE—WAY TRAFFIC
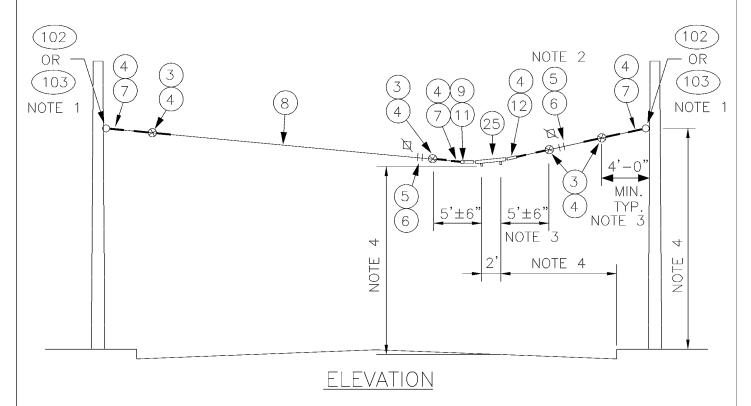
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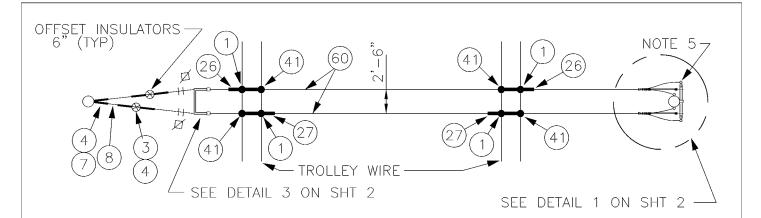
	MATERIAL LIST					
ITEM #	QTY	DESCRIPTION	MANUFACTURER	CAT. NO.		
03	4	GUY STRAIN INSUL	PORCELAIN PRODUCTS CO.	504		
04	10	GUY GRIP DEADEND	PREFORMED	CDE-3106		
05	4	WIRE ROPE CLIP, 5/16"	CROSBY	G450		
06	AS REQD	FRICTION TAPE, 3/4" (6 WRAPS)				
07	4	THIMBLE, 3/8" XHD, OPEN	CROSBY	G414		
08	VARIES	GUY STRAND	COPPERWELD	8M		
12	2	7/8 TRANSLITE STRAIN INSUL CL-EYE	WABCO	55339-6120		
25	VARIES	CURVE SEGMENT 8-12 DEG TYPE C	WABCO	22301-3014		
	(SEE	CURVE SEGMENT 13-27 DEG TYPE C	WABCO	22302-3005		
	PLAN)	CURVE SEGMENT 28-47 DEG TYPE C	WABCO	22303-3005		
102	VARIES	FORGED THREE-PIECE ADJUSTABLE	KORTICK			
		POLE BAND, ANNEALED & GALVANIZED	MFG CO			
103	VARIES	WOOD POLE EYEBOLT	METRO STD	SA-103		

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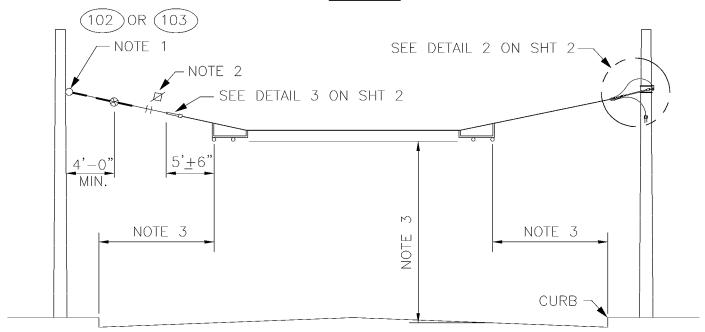


8° TO 30° CURVE SPAN WITH CURVE SEGMENT ONE-WAY TRAFFIC

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NOTES:

- 1. A POLE COLLAR, OR POLE EYEBOLT IS REQUIRED PER SA-102 OR SA-103 UNLESS A BUILDING EYEBOLT ATTACHMENT IS USED. INSTALLATION HEIGHT IS INDICATED ON THE OVERHEAD DRAWINGS.
- 2. PROVIDE TENSION ADJUSTMENT POINTS AT LOCATIONS INDICATED BY "ጆ".
 PROVIDE WIRE ROPE CLIPS AT THESE LOCATIONS. SEE SA−166.
- 3. SEE SA-164 FOR HORIZONTAL & VERTICAL DIMENSIONS TO TROLLEY WIRE.
- 4. CONNECT FEEDER RISER TO FEED SPAN. SEE SA-402.
- 5. INSTALL LIGHTNING ARRESTERS PER SA-401.

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DEPARTMENT OF TRANSPORTATION TROLLEY STANDARDS

DOUBLE FEEDER SPAN
TWO-WAY TRAFFIC

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DOUBLE FEEDER SPAN TWO-WAY TRAFFIC

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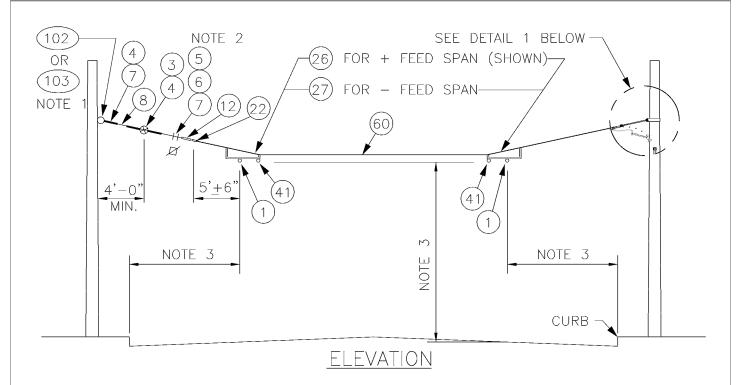
	MATERIAL LIST					
ITEM #	QTY	DESCRIPTION	MANUFACTURE	R CAT. NO.		
01	4	DETROIT CLAMP ASSY	WABCO	19293-3007		
03	2	GUY STRAIN INSUL	PORCELAIN PRODUCTS CO	504		
04	6	GUY GRIP DEADEND	PREFORMED	CDE-3106		
05	4	WIRE ROPE CLIP, 5/16"	CROSBY	G450		
06	AS REQD	FRICTION TAPE, 3/4" (6 WRAPS)	OKOODI			
07	4	THIMBLE, 3/8" XHD, OPEN	CROSBY	G414		
08	VARIES	GUY STRAND	COPPERWELD			
21	2	7/8 TRANSLITE STRAIN INSUL CL-CL		54975-6360		
22	4	CLAMP STRAIN EYE	WABCO	10571-2000		
23	1	7/8 TRANSLITE STRAIN INSUL CL-CL	WABCO 5	4975-6260		
26	2	TYPE PH-4 POS FEED SPAN HANGER	WABCO	54937-3002		
27	2	TYPE PH-5 NEG FEED SPAN HANGER	WABCO	54936-3002		
40	2	7/8 TRANSLITE STRAIN INSUL CL-90	WABCO 5	54995-6120		
41	4	H.S.P. FEEDER CLAMP ASSY, BRONZE	WABCO	19879-2000		
60	AS REQD	FEED SPAN CABLE 500 KCM CU, UN-				
		SHIELDED, 5 KV EPR W/ PVC JACKET				
70	2	EYEBOLT, 5/8" X 6"				
		W/2 NUTS & LOCKWASHER				
80	AS REQD	3/4" X 0.030" SS BANDING TYPE 201		206		
100	VARIES	EPOXIROD DEADEND ARM	CHANCE	0653-1023		
101	2	STRAIN PLATE	METRO STD	SA-101		
102	VARIES	FORGED THREE-PIECE ADJUSTABLE				
		POLE BAND, ANNEALED & GALVANIZED				
103	VARIES	WOOD POLE EYEBOLT	METRO STD	SA-103		
401		LIGHTNING ARRESTER	METRO STD	SA-401		
402	AS REQD	FEEDER RISER	METRO STD	\$A-402		


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DOUBLE FEEDER SPAN TWO-WAY TRAFFIC

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- 1. A POLE COLLAR, OR POLE EYEBOLT IS REQUIRED PER SA-102 OR SA-103 UNLESS A BUILDING EYEBOLT ATTACHMENT IS USED. INSTALLATION HEIGHT IS INDICATED ON THE OVERHEAD DRAWINGS.
- 2. PROVIDE TENSION ADJUSTMENT POINTS AT LOCATIONS INDICATED BY " \square ". PROVIDE WIRE ROPE CLIPS AT THESE LOCATIONS. SEE SA-166.
- SEE SA-164 FOR HORIZONTAL & VERTICAL DIMENSIONS TO TROLLEY WIRE.
- 4. CONNECT FEEDER RISER TO FEED SPAN. SEE SA-402.
- 5. INSTALL LIGHTNING ARRESTERS PER SA-401.

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DEPARTMENT OF TRANSPORTATION TROLLEY STANDARDS

SINGLE FEEDER SPAN TWO-WAY TRAFFIC

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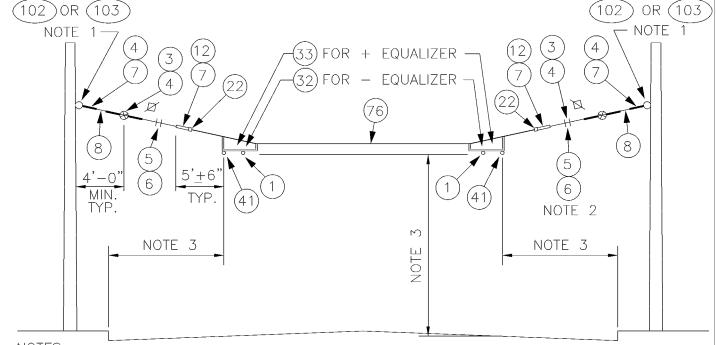
	MATERIAL LIST					
ITEM #	QTY	DESCRIPTION	MANUFACTURER	CAT. NO.		
01	2	DETROIT CLAMP ASSY	WABCO	19293-3007		
03	1	GUY STRAIN INSUL	PORCELAIN PRODUCTS CO	504		
04	3	GUY GRIP DEADEND	PREFORMED	CDE-3106		
05	2	WIRE ROPE CLIP, 5/16"	CROSBY	G450		
06	AS REQD	FRICTION TAPE, 3/4" (6 WRAPS)				
07	2	THIMBLE, 3/8" XHD, OPEN	CROSBY	G414		
08	VARIES	GUY STRAND	COPPERWELD	8M		
12	3	7/8 TRANSLITE STRAIN INSUL CL-EYE	WABCO	55339-6120		
21	1	7/8 TRANSLITE STRAIN INSUL CL-CL	WABCO	54975-6360		
22	2	CLAMP STRAIN EYE	WABCO	10571-2000		
26	2/0	TYPE PH-4 POS FEED SPAN HANGER	WABCO	54937-3002		
27	0/2	TYPE PH-5 NEG FEED SPAN HANGER	WABCO	54936-3002		
41	2	H.S.P. FEEDER CLAMP ASSY, BRONZE	WABCO	19879-2000		
60	AS REQD	FEED SPAN CABLE 500 KCM CU, UNSHIELDED 5 KV EPR W/ PVC JACKET				
102	VARIES	FORGED THREE-PIECE ADJUSTABLE POLE	KORTICK			
		BAND, ANNEALED & GALVANIZED	MFG CO			
103	VARIES	WOOD POLE EYEBOLT	METRO STD	SA-103		
401	AS REQD	LIGHTNING ARRESTER	METRO STD	SA-401		
402	AS REQD	FEEDER RISER	METRO STD	SA-402		
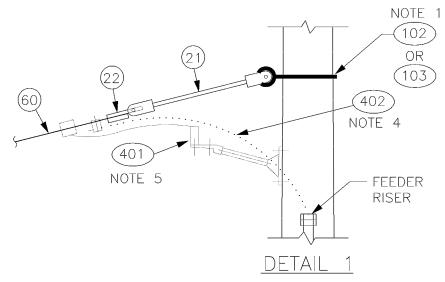
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SINGLE FEEDER SPAN TWO-WAY TRAFFIC

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- A POLE COLLAR OR POLE EYEBOLT IS REQUIRED PER SA-102 OR SA-103 UNLESS A BUILDING EYEBOLT ATTACHMENT IS USED. INSTALLATION HEIGHT IS INDICATED ON THE OVERHEAD DRAWINGS.
- PROVIDE TENSION ADJUSTMENT POINTS AT LOCATIONS INDICATED BY "". PROVIDE WIRE ROPE CLIPS AT THESE LOCATIONS. SEE SA-166.
- SEE SA-164 FOR VERTICAL & HORIZONTAL DIMENSIONS TO TROLLEY WIRE. 3.

		MATERIAL LIST		
ITEM	# QTY	DESCRIPTION	MANUFACTURER	CAT. NO.
01	2	DETROIT CLAMP ASSY	WABCO	19293-3007
03	2	GUY STRAIN INSUL	PORCELAIN	504
			PRODUCTS CO	
04	6	GUY GRIP DEADEND	PREFORMED	CDE-3106
05	4	WIRE ROPE CLIP, 5/16"	CROSBY	G450
06	AS REQD	FRICTION TAPE, 3/4" (6 WRAPS)		
07	4	THIMBLE, 3/8" XHD, OPEN	CROSBY	G414
08	VARIES	GUY STRAND	COPPERWELD	8M
12 22 32 33	2	7/8 TRANSLITE STRAIN INSUL CL-EYE	WABCO	55339-6120
22	2	CLAMP STRAIN EYE	WABCO	10571-2000
32	2/0	TYPE PH-4 POS FEED SPAN HANGER	WABCO	54936-3001
33	0/2	TYPE PH-5 NEG FEED SPAN HANGER	WABCO	54937-3001
41	2	HSP FEEDER CLAMP ASSY, BRONZE	WABCO	19879-2000
76	AS REQD	% STRANDED INSUL CABLE		
102	VARIES	FORGED THREE-PIECE ADJUSTABLE POLE	KORTICK	
		BAND, ANNEALED & GALVANIZED	MFG CO	
102	VARIES	WOOD POLE EYEBOLT	METRO STD	SA-103
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NOTES:

- 1. A POLE COLLAR, OR POLE EYEBOLT IS REQUIRED PER SA-102 OR SA-103 UNLESS A BUILDING EYEBOLT ATTACHMENT IS USED. INSTALLATION HEIGHT IS INDICATED ON THE OVERHEAD DRAWINGS.
- PROVIDE TENSION ADJUSTMENT POINTS AT LOCATIONS INDICATED BY "

 PROVIDE WIRE ROPE CLIPS AT THESE LOCATIONS. SEE SA−166.
- 3. SEE SA-164 FOR HORIZONTAL & VERTICAL DIMENSIONS TO TROLLEY WIRE.
- 4. CONNECT FEEDER RISER TO FEED SPAN. SEE SA-402.
- 5. INSTALL LIGHTNING ARRESTERS PER SA-401.

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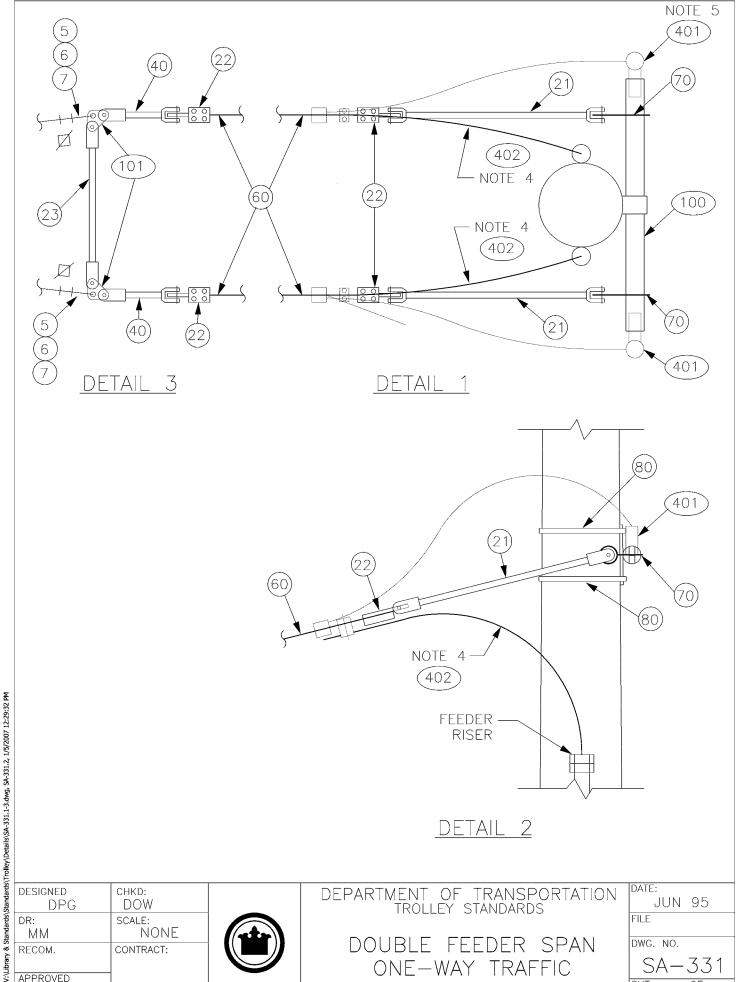
DEPARTMENT OF TRANSPORTATION TROLLEY STANDARDS

DOUBLE FEEDER SPAN ONE-WAY TRAFFIC

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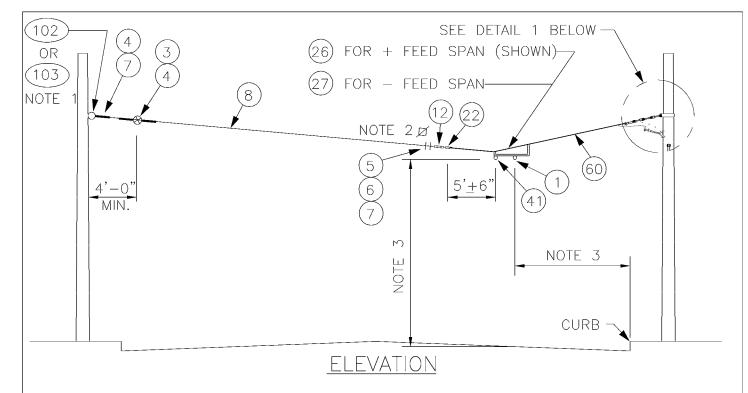
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ITEM #	QTY	DESCRIPTION	MANUFACTURER	CAT. NO.
01	2	DETROIT CLAMP ASSY	WABCO	19293-3007
03	3	GUY STRAIN INSUL	PORCELAIN PRODUCTS CO.	504
04	10	GUY GRIP DEADEND	PREFORMED	CDE-3106
05	4	WIRE ROPE CLIP, 5/16"	CROSBY	G450
06	AS REQD	FRICTION TAPE, 3/4" (6 WRAPS)		
07	6	THIMBLE, 3/8" XHD, OPEN	CROSBY	G414
08	VARIES	GUY STRAND	COPPERWELD	8M
09	1	BULL RING	WABCO	18567-2000
21	2	7/8 TRANSLITE STRAIN INSUL CL-CL	WABCO	54975-6360
22	4	CLAMP STRAIN EYE	WABCO	10571-2000
23	1	7/8 TRANSLITE STRAIN INSUL CL-CL	WABCO	54975-6260
26	1	TYPE PH-4 POS FEED SPAN HANGER	WABCO	54937-3002
27	1	TYPE PH-5 NEG FEED SPAN HANGER	WABCO	54936-3002
40	2	7/8 TRANSLITE STRAIN INSUL CL-90	WABCO	54995-6120
41	2	H.S.P. FEEDER CLAMP ASSY, BRONZE	WABCO	19879-2000
60	AS REQD	FEED SPAN CABLE 500 KCM CU,		
		UNSHIELDED, 5KV EPR W/ PVC JACKET		
70	2	EYEBOLT, 5/8" x 6", WITH		
		2 NUTS & LOCKWASHER		
80	AS REQD	3/4" x 0.03" SS BANDING TYPE 201	BAND-IT	C206
100	VARIES	EPOXIROD DEADEND ARM	CHANCE	C653-1023
101	2	STRAIN PLATE	METRO STD	SA-101
102	VARIES	FORGED THREE-PIECE ADJUSTABLE	KORTICK	
		POLE BAND, ANNEALED & GALVANIZED	MFG CO	
103	VARIES	WOOD POLE EYEBOLT	METRO STD	SA-103
401	AS REQD	LIGHTNING ARRESTER	METRO STD	SA-401
402	AS REQD	FEEDER RISER	METRO STD	SA-402


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DOUBLE FEEDER SPAN ONE—WAY TRAFFIC

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- 1. A POLE COLLAR, OR POLE EYEBOLT IS REQUIRED PER SA-102 OR SA-103 UNLESS A BUILDING EYEBOLT ATTACHMENT IS USED. INSTALLATION HEIGHT IS INDICATED ON THE OVERHEAD DRAWINGS.
- 2. PROVIDE TENSION ADJUSTMENT POINTS AT LOCATIONS INDICATED BY "□".
 PROVIDE WIRE ROPE CLIPS AT THESE LOCATIONS. SEE SA-166.
- 3. SEE SA-164 FOR HORIZONTAL & VERTICAL DIMENSIONS TO TROLLEY WIRE.
- 4. CONNECT FEEDER RISER TO FEED SPAN. SEE SA-402.
- 5. INSTALL LIGHTNING ARRESTERS PER SA-401.

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DEPARTMENT OF TRANSPORTATION TROLLEY STANDARDS

SINGLE FEEDER SPAN ONE—WAY TRAFFIC

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SHT 1 OF 2

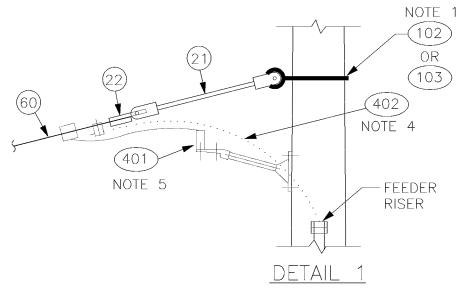ITEM #	QTY	DESCRIPTION	MANUFACTURER	CAT. NO.
01	1	DETROIT CLAMP ASSY	WABCO	19293-3007
03	1	GUY STRAIN INSUL	PORCELAIN	504
			PRODUCTS CO.	
04	3	GUY GRIP DEADEND	PREFORMED	CDE-3106
05	2	WIRE ROPE CLIP, 5/16"	CROSBY	G450
06	AS REQD	FRICTION TAPE, 3/4" (6 WRAPS)		
07	2	THIMBLE, 3/8" XHD, OPEN	CROSBY	G414
08	VARIES	GUY STRAND	COPPERWELD	8M
12	1	7/8 TRANSLITE STRAIN INSUL CL-EYE	WABCO	55339-6120
21	1	7/8 TRANSLITE STRAIN INSUL CL-CL	WABCO	54975-6360
22	2	CLAMP STRAIN EYE	WABCO	10571-2000
26	1/0	TYPE PH-4 POS FEED SPAN HANGER	WABCO	54937-3002
27	0/1	TYPE PH-5 NEG FEED SPAN HANGER	WABCO	54936-3002
41	1	H.S.P. FEEDER CLAMP ASSY, BRONZE	WABCO	19879-2000
60	AS REQD	FEED SPAN CABLE 500 KCM CU,		
		UNSHIELDED, 5KV EPR W/ PVC JACKET		
102	VARIES	FORGED THREE—PIECE ADJUSTABLE	KORTICK	
		POLE BAND, ANNEALED & GALVANIZED	MFG CO	
103	VARIES	WOOD POLE EYEBOLT	METRO STD	SA-103
401	AS REQD	LIGHTNING ARRESTER	METRO STD	SA-401
402	AS REQD	FEEDER RISER	METRO STD	SA-402

3. INSTALL LIGHTNING ARRESTERS PER SA-401. MATERIAL LIST


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DEPARTMENT OF TRANSPORTATION TROLLEY STANDARDS

SINGLE FEEDER SPAN ONE-WAY TRAFFIC

DATE:
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SA - 333

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ONE-WAY TRAFFIC

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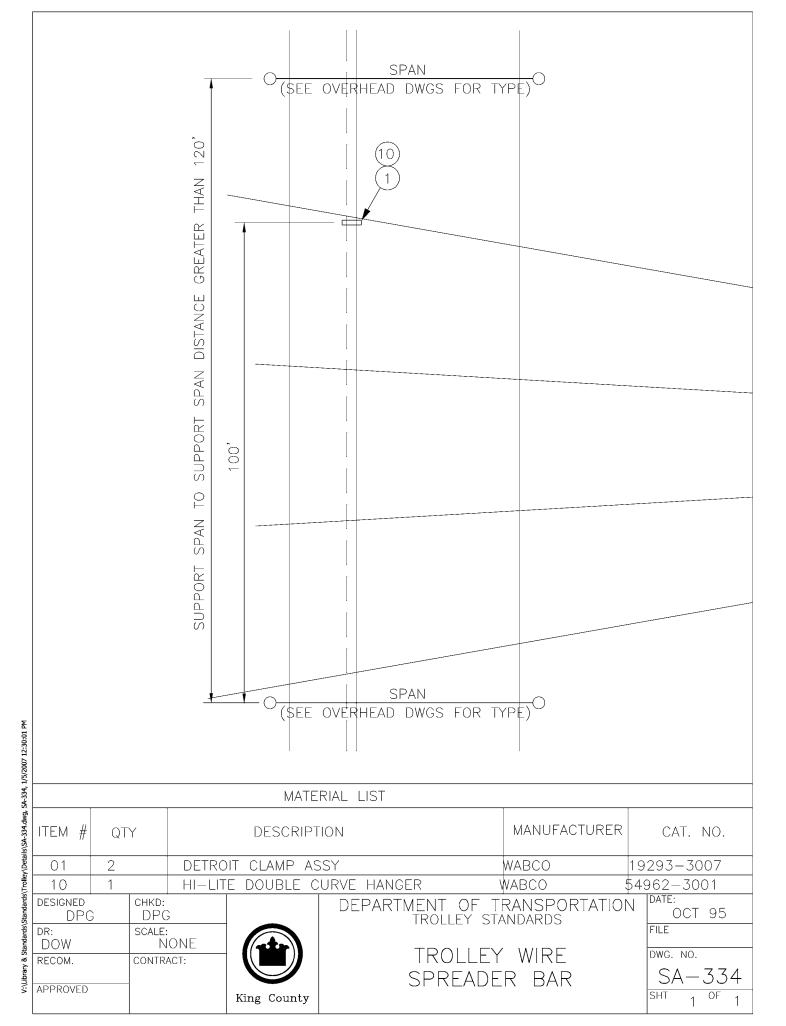
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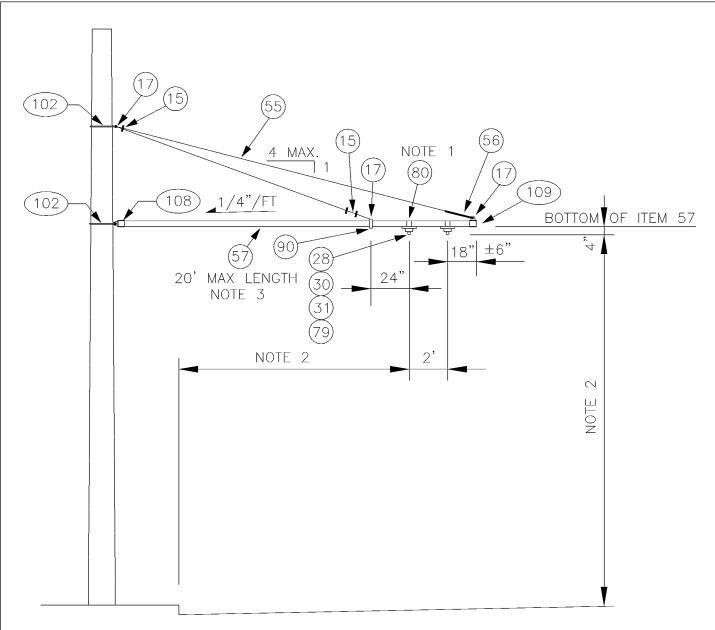
CONTRACT:

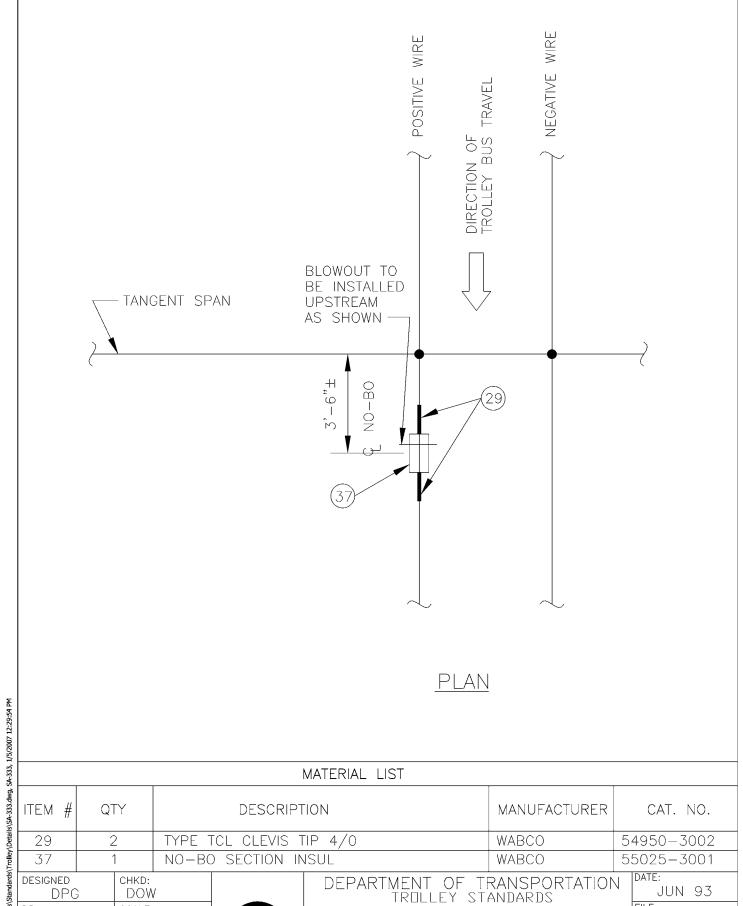NONE

King County

SCALE:





- 1. STAINLESS STEEL BANDING SHALL BE WRAPPED DOUBLE THICKNESS AROUND ITEM 57 PRIOR TO CLAMPING.
- 2. SEE SA-164 FOR HORIZONTAL & VERTICAL DIMENSIONS TO TROLLEY WIRE.
- 3. DRILL 1/2" HOLE IN TUBE TO MATCH HOLE IN ITEMS 108 & 109 FOR INSERTION OF 3/8" SS BOLT.

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DEPARTMENT OF TRANSPORTATION TROLLEY STANDARDS

STEEL POLE
BRACKET ASSEMBLY
TANGENT CONSTRUCTION

DATE:
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FILE
DWG. NO.
SA - 341
SHT 1 OF 2

MATERIAL LIST

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ITEM #	QTY	DESCRIPTION	MANUFACTURER	CAT. NO.
15	3	WIRE ROPE CLIP, 3/8"	CROSBY	G450
17	3	THIMBLE, 1/2" XHD, OPEN	CROSBY	G414
28	2	INSULATOR SPOOL	WABCO	16835-2000
30	2	TROLLEY SUPPORT-LARGE PIPE ARMS	WABC□	54940-4001
31	2	SPRING DETROIT CLAMP	WABCO	54959-3001
55	VARIES	PHILLYSTRAN (3/8")	PHILLYSTRAN	HPTG 6700I
			INC.	
56	1	PHILLYSTRAN BIG GRIP	PHILLYSTRAN	PLP 2755
			INC.	
57	VARIES	FIBERGLASS REINFORCED PLASTIC	MORRISON	EXTREN
		(FRP) TUBE 3 1/2" Ø X 1/2"	MOLDED FG	SERIES 525
79	2	5/8″-11 UNC X 1 3/8″ STUD		
80	VARIES	3/4" STAINLESS STEEL BANDING	BAND-IT	TYPE 201
90	1	HEAVY PIPE CLAMP, GALV, 3" IPS	GRINNELL	FIG. 216
102	2	FORGED THREE-PIECE ADJUSTABLE	KORTICK	
		POLE BAND, ANNEALED & GALVANIZED	MFG CO	
108	1	MAST ARM POLE END CAP	METRO STD	SA-108
109	1	MAST ARM ARM END CAP	METRO STD	SA-109


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DEPARTMENT OF TRANSPORTATION TROLLEY STANDARDS

STEEL POLE
BRACKET ASSEMBLY
TANGENT CONSTRUCTION

DATE:
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- 1. USE ITEMS 4,7,10,11 & 53 WHEN ANGLE VARIES FROM 1° TO 5°. USE ITEMS 4,7, 10,11 & 54 WHEN ANGLE VARIES FROM 5° TO 7.5°. USE ITEMS 12, 25, & 40 WHEN ANGLE IS GREATER THAN 8°. SEGMENTS SHALL NOT BE USED FOR ANGLES GREATER THAN 12° WHEN POLE IS ON INSIDE OF CURVE.
- 2. PROVIDE TENSION ADJUSTMENT POINTS AT LOCATIONS INDICATED BY " $\mbox{$\scalebox{$\scalebox{$\sim$}}$}$ ". PROVIDE WIRE ROPE CLIPS AT THESE LOCATIONS. SEE SA-166.
- 3. SEE SA-164 FOR HORIZONTAL & VERTICAL DIMENSIONS TO TROLLEY WIRE.
- 4. DRILL 1/2" HOLE IN TUBE TO MATCH HOLE IN ITEMS 108 & 110 FOR INSERTION OF 3/8" SS BOLT.
- 5. LEVEL CURVE HANGER (ITEM 10) BY ADJUSTING HANGER ARMS.

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STEEL POLE
BRACKET ASSEMBLY
CURVE CONSTRUCTION

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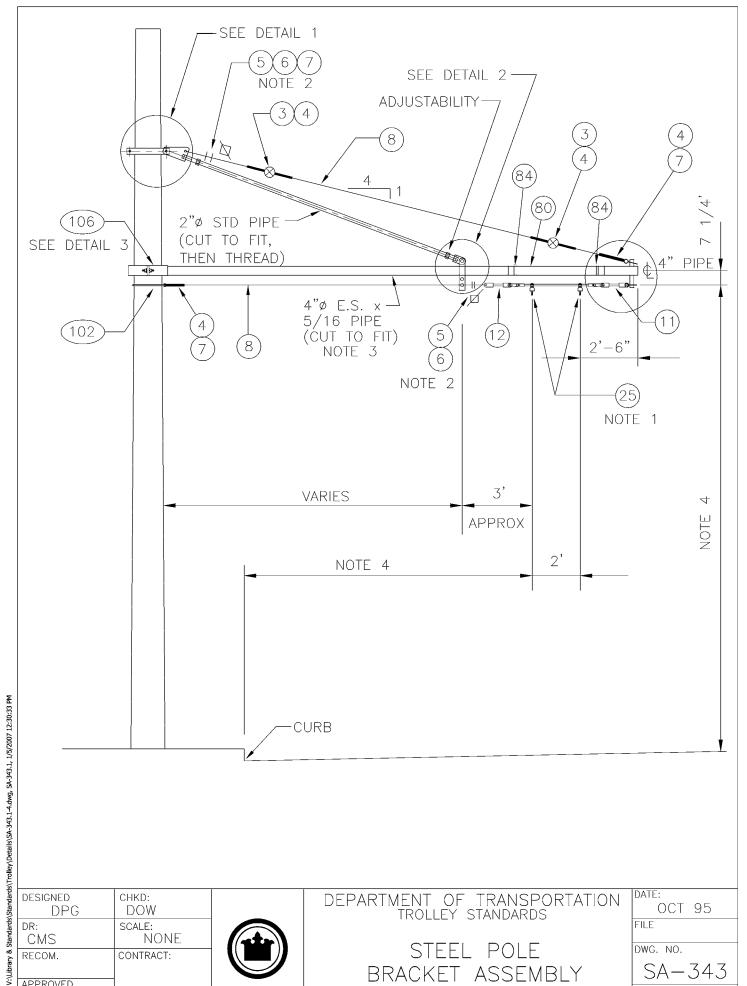
MATERIAL LIST				
ITEM #	QTY	DESCRIPTION	MANUFACTURER	CAT. NO.
03	2	GUY STRAIN INSUL	PORCELAIN PRODUCTS CO.	504
04	VARIES	GUY GRIP DEADEND	PREFORMED	CDE-3106
05	2	WIRE ROPE CLIP, 5/16"	CROSBY	G450
06	AS REQD	FRICTION TAPE, 3/4" (6 WRAPS)		
07	VARIES	THIMBLE, 3/8" XHD, OPEN	CROSBY	G414
08	VARIES	GUY STRAND	COPPERWELD	8M
10	VARIES	HI-LITE DOUBLE CURVE HANGER	WABCO	54962-3001
1 1	VARIES	7/8 TRANSLITE STRAIN INSUL CL-CL	WABCO	54975-6120
12	VARIES	7/8 TRANSLITE STRAIN INSUL CL-EYE	WABCO	55339-6120
15	3	WIRE ROPE CLIP, 3/8"	CROSBY	G450
17	2	THIMBLE, 1/2" XHD, OPEN	CROSBY	G414
25	VARIES	CURVE SEGMENT 8-12 DEG TYPE C	WABCO	22301-3014
	SEE	CURVE SEGMENT 13-27 DEG TYPE C	WABCO	22302-3005
	PLAN	CURVE SEGMENT 28-47 DEG TYPE C	WABCO	22303-3005
40	VARIES	7/8 TRANSLITE STRAIN INSUL CL-90	WABCO	54995-6120
53	VARIES	CURVE RAIL (1° TO 5° 2 FT LG)	K & M	851 B412/0
54	VARIES	CURVE RAIL (5.5° TO 7.5° 4 FT LG)	K & M	851 B412/1
55	VARIES	PHILLYSTRAN (3/8")	PHILLYSTRAN INC.	HPTG 6700I
56	1	PHILLYSTRAN BIG GRIP	PHILLYSTRAN INC.	PLP 2755
57	VARIES	FIBERGLASS REINFORCED PLASTIC	STRONGWELL	EXTREN
		(FRP) TUBE 5" Ø X 1/4"		SERIES 525
90	1	HEAVY PIPE CLAMP, GALV	GRINNELL	FIG. 216
102	3	FORGED THREE-PIECE ADJUSTABLE	KORTICK	
		POLE BAND, ANNEALED & GALVANIZED	MFG CO	
108	1	MAST ARM POLE END CAP	METRO STD	SA-108
110	1	MAST ARM UNDERSLING END CAP	METRO STD	SA-110
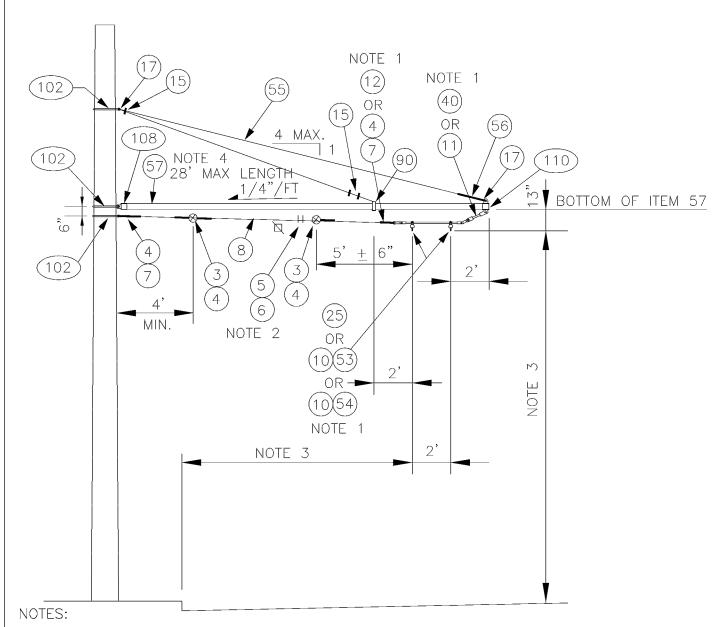
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STEEL POLE
BRACKET ASSEMBLY
CURVE CONSTRUCTION

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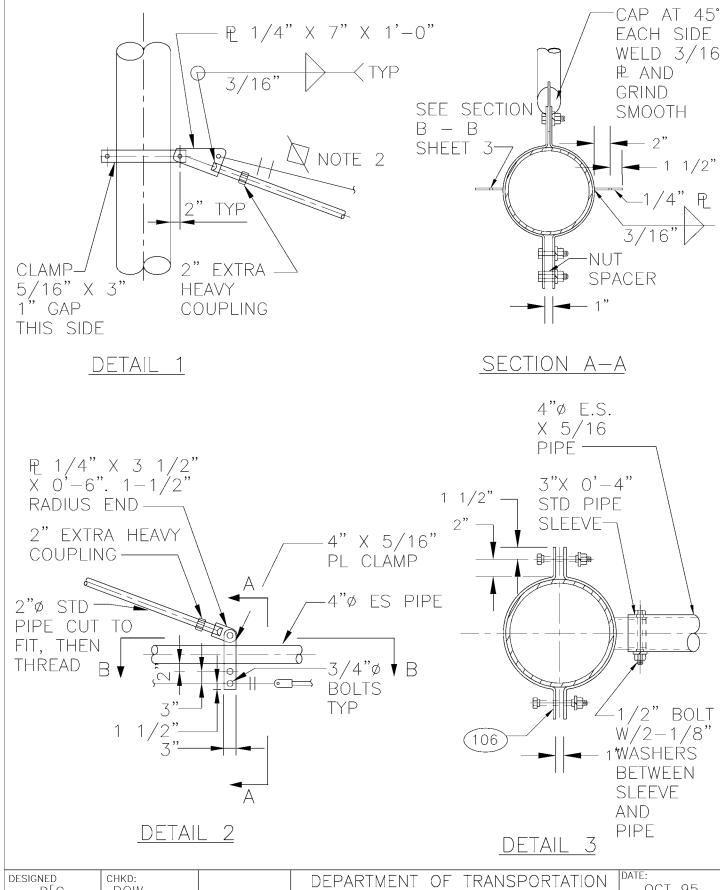


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DEPARTMENT OF TRANSPORTATION TROLLEY STANDARDS

DATE:
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SA - 343
SHT 1 OF 4




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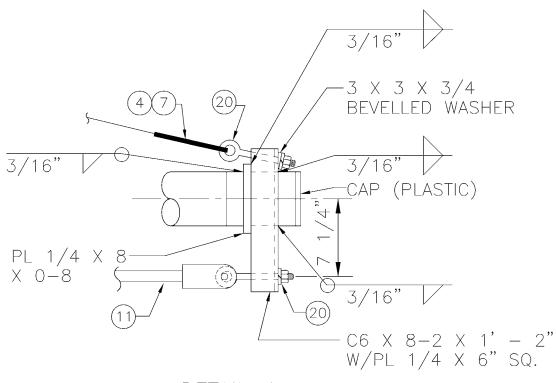


TROLLEY STANDARDS

DATE:
OCT 95
FILE
DWG. NO.
SA-343
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SECTION B-B

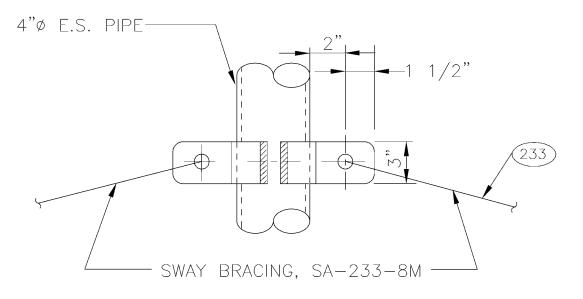

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DEPARTMENT OF TRANSPORTATION TROLLEY STANDARDS

DATE:
OCT 95
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DWG. NO.
SA - 343
SHT 3 OF 1
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MATERIAL LIST				
ITEM #	QTY	DESCRIPTION	MANUFACTURER	CAT. NO.
03 2 GUY STRAIN INSUL PORCELAIN 50 PRODUCTS CO.		504		
04	6	GUY GRIP DEADEND	PREFORMED	CDE-3106
05	4	WIRE ROPE CLIP, 5/16"	CROSBY	G450
06	AS REQD	FRICTION TAPE, 3/4" (6 WRAPS)		
07	3	THIMBLE, 3/8" XHD, OPEN	CROSBY	G414
08	VARIES	GUY STRAND	COPPERWELD	8M
		54975-6120		
		55339-6120		
20	2	EYEBOLT	WABC□	11933-2000
80	VARIES	3/4" STAINLESS STEEL BANDING	BAND-IT	TYPE 201
84	4 LF	SCHED 40 PVC, GREY, SPLIT		
102	VARIES	FORGED THREE-PIECE ADJUSTABLE	KORTICK	
		POLE BAND, ANNEALED & GALVANIZED	MFG CO	
106	1	COMPRESSION POLE BRACKET COLLAR	METRO STD	SA-106
233	2	SWAY BRACING, SA-233-8M	METRO STD	SA-233

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- 1. OVERHEAD DRAWINGS TO INDICATE CURVE SEGMENT TO BE INSTALLED. MAXIMUM ANGLE OF CURVE SEGMENT IS 35 DEGREES. MAXIMUM CHANGE IN STREET GRADIENT IS $\pm 5\%$
- 2. PROVIDE TENSION ADJUSTMENT POINT AT LOCATION INDICATED BY "□".
 PROVIDE WIRE ROPE CLIPS AT THIS LOCATION. SEE SA-166.
- 3. THE PIPE BRACKET SHALL BE 4" DIAMETER EXTRA STRONG ASTM A53, GRADE B GALVANIZED STEEL PIPE.

MAXIMUM PIPE LENGTH IS 18 FT.


4. SEE SA-164 FOR HORIZONTAL AND VERTICAL DIMENSIONS TO THE TROLLEY WIRE.

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DEPARTMENT OF TRANSPORTATION TROLLEY STANDARDS

DATE:
OCT 95
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DWG. NO.
SA-343
SHT 1 OF 1



- 1. DRILL 1/2" HOLE IN TUBE TO MATCH HOLE IN ITEMS 108 & 110 FOR INSERTION OF 3/8" SS BOLT.
- 2. PROVIDE TENSION ADJUSTMENT POINTS AT LOCATIONS INDICATED BY " $\cup$$ ". PROVIDE WIRE ROPE CLIPS AT THESE LOCATIONS. SEE SA-166.
- 3. SEE SA-164 FOR HORIZONTAL & VERTICAL DIMENSIONS TO TROLLEY WIRE.
- 4. HANG CLAMP (ITEM 1) VERTICAL BY ADJUSTING SPAN HANGER (ITEM 2).
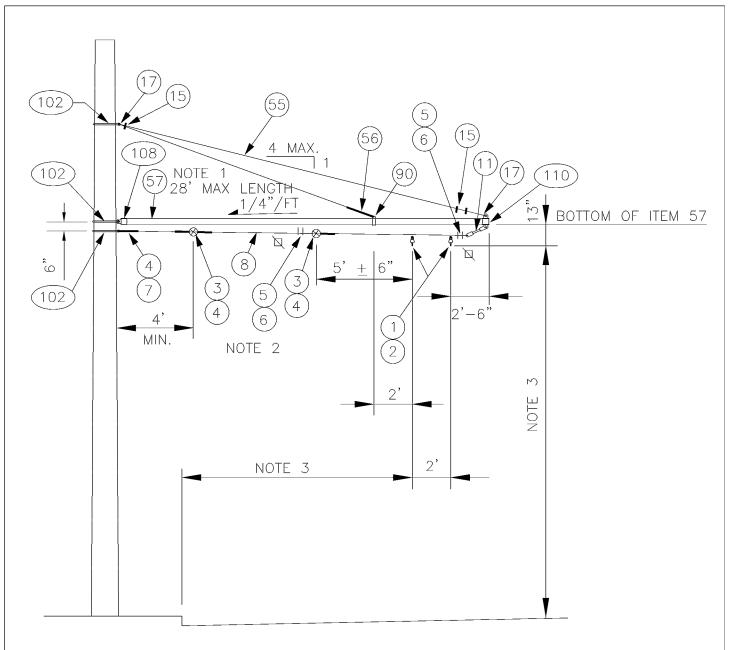
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DEPARTMENT OF TRANSPORTATION TROLLEY STANDARDS

STEEL POLE
BRACKET ASSEMBLY
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01	2	DETROIT CLAMP ASSY	WABCO	19293-3007
02	2	AGC TANGENT SPAN HANGER	WABCO	19360-2000
03	2	GUY STRAIN INSUL	PORCELAIN	504
			PRODUCTS CO.	
04	4	GUY GRIP DEADEND	PREFORMED	CDE-3106
05	4	WIRE ROPE CLIP, 5/16"	CROSBY	G450
06	AS REQD	FRICTION TAPE, 3/4" (6 WRAPS)		
07	1	THIMBLE, 3/8" XHD, OPEN	CROSBY	G414
08	VARIES	GUY STRAND	COPPERWELD	8M
1 1	1	7/8 TRANSLITE STRAIN INSUL CL-CL	WABCO	54975-6120
15	3	WIRE ROPE CLIP, 3/8"	CROSBY	G450
17	2	THIMBLE, 1/2" XHD, OPEN	CROSBY	G414
55	VARIES	PHILLYSTRAN (3/8")	PHILLYSTRAN	HPTG 6700I
			INC.	
56	1	PHILLYSTRAN BIG GRIP	PHILLYSTRAN	PLP 2755
			INC.	
57	VARIES	FIBERGLASS REINFORCED PLASTIC	STRONGWELL	EXTREN
		(FRP) TUBE 5" Ø X 1/4"		SERIES 525
90	1	HEAVY PIPE CLAMP, GALV	GRINNELL	FIG. 216
102	3	FORGED THREE-PIECE ADJUSTABLE	KORTICK	
		POLE BAND, ANNEALED & GALVANIZED	MFG CO	
108	1	MAST ARM POLE END CAP	METRO STD	SA-108
110	1	MAST ARM UNDERSLING END CAP	METRO STD	SA-110

MATERIAL LIST

DESCRIPTION

MANUFACTURER

CAT. NO.

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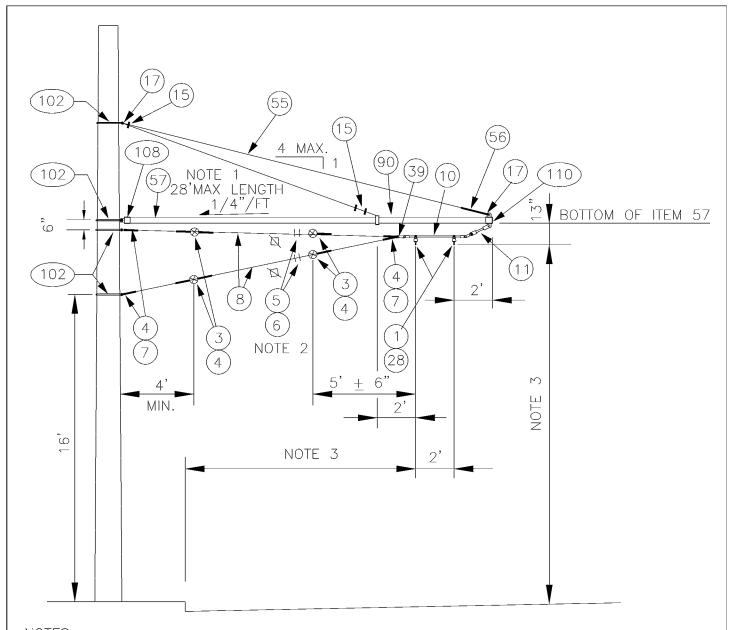
DEPARTMENT OF TRANSPORTATION TROLLEY STANDARDS

STEEL POLE BRACKET ASSEMBLY UNDERSLING CONSTRUCTION

DATE:
MARCH 00
FILE
DWG. NO.
SA - 345
SHT 2 OF 2

ITEM #

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- 1. DRILL 1/2" HOLE IN TUBE TO MATCH HOLE IN ITEMS 108 & 110 FOR INSERTION OF 3/8" SS BOLT.
- 2. PROVIDE TENSION ADJUSTMENT POINTS AT LOCATIONS INDICATED BY "□".
 PROVIDE WIRE ROPE CLIPS AT THESE LOCATIONS. SEE SA-166.
- 3. SEE SA-164 FOR HORIZONTAL & VERTICAL DIMENSIONS TO TROLLEY WIRE.
- 4. LEVEL CURVE HANGER(ITEM 10) BY ADJUSTING HANGER ARMS.

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DEPARTMENT OF TRANSPORTATION TROLLEY STANDARDS

STEEL POLE
HOLDDOWN BRACKET ASSEMBLY
TANGENT CONSTRUCTION

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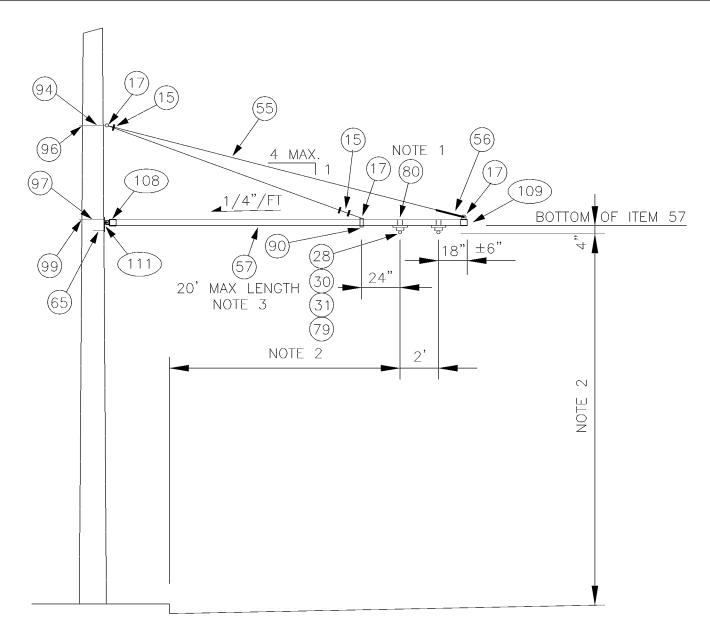
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ITEM #	QTY	DESCRIPTION	MANUFACTURER	CAT. NO.
01	2	DETROIT CLAMP ASSY	WABCO	19293-3007
03	4	GUY STRAIN INSUL	PORCELAIN PRODUCTS CO.	504
04	10	GUY GRIP DEADEND	PREFORMED	CDE-3106
05	4	WIRE ROPE CLIP, 5/16"	CROSBY	G450
06	AS REQD	FRICTION TAPE, 3/4" (6 WRAPS)		
07	4	THIMBLE, 3/8" XHD, OPEN	CROSBY	G414
08	VARIES	GUY STRAND	COPPERWELD	8M
10	1	HI-LITE DOUBLE CURVE HANGER	WABCD	54962-3001
1 1	1	7/8 TRANSLITE STRAIN INSUL CL-CL	WABCD	54975-6120
15	3	WIRE ROPE CLIP, 3/8"	CROSBY	G450
17	2	THIMBLE, 1/2" XHD, OPEN	CROSBY	G414
28	2	INSULATOR SPOOL	WABCD	16835-2000
39	1	5/8" SHACKLE	WABCD	13722-2000
55	VARIES	PHILLYSTRAN (3/8")	PHILLYSTRAN INC.	HPTG 6700I
56	1	PHILLYSTRAN BIG GRIP	PHILLYSTRAN INC.	PLP 2755
57	VARIES	FIBERGLASS REINFORCED PLASTIC (FRP) TUBE 5" Ø X 1/4"	STRONGWELL	EXTREN SERIES 525
90	1	HEAVY PIPE CLAMP, GALV	GRINNELL	FIG. 216
102	4	FORGED THREE-PIECE ADJUSTABLE	KORTICK	
		POLE BAND, ANNEALED & GALVANIZED	MFG CD	
108	1	MAST ARM POLE END CAP	METRO STD	SA-108
110	1	MAST ARM UNDERSLING END CAP	METRO STD	SA-110

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STEEL POLE HOLDDOWN BRACKET ASSEMBLY TANGENT CONSTRUCTION

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	SHT 2 OF 2



- 1. STAINLESS STEEL BANDING SHALL BE WRAPPED DOUBLE THICKNESS AROUND ITEM 57 PRIOR TO CLAMPING.
- 2. SEE SA-164 FOR HORIZONTAL & VERTICAL DIMENSIONS TO TROLLEY WIRE.
- 3. DRILL 1/2" HOLE IN TUBE TO MATCH HOLE IN ITEMS 108 & 109 FOR INSERTION OF 3/8" SS BOLT.

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DEPARTMENT OF TRANSPORTATION TROLLEY STANDARDS

WOOD POLE BRACKET ASSEMBLY TANGENT CONSTRUCTION

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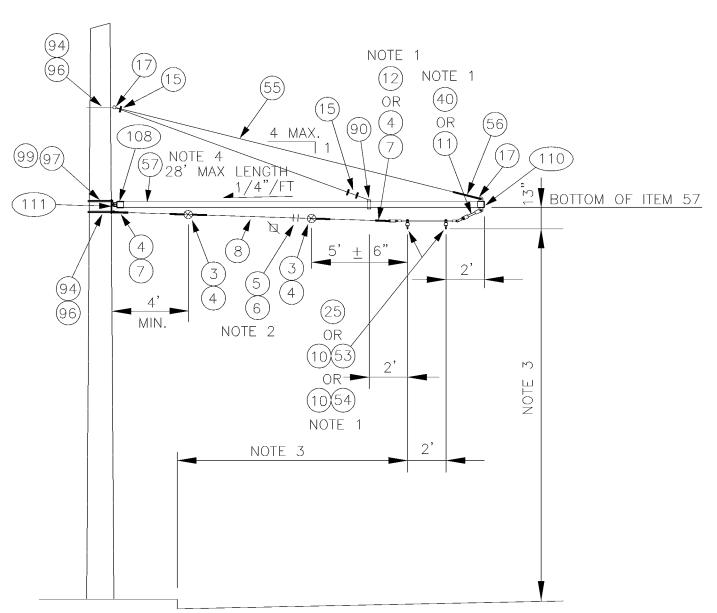
	MATERIAL LIST				
ITEM	# QTY	DESCRIPTION	MANUFACTURER	CAT. NO.	
15	3	WIRE ROPE CLIP, 3/8"	CROSBY	G450	
17	3	THIMBLE, 1/2" XHD, OPEN	CROSBY	G414	
28	2	INSULATOR SPOOL	WABCO	16835-2000	
30	2	TROLLEY SUPPORT-LARGE PIPE ARMS	WABCO	54940-4001	
31	2	SPRING DETROIT CLAMP	WABC□	54959-3001	
55	VARIES	PHILLYSTRAN (3/8")	PHILLYSTRAN	HPTG 6700I	
			INC.		
56 1 PHILLYSTRAN BIG GRIP		PHILLYSTRAN	PLP 2755		
		INC.			
57 VARIES FIBERGLASS REINFORCED PLASTIC		MORRISON	EXTREN		
(FRP) TUBE 3 1/2" Ø X 1/2"		MOLDED FG	SERIES 525		
65	1	LAG SCREW, FETTER DRIVE, 1/2"X 4"	JOSLYN	J8754	
79	2	5/8"-11 UNC X 1 3/8" STUD			
80	VARIES	3/4" STAINLESS STEEL BANDING	BAND-IT	TYPE 201	
90	1	HEAVY PIPE CLAMP, GALV, 3" IPS	GRINNELL	FIG. 216	
94	1	5/8" OVAL EYEBOLT W/ NUT	JOSLYN	J94XX	
96	1	SQ CURVED WASHER 3" X 3" X 1/4",	JOSLYN	J113	
	11/16" DIA				
97	1	3/4" MACHINE BOLT	JOSLYN	J89XX	
99	99 1 SQ CURVED WASHER 3" X 3" X 1/4",		JOSLYN	J6823	
	13/16" DIA				
108	1	MAST ARM POLE END CAP	METRO STD	SA-108	
109	1	MAST ARM ARM END CAP	METRO STD	SA-109	
111	1	WOOD POLE MOUNTING BRACKET	METRO STD	SA-111	

	DESIGNED	CHKD:
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	DR:	SCALE:
	MM	NTS
	RECOM.	CONTRACT:
-	APPROVED	



WOOD POLE BRACKET ASSEMBLY TANGENT CONSTRUCTION

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- 1. USE ITEMS 4,7,10,11 & 53 WHEN ANGLE VARIES FROM 1° TO 5°. USE ITEMS 4,7, 10,11 & 54 WHEN ANGLE VARIES FROM 5° TO 7.5°. USE ITEMS 12, 25, & 40 WHEN ANGLE IS GREATER THAN 8°. SEGMENTS SHALL NOT BE USED FOR ANGLES GREATER THAN 12° WHEN POLE IS ON INSIDE OF CURVE.
- 2. PROVIDE TENSION ADJUSTMENT POINTS AT LOCATIONS INDICATED BY "□".
 PROVIDE WIRE ROPE CLIPS AT THESE LOCATIONS. SEE SA-166.
- 3. SEE SA-164 FOR HORIZONTAL & VERTICAL DIMENSIONS TO TROLLEY WIRE.
- 4. DRILL 1/2" HOLE IN TUBE TO MATCH HOLE IN ITEMS 108 & 110 FOR INSERTION OF 3/8" SS BOLT.
- 5. LEVEL CURVE HANGER (ITEM 10) BY ADJUSTING HANGER ARMS.

designed DPG	CHKD: DOW	
DR: MM	scale: NONE	
RECOM.	CONTRACT:	
APPROVED		King County

DEPARTMENT OF TRANSPORTATION TROLLEY STANDARDS

WOOD POLE
BRACKET ASSEMBLY
CURVE CONSTRUCTION

DATE	:		
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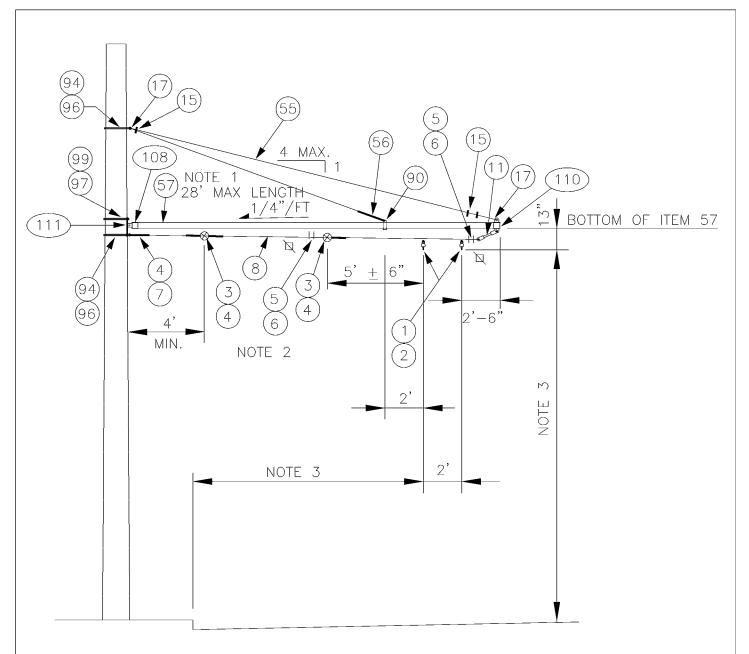
	MATERIAL LIST				
ITEM #	QTY	DESCRIPTION	MANUFACTURER	CAT. NO.	
03	2	GUY STRAIN INSUL	PORCELAIN	504	
			PRODUCTS CO.		
04	VARIES	GUY GRIP DEADEND	PREFORMED	CDE-3106	
05	2	WIRE ROPE CLIP, 5/16"	CROSBY	G450	
06	AS REQD	FRICTION TAPE, 3/4" (6 WRAPS)			
07	VARIES	THIMBLE, 3/8" XHD, OPEN	CROSBY	G414	
08	VARIES	GUY STRAND	COPPERWELD	8M	
10	VARIES	HI-LITE DOUBLE CURVE HANGER	WABCO	54962-3001	
11	VARIES	7/8 TRANSLITE STRAIN INSUL CL-CL	WABCO	54975-6120	
12	VARIES	7/8 TRANSLITE STRAIN INSUL CL-EYE	WABCO	55339-6120	
15	3	WIRE ROPE CLIP, 3/8"	CROSBY	G450	
17	2	THIMBLE, 1/2" XHD, OPEN	CROSBY	G414	
25	VARIES	CURVE SEGMENT 8-12 DEG TYPE C	WABCO	22301-3014	
	SEE	CURVE SEGMENT 13-27 DEG TYPE C	WABCO	22302-3005	
	PLAN	CURVE SEGMENT 28-47 DEG TYPE C	WABCO	22303-3005	
40	VARIES	7/8 TRANSLITE STRAIN INSUL CL-90	WABCO	54995-6120	
53	VARIES	CURVE RAIL (1° TO 5° 2 FT LG)	K & M	851 B412/0	
54	VARIES	CURVE RAIL (5.5° TO 7.5° 4 FT LG)	K & M	851 B412/1	
55	VARIES	PHILLYSTRAN (3/8")	PHILLYSTRAN INC.	HPTG 6700I	
56	1	PHILLYSTRAN BIG GRIP	PHILLYSTRAN	PLP 2755	
			INC.		
57	VARIES	FIBERGLASS REINFORCED PLASTIC	MORRISON	EXTREN	
		(FRP) TUBE 5" Ø X 1/4"	MOLDED FG	SERIES 525	
90	1	HEAVY PIPE CLAMP, GALV	GRINNELL	FIG. 216	
94	2	5/8" OVAL EYEBOLT W/ NUT	JOSLYN	J94XX	
96	2	SQ CURVED WASHER 3" X 3" X 1/4",	JOSLYN	J113	
	11/16" DIA				
97	1	3/4" MACHINE BOLT	JOSLYN	J89XX	
99	1	SQ CURVED WASHER 3" X 3" X 1/4",	JOSLYN	J6823	
	13/16″ DIA				
108	1	MAST ARM POLE END CAP	METRO STD	SA-108	
110	1	MAST ARM UNDERSLING END CAP	METRO STD	SA-110	
111	1	WOOD POLE MOUNTING BRACKET	METRO STD	SA-111	

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WOOD POLE BRACKET ASSEMBLY CURVE CONSTRUCTION

DATE:
MAR 00
FILE
DWG. NO.
SA-352
SHT 2 OF 2



- 1. DRILL 1/2" HOLE IN TUBE TO MATCH HOLE IN ITEMS 108 & 110 FOR INSERTION OF 3/8" SS BOLT.
- 2. PROVIDE TENSION ADJUSTMENT POINTS AT LOCATIONS INDICATED BY "□".
 PROVIDE WIRE ROPE CLIPS AT THESE LOCATIONS. SEE SA-166.
- 3. SEE SA-164 FOR HORIZONTAL & VERTICAL DIMENSIONS TO TROLLEY WIRE.
- 4. HANG CLAMP (ITEM 1) VERTICAL BY ADJUSTING SPAN HANGER (ITEM 2).

	DESIGNED	CHKD:	
1	DPG	AJW	
,	DR:	SCALE:	
	AJW	NONE	
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:	APPROVED		,
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DEPARTMENT OF TRANSPORTATION TROLLEY STANDARDS

WOOD POLE
BRACKET ASSEMBLY
UNDERSLING CONSTRUCTION

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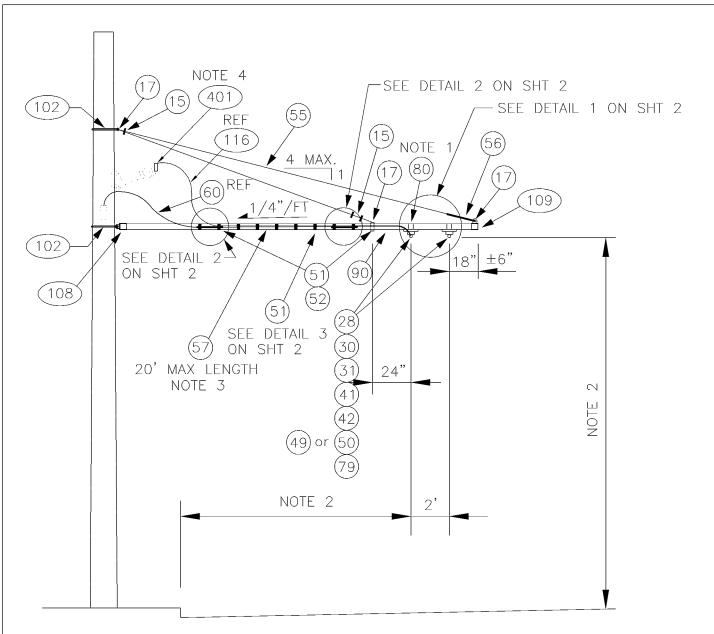
MATERIAL LIST				
ITEM #	ITEM # QTY DESCRIPTION		MANUFACTURER	CAT. NO.
01	O1 2 DETROIT CLAMP ASSY		WABCD	19293-3007
02	2	AGC TANGENT SPAN HANGER	WABCD	19360-2000
03	4	GUY STRAIN INSUL	PORCELAIN	504
			PRODUCTS CO.	
04	10	GUY GRIP DEADEND	PREFORMED	CDE-3106
05	4	WIRE ROPE CLIP, 5/16"	CROSBY	G450
06	AS REQD			
07	4	THIMBLE, 3/8" XHD, OPEN	CROSBY	G414
08	VARIES	GUY STRAND	COPPERWELD	8M
1 1	1	7/8 TRANSLITE STRAIN INSUL CL-CL	WABCO	54975-6120
15	3	WIRE ROPE CLIP, 3/8"	CROSBY	G450
55	VARIES	PHILLYSTRAN (3/8")	PHILLYSTRAN	HPTG 6700I
			INC.	
56	1	PHILLYSTRAN BIG GRIP	PHILLYSTRAN	PLP 2755
			INC.	
57	VARIES	FIBERGLASS REINFORCED PLASTIC	STRONGWELL	EXTREN
		(FRP) TUBE 5" Ø X 1/4"		SERIES 525
90	1	HEAVY PIPE CLAMP, GALV	GRINNELL	FIG. 216
94	2	5/8" OVAL EYEBOLT WITH NUT	JOSLYN	J94XX
96	2	SQ CURVED WASHER 3"×3"×1/4"	JOSLYN	J113
		11/16" DIA		
97	1	3/4" MACHINE BOLT	JOSLYN	J89XX
102	3	FORGED THREE-PIECE ADJUSTABLE	KORTICK	
		POLE BAND, ANNEALED & GALVANIZED	MFG CO	
108	1	MAST ARM POLE END CAP	METRO STD	SA-108
110	1	MAST ARM UNDERSLING END CAP	METRO STD	SA-110
111	1	WOOD POLE MOUNTING BRACKET	METRO STD	SA-111

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WOOD POLE HOLDDOWN BRACKET ASSEMBLY TANGENT CONSTRUCTION

DATE:
MARCH 00
FILE
DWG. NO.
SA-355
SHT 2 OF 2



- 1. STAINLESS STEEL BANDING SHALL BE WRAPPED DOUBLE THICKNESS AROUND ITEM 57 PRIOR TO CLAMPING.
- SEE SA-164 FOR HORIZONTAL & VERTICAL DIMENSIONS TO TROLLEY WIRE.
- 3. DRILL 1/2" HOLE IN TUBE TO MATCH HOLE IN ITEMS 108 & 109 FOR INSERTION OF 3/8" SS BOLT.
- 4. 60, 116 & 401 SHOWN FOR REFERENCE ONLY, SEE SA-401 FOR DETAILS.

 DOUBLE NEGATIVE FEEDER REQUIRES ONLY ONE SA-401.


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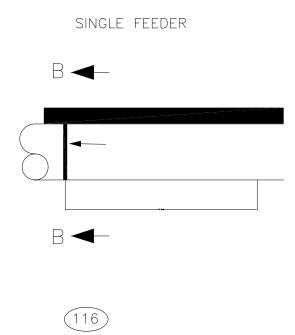



DEPARTMENT OF TRANSPORTATION TROLLEY STANDARDS

STEEL POLE TANGENT FEEDER BRACKET ASSEMBLY

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DEPARTMENT OF TRANSPORTATION TROLLEY STANDARDS

STEEL POLE TANGENT FEEDER BRACKET ASSEMBLY
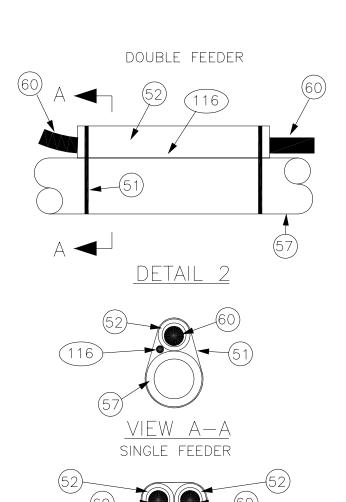
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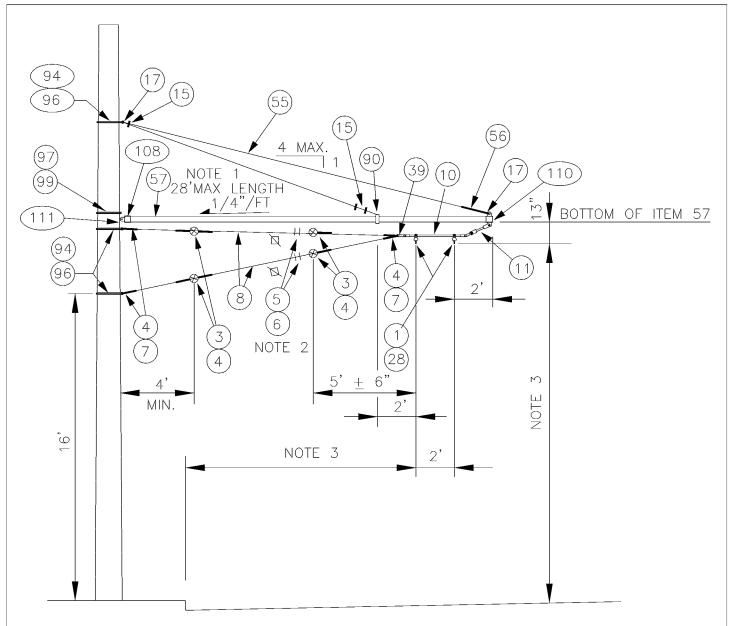
	MATERIAL LIST					
ITEM #	M # QTY DESCRIPTION		MANUFACTURER	CAT. NO.		
15	3	WIRE ROPE CLIP, 3/8"	CROSBY	G450		
17	3	THIMBLE, 1/2" XHD, OPEN	CROSBY	G414		
28	2	INSULATOR SPOOL	WABCO	16835-2000		
30	2	TROLLEY SUPPORT-LARGE PIPE ARMS	WABCD	54940-4001		
31	2	SPRING DETROIT CLAMP	WABCD	54959-3001		
41	VARIES	H.S.P. FEEDER CLAMP ASSY, BRONZE	WABCO	19880-2000		
42	VARIES	FEEDER CLAMP, BRONZE	WABCD	19790-4004		
49	VARIES	COMPRESSION CONNECTOR COPPER-LONG	ANDERSON/	VHCL-		
		BARREL-TIN PLATED-FLARED	SQUARE D	2/0-12BNF		
50	VARIES	COMPRESSION CONNECTOR COPPER-LONG	ANDERSON/	VHCL-		
		BARREL-TIN PLATED-FLARED	SQUARE D	500-12BNF		
51	AS REQD	MULTI-LOK TIES (18") NYLON COATED	BAND-IT	AE714		
52	2 12"	TUF NEOPRENE AIR HOSE SLEEVE	MCMASTER-	3 BRAID		
	PIECES	1.5" ID X 2.0625" DD (BLACK)	CARR			
55	VARIES	PHILLYSTRAN (3/8")	PHILLYSTRAN	HPTG 6700I		
			INC.			
56	1	PHILLYSTRAN BIG GRIP	PHILLYSTRAN INC.	PLP 2755		
57	VARIES	FIBERGLASS REINFORCED PLASTIC	MORRISON	EXTREN		
		(FRP) TUBE 3 1/2″ Ø X 1/2″	MOLDED FG	SERIES 525		
60	AS REQD	FEED SPAN CABLE 500 KCM CU, UN-				
		SHIELDED, 5 KV EPR W/ PVC JACKET				
79	2	5/8"-11 UNC X 1 3/8" STUD				
80	VARIES	3/4" STAINLESS STEEL BANDING	BAND-IT	TYPE 201		
90	1	HEAVY PIPE CLAMP, GALV, 3" IPS	GRINNELL	FIG. 216		
102	2	FORGED THREE-PIECE ADJUSTABLE	KORTICK			
		POLE BAND, ANNEALED & GALVANIZED	MFG CD			
108	1	MAST ARM POLE END CAP	METRO STD	SA-108		
109	1	MAST ARM ARM END CAP	METRO STD	SA-109		
116	VARIES	WIRE, 2 DR 5 KV, #4 AWG CU,				
		JACKETED, UNSHIELDED				

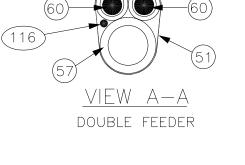	DESIGNED	CHKD:
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	DR:	SCALE:
	TMB	NONE
	RECOM.	CONTRACT:
•	APPROVED	



STEEL POLE TANGENT FEEDER BRACKET ASSEMBLY

DATE:
MAR 97
FILE
DWG. NO.
SA - 349
SHT 3 OF 3



- 1. DRILL 1/2" HOLE IN TUBE TO MATCH HOLE IN ITEMS 108 & 109 FOR INSERTION OF 3/8" SS BOLT.
- 2. PROVIDE TENSION ADJUSTMENT POINTS AT LOCATIONS INDICATED BY " $\mbox{\cap}$ ". PROVIDE WIRE ROPE CLIPS AT THESE LOCATIONS. SEE SA-166.
- 3. SEE SA-164 FOR HORIZONTAL & VERTICAL DIMENSIONS TO TROLLEY WIRE.
- 4. LEVEL CURVE HANGER(ITEM 10) BY ADJUSTING HANGER ARMS.

DESIGNED DPG	CHKD: AJW	_	DEPARTMENT OF TRANSPORTATION TROLLEY STANDARDS	date: MARCH 00
DR: AJW RECOM.	SCALE: NONE CONTRACT:		WOOD POLE	DWG. NO.
APPROVED		King County	HOLDDOWN BRACKET ASSEMBLY TANGENT CONSTRUCTION	SA-358 SHT 1 OF 2


		MATERIAL LIST		
ITEM #	QTY	DESCRIPTION	MANUFACTURER	CAT. NO.
01	2	DETROIT CLAMP ASSY	WABCO	19293-3007
03	4	GUY STRAIN INSUL	PORCELAIN	504
			PRODUCTS CO.	
04	10	GUY GRIP DEADEND	PREFORMED	CDE-3106
05	4	WIRE ROPE CLIP, 5/16"	CROSBY	G450
06	AS REQD	FRICTION TAPE, 3/4" (6 WRAPS)		
07	4	THIMBLE, 3/8" XHD, OPEN	CROSBY	G414
08	VARIES	GUY STRAND	COPPERWELD	8M
10	1	HI-LITE DOUBLE CURVE HANGER	WABCD	54962-3001
1 1	1	7/8 TRANSLITE STRAIN INSUL CL-CL	WABCD	54975-6120
15	3	WIRE ROPE CLIP, 3/8"	CROSBY	G450
17	2	THIMBLE, 1/2" XHD, OPEN	CROSBY	G414
28	2	INSULATOR SPOOL	WABCD	16835-2000
39	1	5/8" SHACKLE	WABCD	13722-2000
55	VARIES	PHILLYSTRAN (3/8")	PHILLYSTRAN	HPTG 6700I
			INC.	
56	1	PHILLYSTRAN BIG GRIP	PHILLYSTRAN	PLP 2755
			INC.	
57	VARIES	FIBERGLASS REINFORCED PLASTIC	STRONGWELL	EXTREN
		(FRP) TUBE 5" Ø X 1/4"		SERIES 525
90	1	HEAVY PIPE CLAMP, GALV	GRINNELL	FIG. 216
94	3	5/8" DVAL EYEBOLT WITH NUT	JOSLYN	J94XX
96	3	SQ CURVED WASHER 3"×3"×1/4"	JOSLYN	J113
		11/16" DIA		
97	1	3/4" MACHINE BOLT	JOSLYN	J89XX
99	1	WOOD POLE MOUNTING BRACKET	METRO STD	SA-111
102	3	FORGED THREE-PIECE ADJUSTABLE	KORTICK	
		POLE BAND, ANNEALED & GALVANIZED	MFG CO	
108	1	MAST ARM POLE END CAP	METRO STD	SA-108
110	1	MAST ARM UNDERSLING END CAP	METRO STD	SA-110

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WOOD POLE HOLDDOWN BRACKET ASSEMBLY TANGENT CONSTRUCTION

	DATE:
	MARCH 00
	FILE
	DWG. NO.
,	SA - 358
	SHT 2 OF 2



- STAINLESS STEEL BANDING SHALL BE WRAPPED DOUBLE THICKNESS AROUND POLE COVERING MATERIAL PRIOR TO CLAMPING.
- MATERIAL FOR THREADED RODS AND NUTS SHALL BE ASTM CLASS A-307 STEEL. 2.

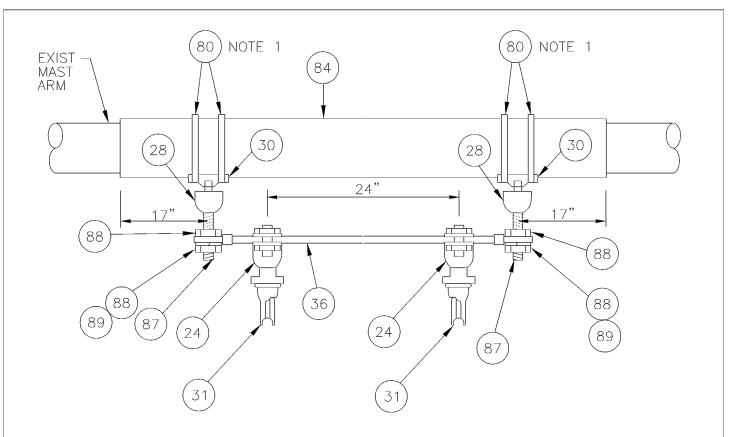MATERIAL LIST


3. HOT DIP GALVANIZE ALL METAL AFTER FABRICATION.

King County


	MATERIAL LIST								
	ITEM #	QT	Y		DESCRIPTION			MANUFACTURER	CAT. NO.
	24	2		TROLL	EY WIRE SU	JPPORT AS	SSY	WABCO	54962-3003
	28	2		INSUL	ATOR SPOOL	_		WABCO	16835-2000
	30	2		TROLL	EY SUPPORT	T-LARGE F	PIPE ARMS	WABCO	54940-4001
Σ	31	2		SPRIN	G DETROIT	CLAMP		WABCO	54959-3001
7 12:32:25 P	36	1			/8 TRANSLITE STRAIN INSUL / ADJUST END FITTINGS			WABCO	54980-6385
/5/200	80	AS R	EQD	3/4"	STAINLESS	STEEL	BANDING	BAND-IT	TYPE 201
-361, 1	84	6 L	.F	SCHED	40 PVC, 0	GREY, SPL	_ I T		
Wg, SA	87	2		5/8″ -	11 UNC X 6	5" THREAD	DED ROD,		
\-361.d				GALV,	ASTM A36				
tails\S/	88	4		5/8″ -	11 UNC HVY	MEX JAM	M NUT,		
ley\De				· ·	GALV, ASTM A563 GRA				
Ţ	89	2		11/16	11/16" LOCKWASHER				
& Standards\Standards\Trolley\Details\SA-361.dwg, SA-361, 1/5/2007 12:32:25 PM	DPG DOW		V		DEPAR	TMENT OF T trolley sta	RANSPORTATIOI Andards	DATE: JUN 95 FILE	
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OUTBOARD MOUNTING



MOUNTING PLATE

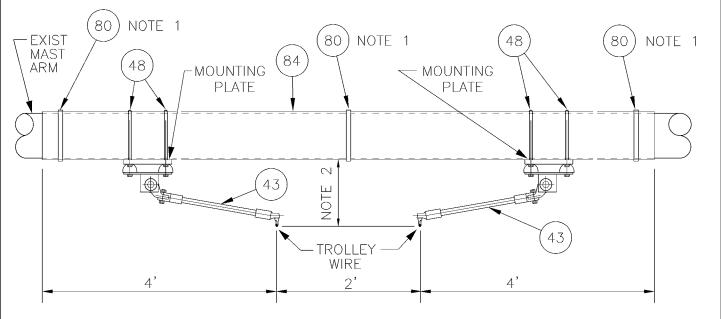(2 REQ'D)

NOTES:

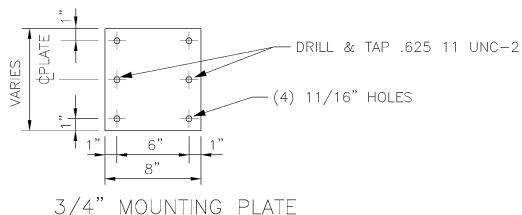- 1. STAINLESS STEEL BANDING SHALL BE WRAPPED DOUBLE THICKNESS AROUND POLE COVERING MATERIAL PRIOR TO CLAMPING. PLACE SPLIT DOWN ON ITEM 84.
- 2. DISTANCE VARIES. ITEMS 43 & 48 NOT REQ'D WHEN GREATER THAN 18". USE OFFSET MOUNTING (SHEET 2) WHEN SPACE LIMITS USE OF OUTBOARD MOUNTING.

1/5/200		MATERIAL LIST		
2.dwg, F 362.1,	QTY	DESCRIPTION	MANUFACTURER	CAT. NO.
₹ 3	2	TROLLEY WIRE SUPPORT ASSY	WABCO	59690-3001
\$ 8	4	5/8" U-BOLT GALV		
AgetalishsA-3	AS REQD	3/4" X 0.030" SS BANDING TYPE 201	BAND-IT	C206
2 4	10 LF	SCHED 40 PVC, GREY, SPLIT		
5				DATE

B4 10 LF SCHED 4
DESIGNED CHKD:
DPG
DE SCALE:
NONE
RECOM. CONTRACT:
APPROVED




DEPARTMENT OF TRANSPORTATION TROLLEY STANDARDS

TRAFFIC MAST ARM TROLLEY SUPPORT

DATE:
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FILE
DWG. NO.

SA-362 SHT 1 OF 2

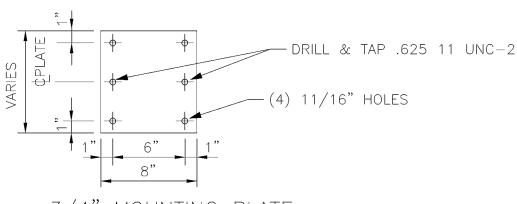

MOUNTING PLATE
(2 REQ'D)

NOTES:


- 1. STAINLESS STEEL BANDING SHALL BE WRAPPED DOUBLE THICKNESS AROUND POLE COVERING MATERIAL PRIOR TO CLAMPING. PLACE SPLIT DOWN ON ITEM 84.
- 2. DISTANCE VARIES. ITEMS 43 & 48 NOT REQ'D WHEN GREATER THAN 18". USE OUTBOARD MOUNTING (SEE PAGE 1) WHEN LESS THAN 9", OR ROTATE ONE ITEM 43 15" OUT OF THE PAPER & ONE ITEM 43 15" INTO THE PAPER.

		MATERIAL LIST		
ITEM #	QTY	DESCRIPTION	MANUFACTURER	CAT. NO.
43 2 TROLLEY WIRE SUPPORT ASSY			WABCO	59690-3001
48	4	5/8" U-BOLT GALV		
80	AS REQD	3/4" X 0.030" SS BANDING TYPE 201	BAND-IT	C206
84	10 LF	SCHED 40 PVC, GREY, SPLIT		
DECIONED	OLIKO		DALLODODTATION	I DATE:



DEPARTMENT OF TRANSPORTATION TROLLEY STANDARDS

TRAFFIC MAST ARM TROLLEY SUPPORT

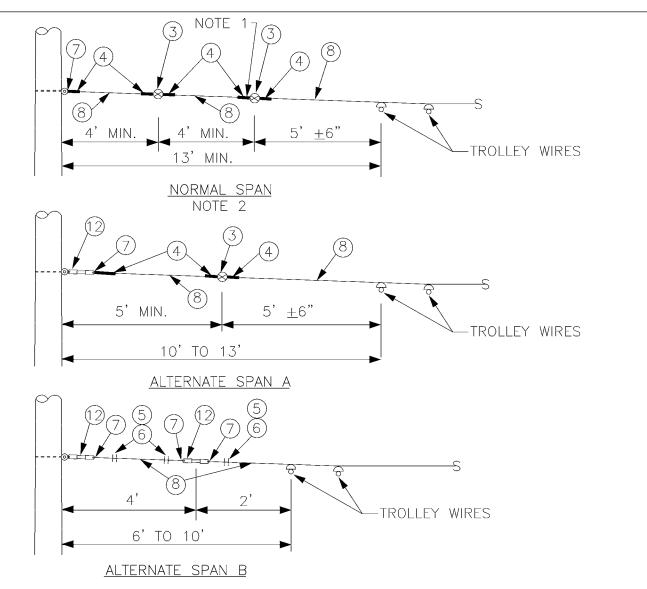

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TMB

RECOM.

APPROVED

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CONTRACT:

NONE

King County

SCALE:

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- WHERE ADJUSTABILITY IS REQUIRED, REPLACE GUY GRIP DEADEND (ITEM 4) WITH WIRE ROPE CLIPS (ITEM 5 & 6). SEE SA-166.
- INCLUDES SA-301, SA-302, SA-305, SA-311, SA-312 & SA-315. 2.

				MATE	RIAL LIST			
ITEM #	QT	Ý		DESCRIPTION			JFACTURER	CAT. NO.
03	VARIE	ARIES GUY STRAIN INSUL				PORC PROD	ELAIN UCTS CO.	504
04	VARIES GUY C		GUY ÇR	IP DEADEND		PREFO	ORMED	CDE-3106
05	5 VARIES WIRE ROP		DPE CLIP, 5/	/16"	CROS	SBY	G450	
06	06 AS REQD FRICTION		FRICTION	TAPE, 3/4	" (6 WRAPS)			
07	07 VARIES		THIMBLE	, 3/8" XHD,	OPEN	CROS	BY	G414
08	08 VARIES GUY		GUY STE	RAND		COPP	PERWELD	8M
12	VARIE	S	7/8 TRANSLITE STRAIN INSUL CL-EYE			WAB	CO	55339-6120
DESIGNED CHKD:			,		DEPARTMENT OF	TRANS	PORTATION	DATE:

TROLLEY STANDARDS

SPAN WIRES

LIMITED SPACE

TYPICAL VARIANCES

OCT 95


SA - 370

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OF

FILE

DWG. NO.

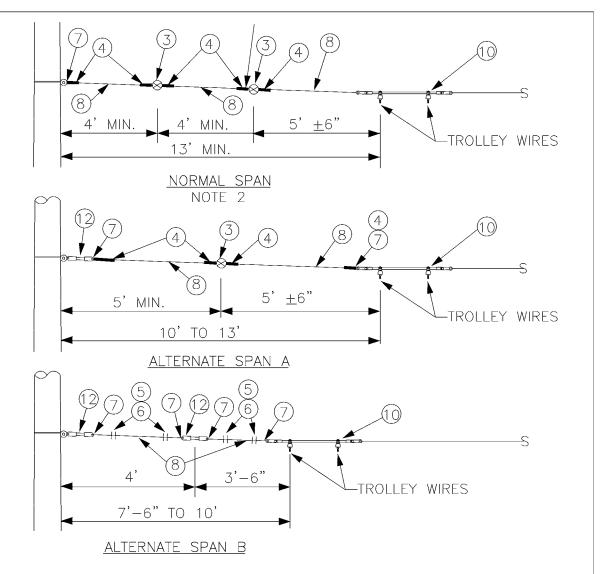

- WHERE ADJUSTABILITY IS REQUIRED, REPLACE GUY GRIP DEADEND (ITEM 4) WITH WIRE ROPE CLIPS (ITEM 5 & 6). SEE SA-166.
- 2. INCLUDES SA-303, SA-304, SA-307, SA-308, SA-313 & SA-314, SA-317 & SA-318.

		MATERIAL LIST		
ITEM #	QTY	DESCRIPTION	MANUFACTURER	CAT. NO.
03	VARIES	GUY STRAIN INSUL	PORCELAIN	504
			PRODUCTS CO.	
04	VARIES	GUY GRIP DEADEND	PREFORMED	CDE-3106
05	VARIES	WIRE ROPE CLIP, 5/16"	CROSBY	G450
06	AS REQD	FRICTION TAPE, 3/4" (6 WRAPS)		
07	VARIES	THIMBLE, 3/8" XHD, OPEN	CROSBY	G414
08	VARIES	GUY STRAND	COPPERWELD	8M
10	VARIES	HI-LITE DOUBLE CURVE HANGER	WABCO	54962-3001
12	VARIES	7/8 TRANSLITE STRAIN INSUL CL-EYE	55339-6120	
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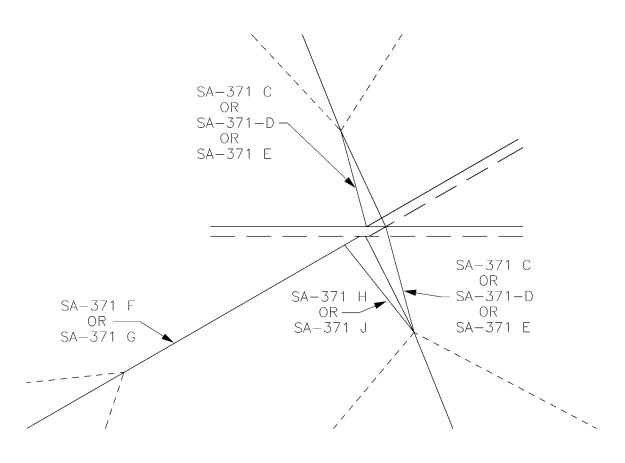
King County

DEPARTMENT OF TRANSPORTATION TROLLEY STANDARDS

> SPAN WIRES LIMITED SPACE TYPICAL VARIANCES

OCT 95 FILE DWG. NO. OF 2 2

CURVE SEGMENT PULLOFFS



SWITCH PULLOFFS

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DEPARTMENT OF TRANSPORTATION TROLLEY STANDARDS

SWITCH & CURVE SEGMENT PULLOFFS

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SHT 1 OF 9

- 1. A POLE COLLAR OR POLE EYEBOLT IS REQUIRED PER SA-102 OR SA-103 UNLESS A BUILDING EYEBOLT ATTACHMENT IS USED. INSTALLATION HEIGHT IS INDICATED ON THE OVERHEAD DRAWINGS.
- 2. PROVIDE TENSION ADJUSTMENT POINTS AT LOCATIONS INDICATED BY "\".
 PROVIDE WIRE ROPE CLIPS AT THESE LOCATIONS. SEE SA-166.
- 3. LOCATION OF ADJUSTMENT POINT, INSULATORS AND USE OF INSULATED GUY STRAND GUY STRAND SHALL MEET SA-167 REQUIREMENTS.
- 4. OUTSIDE PULLOFFS ARE SHOWN FOR CURVE SEGMENTS, INSIDE PULLOFFS ARE SIMILAR. INSIDE PULLOFFS ARE SHOWN FOR SWITCHES, OUTSIDE PULLOFFS ARE SIMILAR.
- 5. TROLLEY WIRE TO STRUCTURAL ATTACHMENT DISTANCE DETERMINES IF A SHORT, MEDIUM OR LONG VERSION IS USED FOR SA-371 A THROUGH SA-371 E.
- 6. TROLLEY WIRE GEOMETRY AS SHOWN ON THE OVERHEAD DRAWINGS DETERMINES WHICH SA-371 A THROUGH SA-371 K TO USE.

MATERIAL LIST					
ITEM #	QTY	DESCRIPTION	MANUFACTURER	CAT. NO.	
06	AS REQD	FRICTION TAPE, 3/4" (6 WRAPS)			
09	*	BULL RING	WABCO	18567-2000	
1 1	*	7/8 TRANSLITE STRAIN INSUL CL-CL	WABCO	54975-6120	
12	*	7/8 TRANSLITE STRAIN INSUL CL-EYE	WABCO	55339-6120	
102	VARIES	FORGED THREE-PIECE ADJUSTABLE	KORTICK		
		POLE BAND, ANNEALED & GALVANIZED	MFG CO		
103	VARIES	WOOD POLE EYEBOLT	METRO STD	SA-103	
GUY TENSIONS- 0-2700 LBS					
03	*	GUY STRAIN INSUL	PORCELAIN	504	
			PRODUCTS CO.		
04	*	GUY GRIP DEADEND	PREFORMED	CDE-3106	
05	*	WIRE ROPE CLIP, 5/16"	CROSBY	G450	
07	*	THIMBLE, 3/8" XHD, OPEN	CROSBY	G414	
08	VARIES	GUY STRAND	COPPERWELD	8M	
08 VARIES GUY STRAND CUPPERWELD 8M GUY TENSIONS - 2700 - 5000 LBS 13 * GUY STRAIN INSUL PURCELAIN 506					
13	*	GUY STRAIN INSUL	PORCELAIN	506	
			PRODUCTS CO.		
14	*	GUY GRIP DEADEND	PREFORMED	CDE-3115	
15	*	WIRE ROPE CLIP, 3/8"	CROSBY	G450	
16	VARIES	GUY STRAND	COPPERWELD	16M	
17	*	THIMBLE, 1/2" XHD, OPEN	CROSBY	G414	
14 15 16 17 43 48	*	7/8 TRANSLITE STRAIN INSUL CL-CL	WABCD	56273-6120	
48	*	Y CLEVIS EYE CONNECTION	LINE HARDWARE	YCE-30	
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TMB NONE

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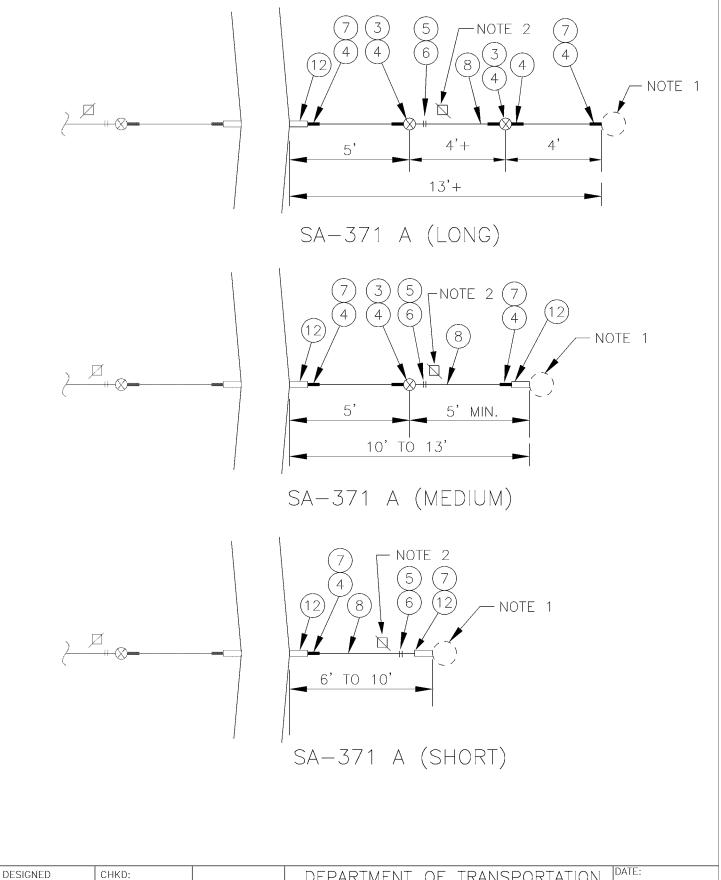
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King County

DEPARTMENT OF TRANSPORTATION TROLLEY STANDARDS

SWITCH & CURVE SEGMENT PULLOFFS DATE:
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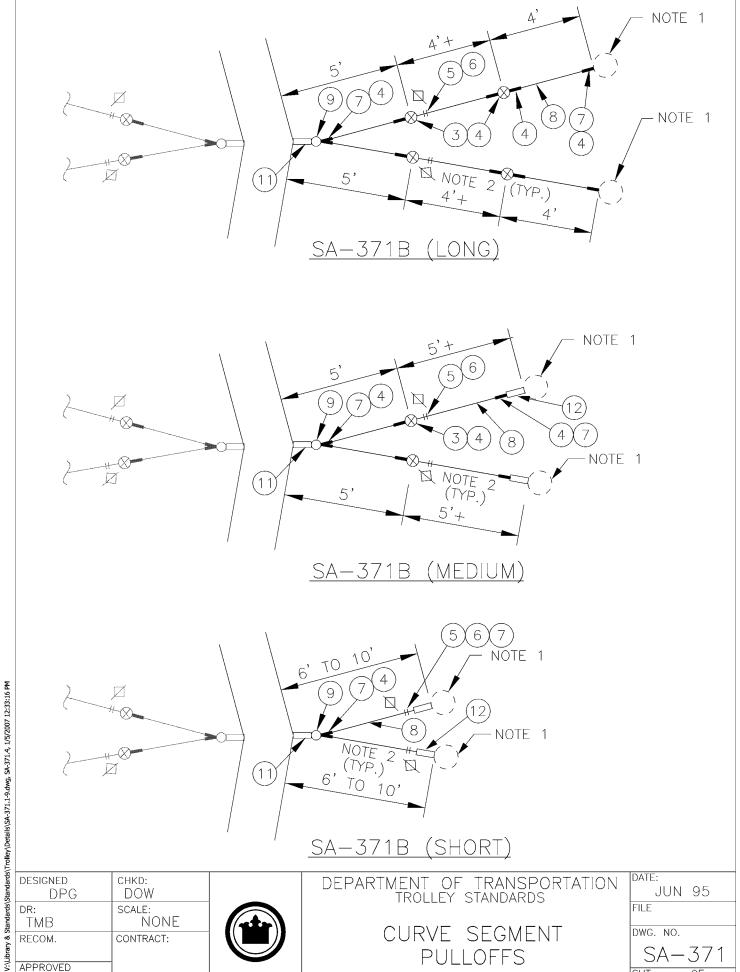
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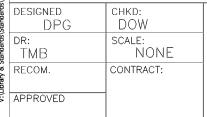
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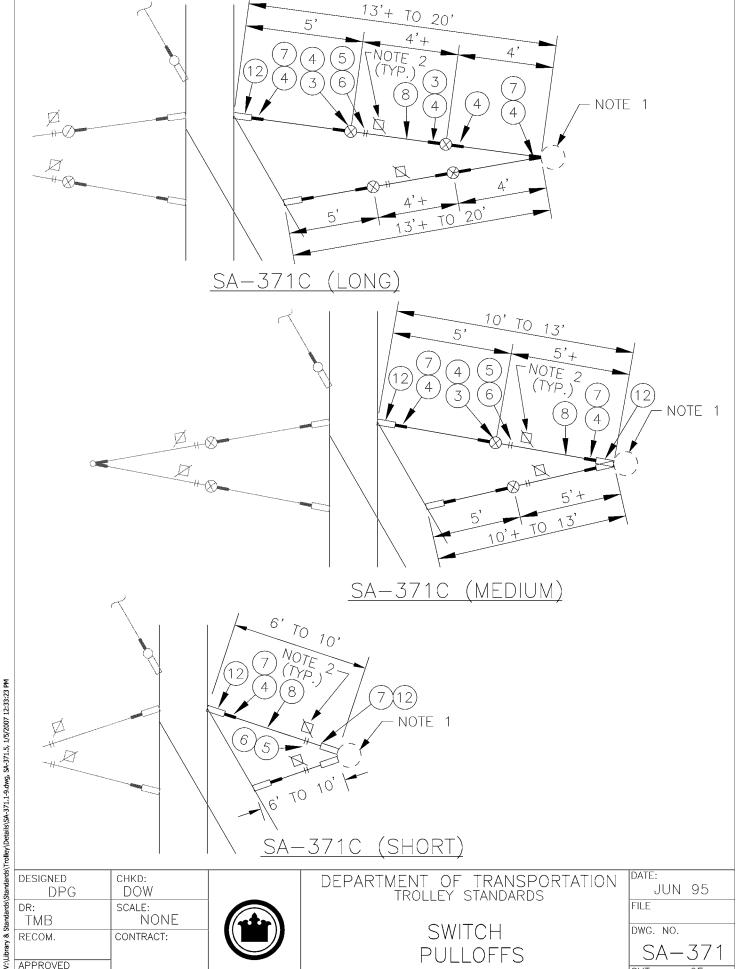






CURVE SEGMENT **PULLOFFS**

DATE:	
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SHT 4 OF 9	



SWITCH

PULLOFFS

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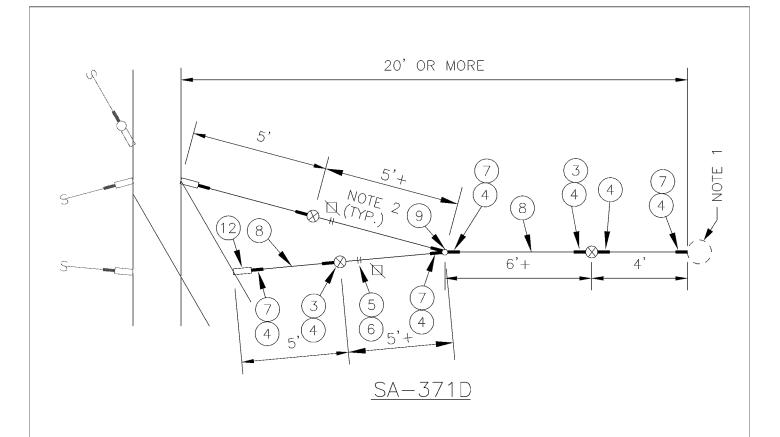
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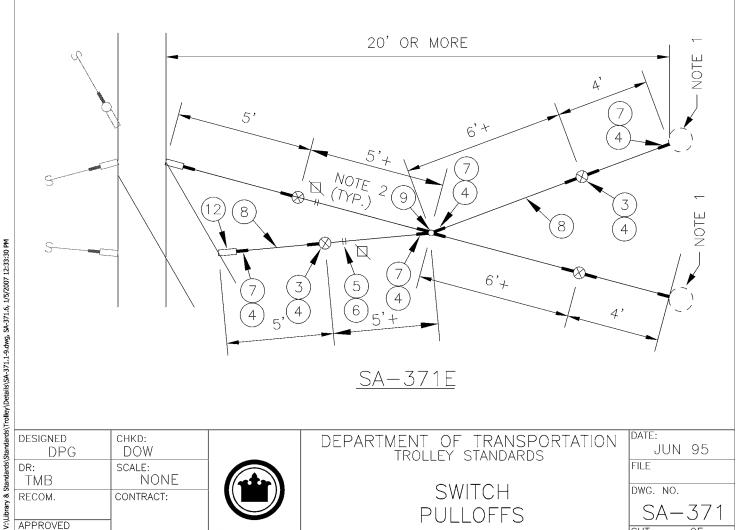
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NONE

King County

CONTRACT:






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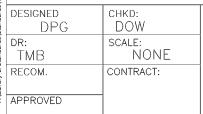


DEPARTMENT OF TRANSPORTATION TROLLEY STANDARDS

SWITCH PULLOFFS

DATE:
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SA - 371
SHT 6 OF 9



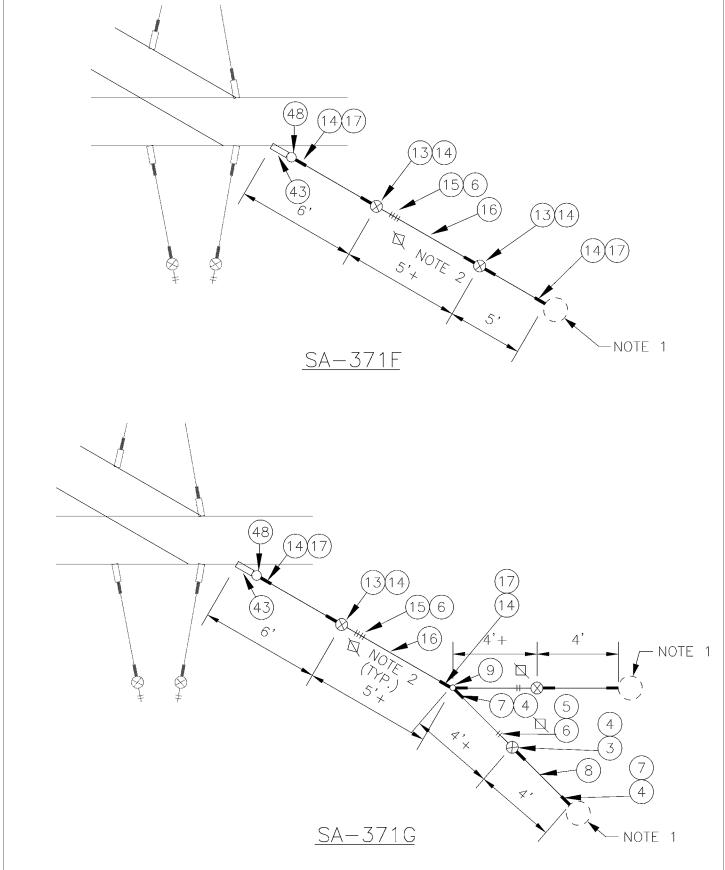



SWITCH PULLOFFS

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SWITCH PULLOFFS

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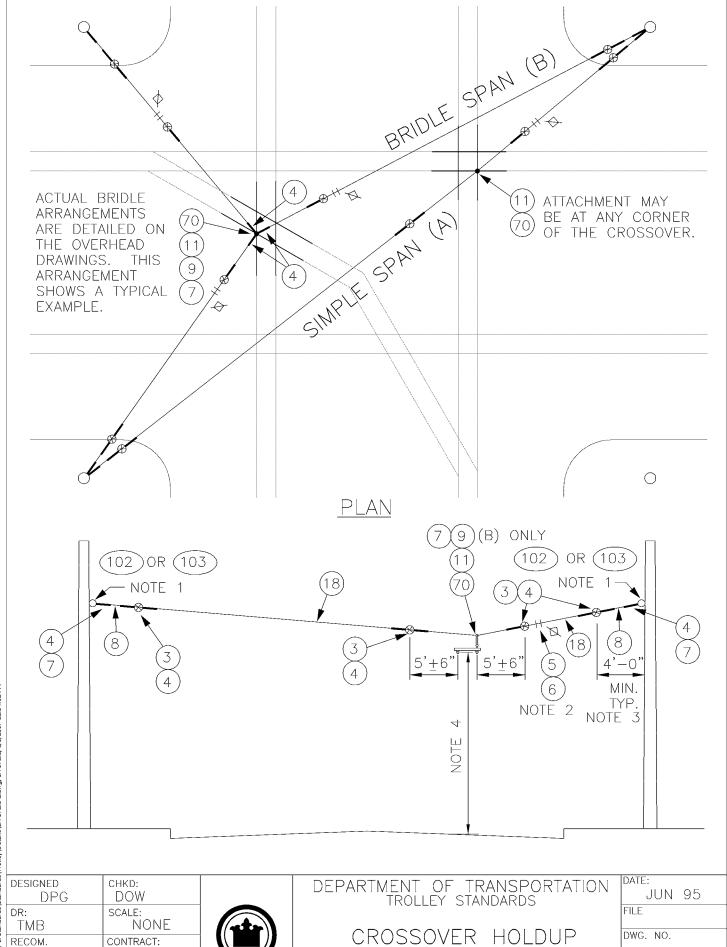
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DEPARTMENT OF TRANSPORTATION TROLLEY STANDARDS

SWITCH PULLOFFS

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King County

- 1. A POLE COLLAR OR POLE EYEBOLT IS REQUIRED PER SA-102 OR SA-103 UNLESS A BUILDING EYEBOLT ATTACHMENT IS USED. INSTALLATION HEIGHT IS INDICATED ON THE OVERHEAD DRAWINGS.
- 2. PROVIDE TENSION ADJUSTMENT POINTS AT LOCATIONS INDICATED BY "\(\nabla\)". PROVIDE WIRE ROPE CLIPS AT THESE LOCATIONS. SEE SA-166.
- 3. SEE SA-370 FOR LIMITED SPACE VARIANCES. SEE SA-167 FOR INSULATED GUY CRITERIA.
- 4. SEE SA-164 FOR VERTICAL & HORIZONTAL DIMENSIONS TO TROLLEY WIRE.


4. SEE SA-164 FOR VERTICAL & MORIZONTAL DIMENSIONS TO TROLLET WIRE.				
MATERIAL LIST (A)				
ITEM #	QTY	DESCRIPTION	MANUFACTURER	CAT. NO.
03	4	GUY STRAIN INSUL	PORCELAIN PRODUCTS CO.	504
04	9	GUY GRIP DEADEND	PREFORMED	CDE-3106
05	2	WIRE ROPE CLIP, 5/16"	CROSBY	G450
06	AS REQD	FRICTION TAPE, 3/4" (6 WRAPS)		
07	2	THIMBLE, 3/8" XHD, OPEN	CROSBY	G414
08	VARIES	GUY STRAND	COPPERWELD	8M
1 1	1	7/8 TRANSLITE STRAIN INSUL CL-CL	WABCD	54975-6120
18	VARIES	GUY STRAND, COVERED	COPPERWELD	8MI
70	1	EYEBOLT, 5/8" X 6" W/2 NUTS & LOCKWASHER		
102	VARIES	FORGED THREE-PIECE ADJUSTABLE	KORTICK	
		POLE BAND, ANNEALED & GALVANIZED	MFG CD	
103	VARIES	WOOD POLE EYEBOLT	METRO STD	SA-103
		MATERIAL LIST (B)		
ITEM #	QTY	DESCRIPTION	MANUFACTURER	CAT. NO.
03	6	GUY STRAIN INSUL	PORCELAIN PRODUCTS CO.	504
04	15	GUY GRIP DEADEND	PREFORMED	CDE-3106
05	6	WIRE ROPE CLIP, 5/16"	CROSBY	G450
06	AS REQD	FRICTION TAPE, 3/4" (6 WRAPS)		
07		, , , , , , , , , , , , , , , , , , , ,		
/	6	THIMBLE, 3/8" XHD, DPEN	CROSBY	G414
08	6 VARIES		CROSBY COPPERWELD	G414 8M
		THIMBLE, 3/8" XHD, OPEN		
08	VARIES	THIMBLE, 3/8" XHD, OPEN GUY STRAND	COPPERWELD	8M
08	VARIES 1	THIMBLE, 3/8" XHD, OPEN GUY STRAND BULL RING	COPPERWELD WABCO	8M 18567-2000
08 09 11	VARIES 1 1	THIMBLE, 3/8" XHD, OPEN GUY STRAND BULL RING 7/8 TRANSLITE STRAIN INSUL CL-CL	COPPERWELD WABCO WABCO	8M 18567-2000 54975-6120
08 09 11 18	VARIES 1 1 VARIES	THIMBLE, 3/8" XHD, OPEN GUY STRAND BULL RING 7/8 TRANSLITE STRAIN INSUL CL-CL GUY STRAND, COVERED	COPPERWELD WABCO WABCO	8M 18567-2000 54975-6120
08 09 11 18	VARIES 1 1 VARIES	THIMBLE, 3/8" XHD, OPEN GUY STRAND BULL RING 7/8 TRANSLITE STRAIN INSUL CL-CL GUY STRAND, COVERED EYEBOLT, 5/8" X 6"	COPPERWELD WABCO WABCO	8M 18567-2000 54975-6120
08 09 11 18 70	VARIES 1 1 VARIES 1	THIMBLE, 3/8" XHD, OPEN GUY STRAND BULL RING 7/8 TRANSLITE STRAIN INSUL CL-CL GUY STRAND, COVERED EYEBOLT, 5/8" X 6" W/2 NUTS & LOCKWASHER	COPPERWELD WABCO WABCO COPPERWELD	8M 18567-2000 54975-6120
08 09 11 18 70	VARIES 1 1 VARIES 1	THIMBLE, 3/8" XHD, OPEN GUY STRAND BULL RING 7/8 TRANSLITE STRAIN INSUL CL-CL GUY STRAND, COVERED EYEBOLT, 5/8" X 6" W/2 NUTS & LOCKWASHER FORGED THREE-PIECE ADJUSTABLE	COPPERWELD WABCO WABCO COPPERWELD KORTICK	8M 18567-2000 54975-6120 8MI
08 09 11 18 70	VARIES 1 1 VARIES 1 VARIES VARIES CHKD: DOV	THIMBLE, 3/8" XHD, OPEN GUY STRAND BULL RING 7/8 TRANSLITE STRAIN INSUL CL-CL GUY STRAND, COVERED EYEBOLT, 5/8" X 6" W/2 NUTS & LOCKWASHER FORGED THREE-PIECE ADJUSTABLE POLE BAND, ANNEALED & GALVANIZED WOOD POLE EYEBOLT OF TROLLEY STA	COPPERWELD WABCO WABCO COPPERWELD KORTICK MFG CO METRO STD RANSPORTATION ANDARDS	8M 18567-2000 54975-6120 8MI SA-103 SA-103 OCT 95 FILE

CROSSOVER HOLDUP SPAN

NOTES & MATERIAL

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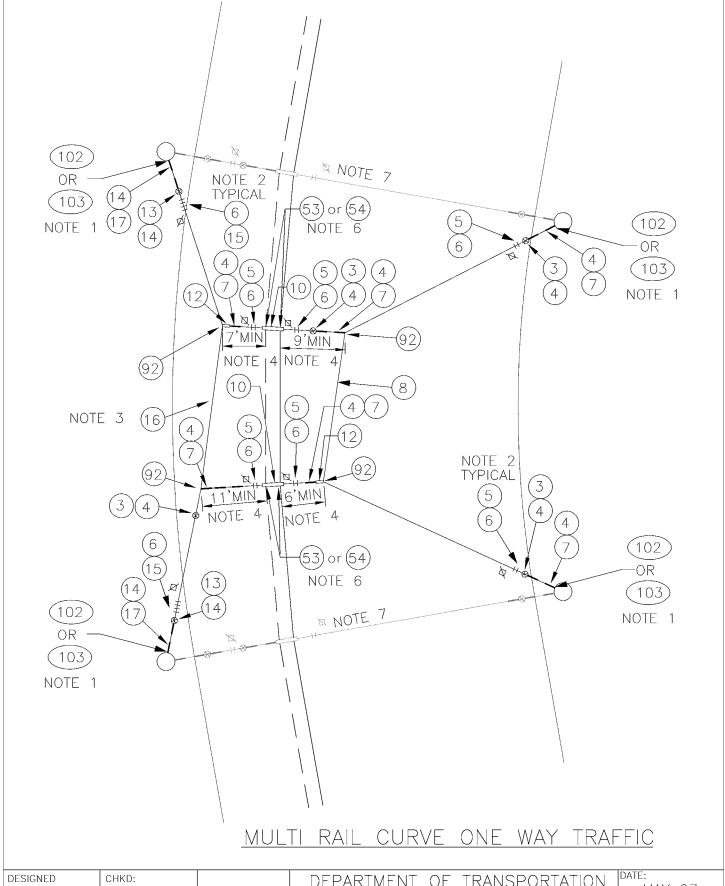
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DEPARTMENT OF TRANSPORTATION TROLLEY STANDARDS

CONVENTIONAL CURVE WITH CURVE RAILS
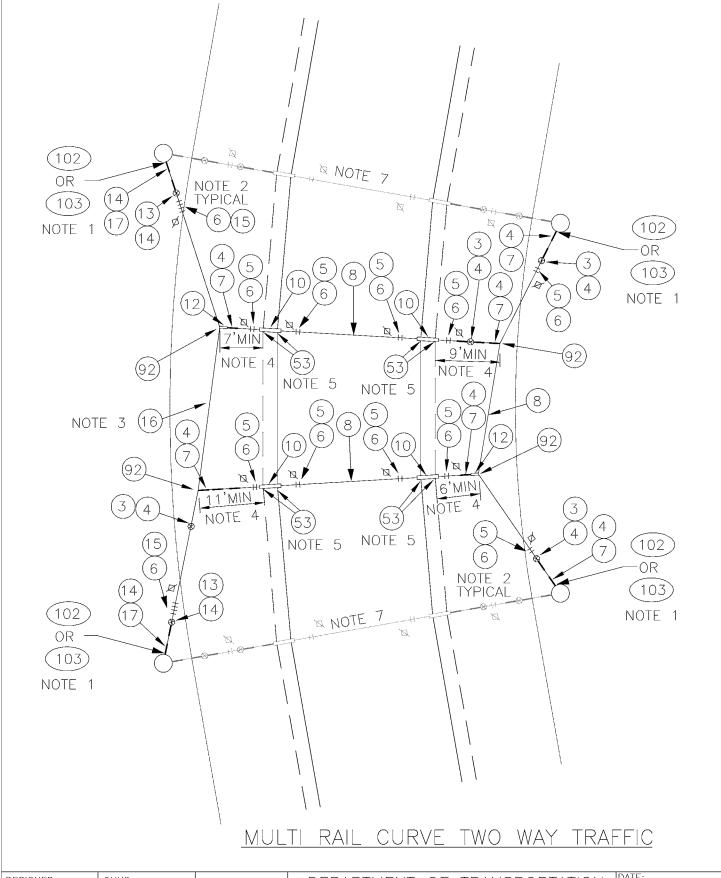
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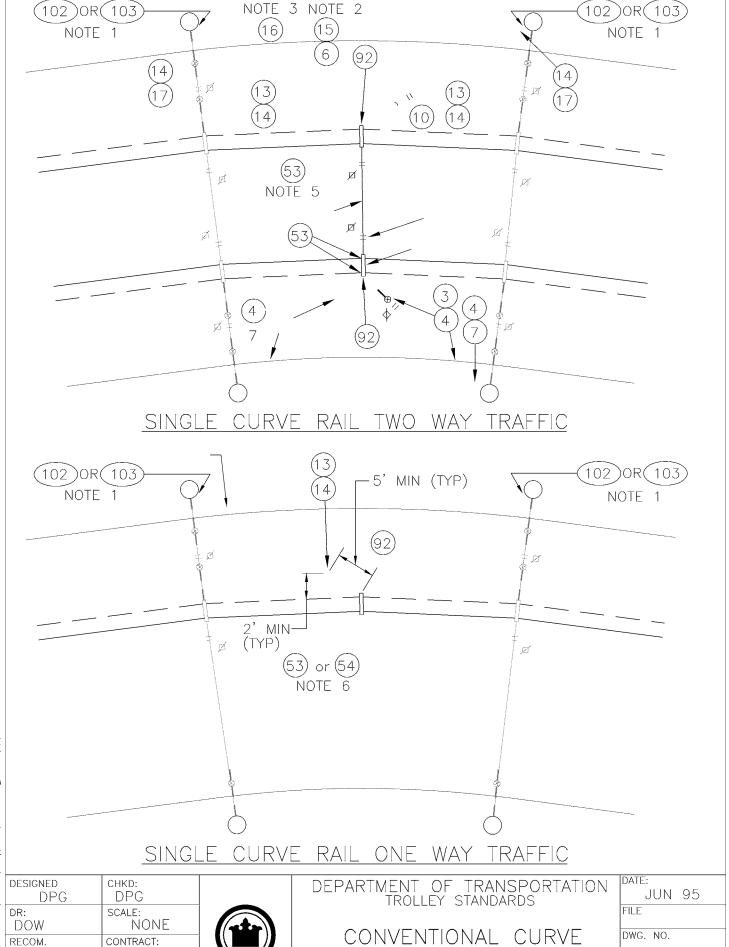
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DEPARTMENT OF TRANSPORTATION TROLLEY STANDARDS

CONVENTIONAL CURVE WITH CURVE RAILS

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WITH CURVE RAILS

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King County

	MATERIAL LIST				
ITEM	#	QTY	DESCRIPTION	MANUFACTURER	CAT. NO.
03		VARIES	GUY STRAIN INSUL	PORCELAIN	504
				PRODUCTS CO.	
04	_	VARIES	GUY GRIP DEADEND	PREFORMED	CDE-3106
05		VARIES	WIRE ROPE CLIP, 5/16"	CROSBY	G450
06		AS REQD	FRICTION TAPE, 3/4" (6 WRAPS)		
07		VARIES	THIMBLE, 3/8" XHD, OPEN	CROSBY	G414
08		VARIES	GUY STRAND	COPPERWELD	8M
10		VARIES	HI-LITE DOUBLE CURVE HANGER	WABCO	54962-3001
12		VARIES	7/8 TRANSLITE STRAIN INSUL CL-EYE	WABCO	55339-6120
13		VARIES	GUY STRAIN INSUL	PORCELAIN	506
				PRODUCTS CO.	
14		VARIES	GUY GRIP DEADEND	PREFORMED	CDE-3115
15		VARIES	WIRE ROPE CLIP, 3/8"	CROSBY	G450
16		VARIES	GUY STRAND	COPPERWELD	16M
17		VARIES	THIMBLE, 1/2" XHD, OPEN	CROSBY	G414
53		VARIES	CURVE RAIL (1° TO 5° 2 FT LG)	K & M	851 B412/0
54		VARIES	CURVE RAIL (>5° TO 7,5° 4 FT LG)	K & M	851 B412/1
92		VARIES	ANGLE CLAMP, DUCTILE IRON	ANDERSON/	82860-2000
				SQUARE D	
102		VARIES	FORGED THREE-PIECE ADJUSTABLE	KORTICK	
			POLE BAND, ANNEALED & GALVANIZED	MFG CO	
103		VARIES	WOOD POLE EYEBOLT	METRO STD	SA-103

NOTES

- A POLE COLLAR OR POLE EYEBOLT IS REQUIRED PER SA-102 OR SA-103 UNLESS A 1. BUILDING EYEBOLT ATTACHMENT IS USED. INSTALLATION HEIGHT IS INDICATED ON THE OVERHEAD DRAWINGS.
- PROVIDE TENSION ADJUSTMENT POINTS AT LOCATIONS INDICATED BY "". 2. PROVIDE WIRE ROPE CLIPS AT THESE LOCATIONS. SEE SA-166.
- 3. IF LOAD SHOWN ON OVERHEAD DRAWINGS IS LESS THAN 2500 LBS. THEN ITEM 8 MAY BE USED INSTEAD OF ITEM 16. THE ASSOCIATED ITEMS SHALL ALSO BE CHANGED I.E. 3 FOR 13, 4 FOR 14, 5 FOR 15 AND 7 FOR 17.
- ey\Detaij\$\SA-373.1-4.dwg, S&3373.4(_JJ5/2007_12:34:4319M THE DISTANCE FROM THE TROLLEY WIRE TO THE SUPPORT CATENARY WIRE SHALL BE AS SHOWN ON THE OVERHEAD DRAWINGS. THE DISTANCES ON SA-373 ARE SHOWN TO DEFINE PARTS REQUIRED FOR DISTANCE RANGES ONLY.
- ANGLE VARIES FROM 1° TO 5°.

USE ITEM 53 WHEN ANGLE VARIES FROM 1° TO 5°. USE ITEM 54 WHEN ANGLE VARIES FROM 5° TO 7.5°. TROLLEY WIRE SHALL NOT BE TIED TOGETHER AS SHOWN ON SHEET 1 WHEN USING ITEM 54. USE SHEET 2, IF TWO WAY TROLLEY WIRE USES ITEM 54, AND TREAT EACH TRACK SEPARATELY.

END SPAN SHOWN FOR REFERENCE ONLY, ACTUAL SPAN USED SHALL BE DEFINED ON THE OVERHEAD DRAWINGS.


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DEPARTMENT OF TRANSPORTATION TROLLEY STANDARDS

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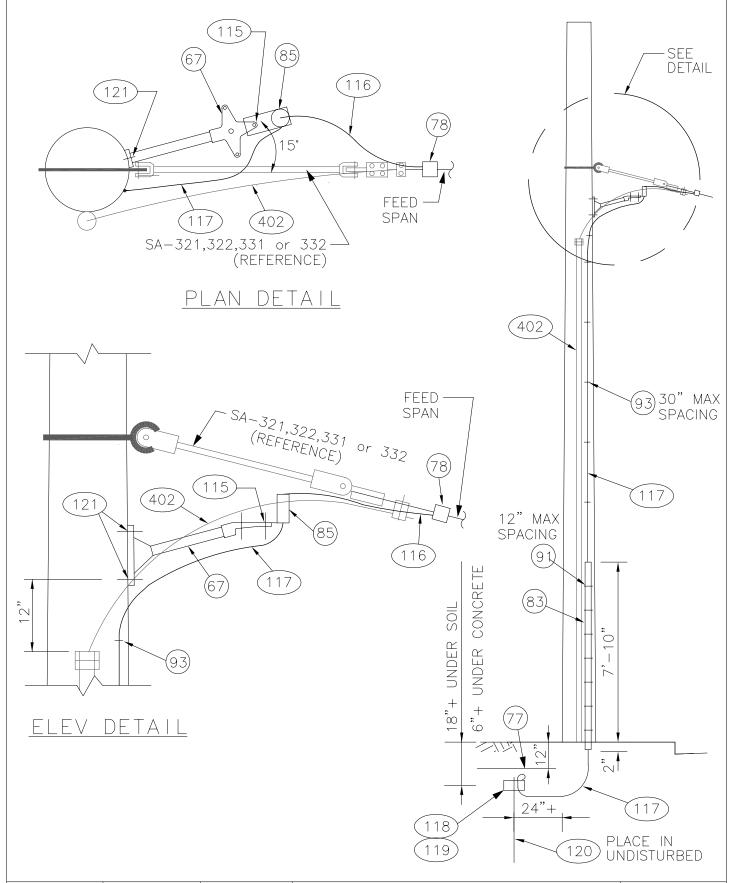






LIGHTNING ARRESTERS
DOUBLE FEEDER RISER
(WOOD POLE)

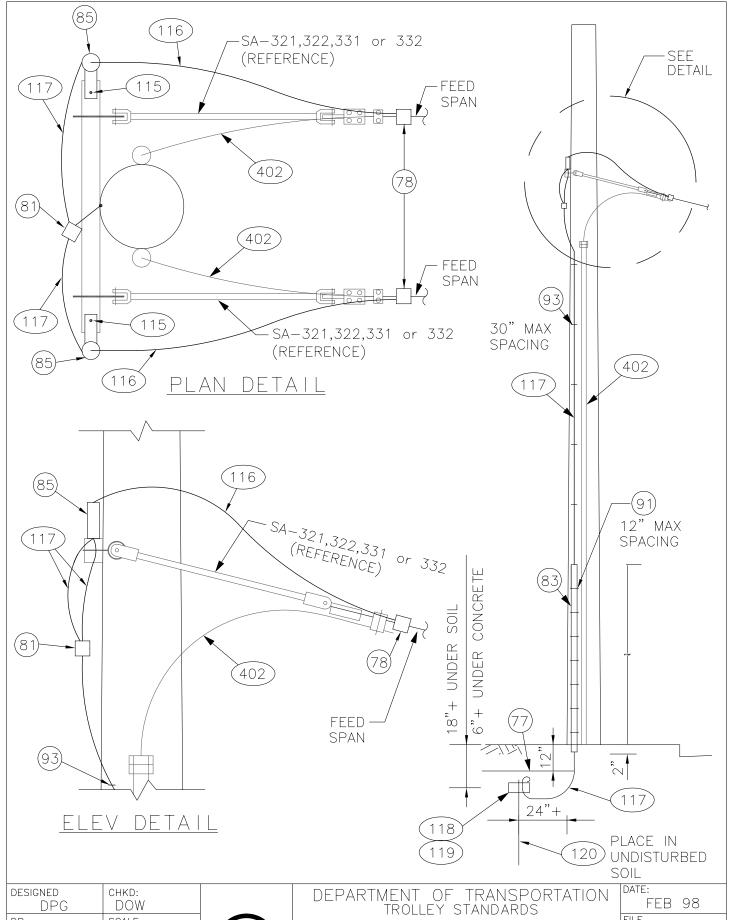DATE:
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DWG. NO.
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SHT 1 OF 6




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LIGHTNING ARRESTER SINGLE FEEDER RISER (WOOD POLE)

DATE:
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SA-401
SHT 2 OF 6




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LIGHTNING ARRESTERS DOUBLE FEEDER RISER (STEEL POLE)

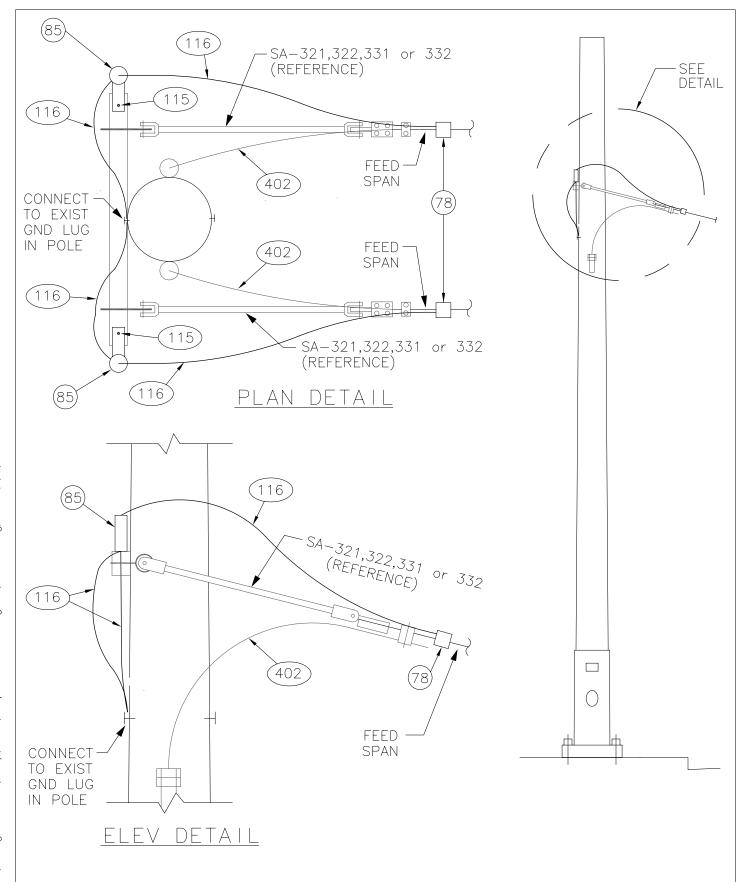DATE:
JUN 95
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SHT 3 OF 6



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LIGHTNING ARRESTERS
SINGLE FEEDER RISER
(STEEL POLE)

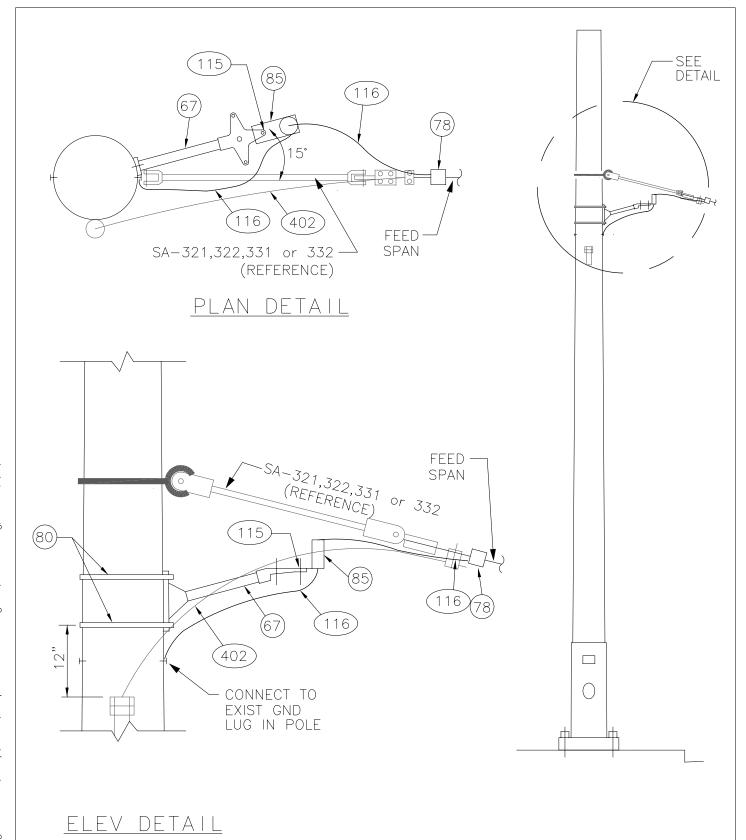DATE:
JUN 95
FILE
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DWG. NO.
SA-401
SHT 4 OF 6

	WOOD POLE SINGLE FEEDER MATERIAL LIST (SEE PAGE 2)					
ITEM # QTY DESCRIPTION		MANUFACTURER	CAT. NO.			
67	1	CLOVERLEAF EPOXIROD STANDOFF	CHANCE	C653-1038		
77	AS REQD	ELEC WARNING TAPE, 6" YELLOW	BRADY	UT 20-Y6		
78	1	CONNECTOR, PARALLEL CLAMP	BURNDY	QPX342C		
83	1	MOLDING, PLASTIC, GROUND WIRE, 1/2" X 1/16" X 8'	JOSLYN	PM128		
85	1	1000 VOLT DC ARRESTOR 970 MCOV	IMPULSE	P/N 1057		
91	AS REQD	STAPLES, ROLLED POINT, GALV, 2" X 1/2" X O.162"	JOSLYN	J156		
93	AS REQD	STAPLES, ROLLED POINT, GALV, 1 3/4" X 1/4" X 0.148"	JOSLYN	J1673		
115 1 STAINLESS STEEL BOLT WITH WASHERS & LOCK WASHERS						
116 * WIRE, 2 DR 5 KV, #4 AWG CU, JACKETED, UNSHIELDED						
117						
118	1	GROUND ROD CLAMP	COPPERWELD	АВН58		
119	AS REQD	CONDUCTIVE & ANTI-SEIZE COMPOUND	THOMAS &	CP-8 OR		
(KOPR-SHIELD)		BETTS	CP-16			
120 1 GROUND ROD, 5/8" X 10'		COPPERWELD	GR5810			
			OR JOSLYN	J8340		
121	2	LAG SCREW, FETTER DRIVE, 5/8"X 5"	JOSLYN	J8765		
402	AS REQD	FEEDER RISER	METRO STD	SA-402		

STEFI	POLF	SINGLE	FFFDFR	MATERIAL	IIST	(SFF	PACE 4)

ITEM #	M # QTY DESCRIPTION		MANUFACTURER	CAT. NO.
67	1	CLOVERLEAF EPOXIROD STANDOFF	CHANCE	C653-1038
78	1	CONNECTOR, PARALLEL CLAMP	BURNDY	QPX342C
80	AS REQD	3/4" X 0.030" SS BANDING TYPE 201	BAND-IT	C206
85	1	1000 VOLT DC ARRESTOR 970 MCOV	IMPULSE	P/N 1057
115	1	STAINLESS STEEL BOLT WITH WASHERS & LOCK WASHERS		
116	*	WIRE, 2 OR 5 KV, #4 AWG CU,		
		JACKETED, UNSHIELDED		
402	AS REQD	FEEDER RISER	METRO STD	SA-402

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LIGHTNING ARRESTER SINGLE FEEDER RISER MATERIAL LIST

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SHT	5	OF	6

WOOD POLE DOUBLE FEEDER MATERIAL LIST (SEE PAGE 1)					
ITEM # QTY DESCRIPTION MAN				CAT. NO.	
77	AS REQD	ELEC WARNING TAPE, 6" YELLOW	BRADY	UT 20-Y6	
78	2	CONNECTOR, PARALLEL CLAMP	BURNDY	QPX342C	
81	1	CONNECTOR, SERVICE, SPLIT BOLT	BURNDY	KS20	
83	1	MOLDING, PLASTIC, GROUND WIRE, 1/2" X 1/16" X 8'	JOSLYN	PM128	
85	2	1000 VOLT DC ARRESTOR 970 MCOV	IMPULSE	P/N 1057	
91	AS REQD	STAPLES, ROLLED POINT, GALV, 2" X 1/2" X 0.162"	JOSLYN	J156	
93	AS REQD	STAPLES, ROLLED POINT, GALV, 1 3/4" X 1/4" X 0.148"	JOSLYN	J1673	
115 2 STAINLESS STEEL BOLT WITH WASHER & LOCK WASHERS 116 * WIRE, 2 OR 5 KV, #4 AWG CU, JACKETED, UNSHIELDED		STAINLESS STEEL BOLT WITH WASHERS & LOCK WASHERS			
117	VARIES	WIRE, #6 AWG CU, SOLID, SOFT, O. 031" POLYETHYLENE INSULATED			
118	1	GROUND ROD CLAMP	COPPERWELD	ABH58	
119	AS REQD	CONDUCTIVE & ANTI-SEIZE COMPOUND (KOPR-SHIELD)	THOMAS & BETTS	CP-8	
120	1	GROUND ROD, 5/8" X 10'	COPPERWELD OR JOSLYN	GR5810 J8340	
402	AS REQD	FEEDER RISER	METRO STD	SA-402	


	STEEL POLE DOUBLE FEEDER MATERIAL LIST (SEE PAGE 3)				
ITEM # QTY DESCRIPTION		MANUFACTURER	CAT. NO.		
78	2	CONNECTOR, PARALLEL CLAMP	BURNDY	QPX342C	
85	2	1000 VOLT DC ARRESTOR 970 MCOV	IMPULSE	P/N 1057	
115	115 2 STAINLESS STEEL BOLT WITH WASHERS				
	& LOCK WASHERS				
116	*	WIRE, 2 OR 5 KV, #4 AWG CU,			
		JACKETED, UNSHIELDED			
402	AS REQD	FEEDER RISER	METRO STD	SA-402	

DESIGNED DPG	CHKD: DPG	
DR: DOW	scale: NONE	
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LIGHTNING ARRESTER
DOUBLE FEEDER
MATERIAL LIST

DATE:
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DWG. NO.
SA-401
SHT 6 OF 6



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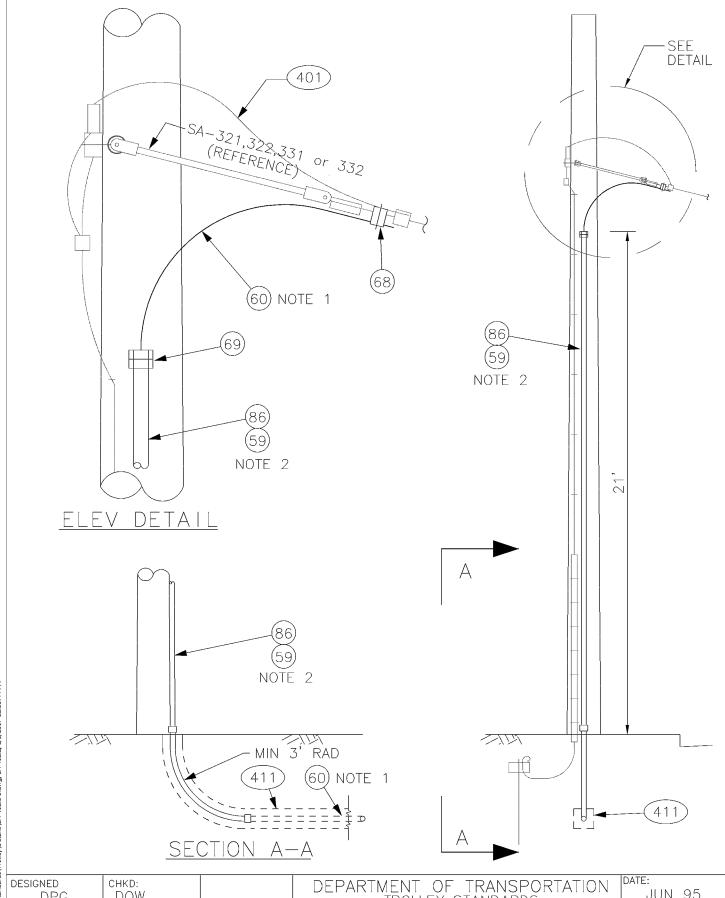
DR: SCALE: NONE

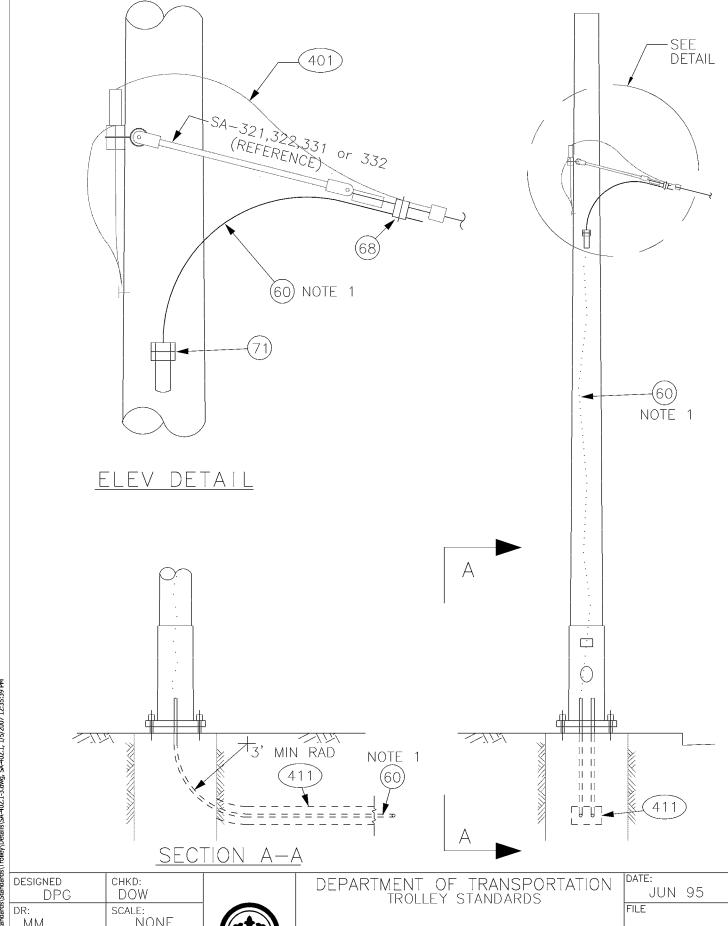RECOM. CONTRACT:

APPROVED King County

FEEDER RISER (STEEL POLE)

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SA-	-402
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DEPARTMENT OF TRANSPORTATION TROLLEY STANDARDS

FEEDER RISER (WOOD POLE)

DATE:			
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SHT	2	OF	3

	STEEL POLE MATERIAL LIST (SEE PAGE 1)			
ITEM #	ITEM # QTY DESCRIPTION		MANUFACTURER	CAT. NO.
60	AS REQD	FEED SPAN CABLE 500 KCM CU, UN-		
		SHIELDED, 5 KV EPR W/ PVC JACKET		
68	1 or 2	UNIVERSAL SERVICE CONNECTOR	BURNDY	KVSU 34
71	1 or 2	WATERTIGHT STR STRAIN RELIEF	□-Z-GEDNEY	SR 15012
		CONN 1 1/2" CONDUIT		H. D. GALV.
401	AS REQD	LIGHTNING ARRESTER	METRO STD	SA-401
411	AS REQD	DUCTBANK	METRO STD	SA-411

	WOOD POLE MATERIAL LIST (SEE PAGE 2)			
ITEM # QTY DESCRIPTION		MANUFACTURER	CAT. NO.	
59	AS REQD	CONDUIT CLAMP W/2" MTG SCREW		
60	AS REQD	FEED SPAN CABLE 500 KCM CU, UN-		
		SHIELDED, 5 KV EPR W/ PVC JACKET		
68	1 or 2	UNIVERSAL SERVICE CONNECTOR	BURNDY	KVSU 34
69	1 or 2	SEALING BUSHING, TYPE KR W/ TYPE	D-Z-GEDNEY	KR250 &
		M CABLE SUPPORT 2-1/2" CONDUIT		RPLG-2001-1
86	AS REQD	GALV RIGID STEEL CONDUIT		
401	AS REQD	LIGHTNING ARRESTER	METRO STD	SA-401
411	AS REQD	DUCTBANK	METRO STD	SA-411

NOTES:

- I. ITEM 60 SHALL INCLUDE SUFFICIENT LENGTH TO CONNECT FEED SPAN WITH VAULT SHOWN ON DRAWINGS. COIL 20' AT VAULT END, AND COIL 10' AT FEED SPAN END.
- 2. ITEMS 59 & 86 TO MEET REQUIREMENTS OF SEATTLE CITY LIGHT SPEC U7-10. SINGLE RISER IS SHOWN, A SECOND CONDUIT SHALL BE ADDED FOR DOUBLE FEED RISER.
- 3. ITEM 86 & 411 CONDUIT TO BE PLASTIC COATED GALV RIGID STEEL IN BENDS.


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1	DPG	DPG	
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DEPARTMENT OF TRANSPORTATION TROLLEY STANDARDS


FEEDER RISER MATERIAL LIST

DATE:
JUN 95
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DWG. NO.
SA-402
SHT 3 OF 3



SPECIAL DETAILS

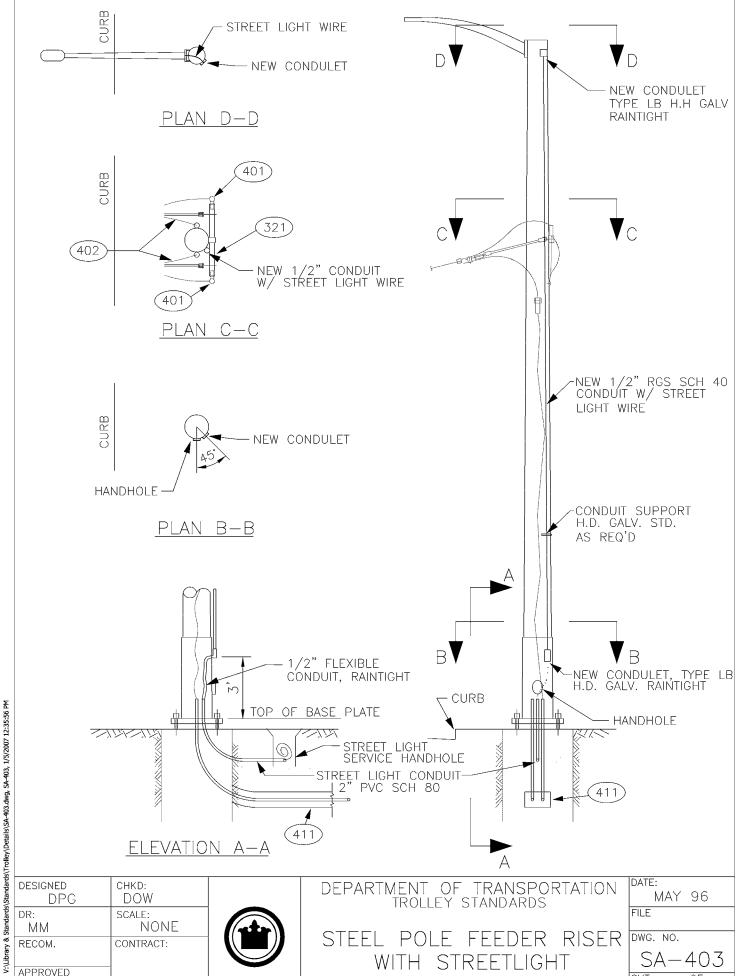King County

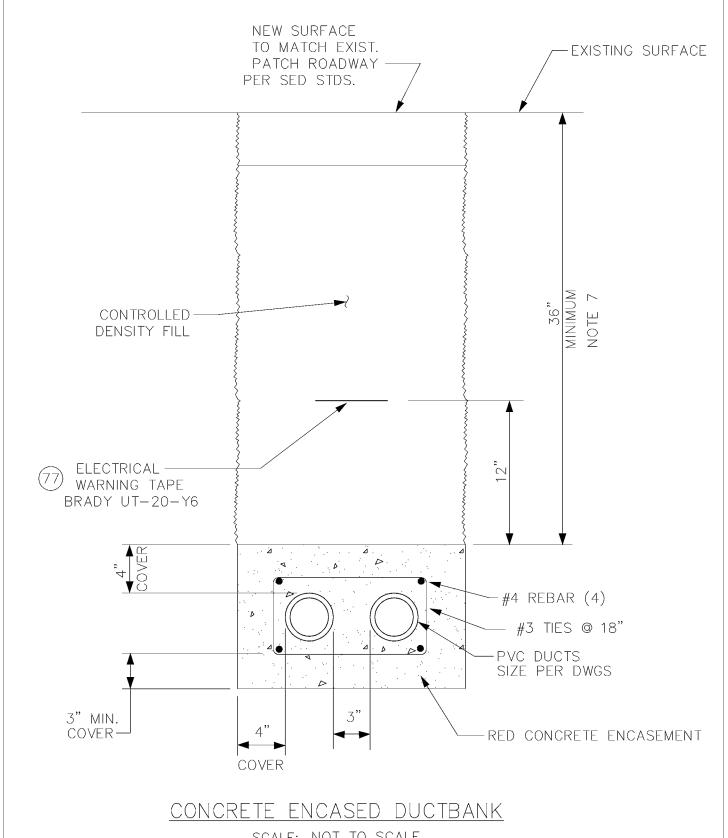

SCALE: NOT TO SCALE

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DEPARTMENT OF TRANSPORTATION TROLLEY STANDARDS

> DUCTBANK CONCRETE ENCASED

DATE:	
JUN 95	
FILE	
DWG. NO.	
SA-41	1
SHT 1 OF	2

1. PVC conduit, fittings, and solvent shall meet the requirements of USDC Commercial Standard CS 207, UL 651, ASTM 2564, NEMA TC2, NEMA TC6 & NEMA TC9.

NOTES:

- 2. All work shall meet the requirements of City of Seattle Board of Public Works Rules: Chapter 4.40 Street and Sidewalk Pavement Opening and Restoration Rules if duct is in Street Right of Way.
- 3. Concrete for duct shall develop a minimum compressive strength of 3000 PSI at 28 days, and shall be colored red by adding ten pounds of iron oxide per cubic yard of concrete. Max. aggregate size shall be 3/8".
- 4. All reinforcing bars shall be deformed billet steel and shall meet the requirements of ASTM A615 Grade 60. All detailing of reinforcement shall meet the requirements of the MANUAL OF STANDARD PRACTICE For Detailing Reinforced Concrete Structures ACI—315 current edition.
- 5. Compacted trench backfill shall be suitable excavated native material, that is acceptable to the engineer. Backfill shall be firmly and through—ly machine tamped to 95% maximum dry density under streets or side—walks, and 90% maximum dry density under landscaped or unimproved areas.
- 6. Pavement patching shall meet the requirements of City of Seattle Department of Engineering Standard Plan No. 404A, if the duct is in street.
- 7. Burial depth shall be 48" minimum at street intersections (maximum depth shall be 72"). Maximum grade shall be 10%. Minimum grade shall be 0.25%.
- 8. Plastic coated GRS conduit shall be used to accomadate horizontal direction changes greater than 15°. The sweep shall be effected with a 12.5 ft minimum radius, and PVC adapter couplings as required. The

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DEPARTMENT OF TRANSPORTATION TROLLEY STANDARDS

DUCTBANK CONCRETE ENCASED DATE:
JUN 95

FILE

DWG. NO.

SA-411

SHT 2 OF 2

NUMBER	TITLE	SHEETS
SA-500	DRAWING INDEX	1
SA-501	MASTER MATERIAL LIST	3
SA-511	TANGENT SPAN	1
SA-515	BRIDLE SPAN	1
SA-541	STEEL POLE BRACKET ASSEMBLY TANGENT CONST	2
SA-542	STEEL POLE BRACKET ASSEMBLY CURVE CONST	2
SA-549	STEEL POLE TANGENT FEEDER BRACKET ASSEMBLY	3
SA-551	WOOD POLE BRACKET ASSEMBLY TANGENT CONST	2
SA-552	WOOD POLE BRACKET ASSEMBLY CURVE CONST	2
SA-553	CONCRETE ATTACHMENT BRACKET ASSEMBLY CURVE CONST	2
SA-557	WOOD POLE BRACKET ASSEMBLY CURVE CONST (2 TRACKS)	2
SA-559	WOOD POLE TANGENT FEEDER BRACKET ASSEMBLY	3
SA-571	SPECIALWORK PULLOFFS	5
SA-572	DEAD END ASSEMBLY	2
SA-590	TEMPORARY INSULATION BOARD	1
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DESIGNED	CHKD: DEPARTMENT OF TRANSPORTATION [CHIND]	ATE:
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King County

CONTRACT:


WATERFRONT STREETCAR DRAWING INDEX

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DWG. NO.
SA-500
SHT 1 OF 1

	MASTER MATERIAL LIST								
ITEM #		METRO	STANDARD	SA-	WHICH	USES	THE	ITEM	
01	511, 515, 571, 5								
02	511, 515, 590								
03	511, 515, 542, 5	549, 552	, 553, 557,	559,	571, 572				
04	511, 515, 542, 5								
05	511, 515, 542, 5	52, 553	, 557, 571,	572					
06	511, 515, 542, 5								
07	511, 515, 542, 5								
08	511, 515, 542, 5	549, 552	, 553, 557,	559,	571, 572				
09	515, 571, 572								
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18	*								
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37 38	* 542, 552, 553, 5	557							
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40	571								
41	549, 559								
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	MASTER MATERIAL LIST							
ITEM #	METRO STANDARD SA- WHICH USES THE ITEM							
43	*							
44	542, 552, 553, 557							
45	542, 552, 553, 557							
46	571							
47	542, 552, 553, 557, 571							
48	*							
49	549, 559							
50	549, 559							
51	549, 559							
52	549, 559							
53	542, 552, 553, 557							
54	542, 552, 553, 557							
55	541, 542, 549, 551, 552, 553, 557, 559							
56	541, 542, 549, 551, 552, 553, 557, 559							
57	541, 542, 549, 551, 552, 553, 557, 559							
58	*							
59	* E40 EE0							
60	549, 559 *							
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65	551, 552, 557, 559							
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67	*							
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69	*							
70	*							
71	*							
72	*							
73	571							
74	590							
75	590							
76	*							
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78	*							
79	541, 551							
80	541, 551							
81	*							
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DPC	DPG DPG WATERFRONT STREETCAR FEB 98							
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RECOM.	CONTRACT: (
APPROVED	MATERIAL LIST SA-501							
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NOTES:

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DR:

TMB

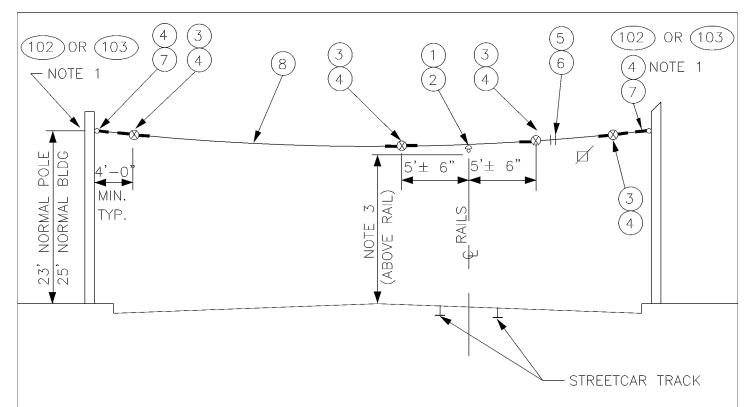RECOM.

APPROVED

CONTRACT:

NONE

SCALE:

- A POLE COLLAR OR POLE EYEBOLT IS REQUIRED PER SA-102 OR SA-103 UNLESS A BUILDING EYEBOLT ATTACHMENT IS USED. INSTALLATION HEIGHT TO BE INDICATED AS REQUIRED ON THE OVERHEAD DRAWINGS.
- 2. PROVIDE TENSION ADJUSTMENT POINTS AT LOCATIONS INDICATED BY "☑". PROVIDE WIRE ROPE CLIPS AT EACH LOCATION. SEE SA-166.
- 3. SEE SA-164 FOR VERTICAL DIMENSION TO TROLLEY WIRE.

King County


	MATERIAL LIST							
ITEM #	QTY		DESCRIPT	TON	MANUFACTURER	CAT. NO.		
01	1	DETRE	DIT CLAMP #	YZZY	WABCD	19293-3007		
02	1	AGC T	ANGENT SPA	AN HANGER	WABCO	19360-2000		
03	4	GUY S	STRAIN INSU	JL	PORCELAIN	504		
					PRODUCTS CO.			
04	9	GUY C	GRIP DEADEN	ND	PREFORMED	CDE-3106		
05	2	WIRE	ROPE CLIP,	5/16″	CROSBY	G450		
06	AS REQ) FRICT	ION TAPE,	3/4" (6 WRAPS)				
07	2	THIME	THIMBLE, 3/8" XHD, DPEN		CROSBY	G414		
08	VARIES	GUY S	TRAND		COPPERWELD	8M		
102	VARIES	FORGE	FORGED THREE-PIECE ADJUSTABLE		KORTICK			
		POLE	BAND, ANNE	EALED & GALVANIZED	MFG CD			
103	VARIES	WOOD	POLE EYEBO	JLT	METRO STD	SA-103		
DESIGNED CHKD: DPG DOW				DEPARTMENT OF T WATERFRONT S	RANSPORTATION STREETCAR	DATE: OCT 95		

TANGENT

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FILE

DWG. NO.

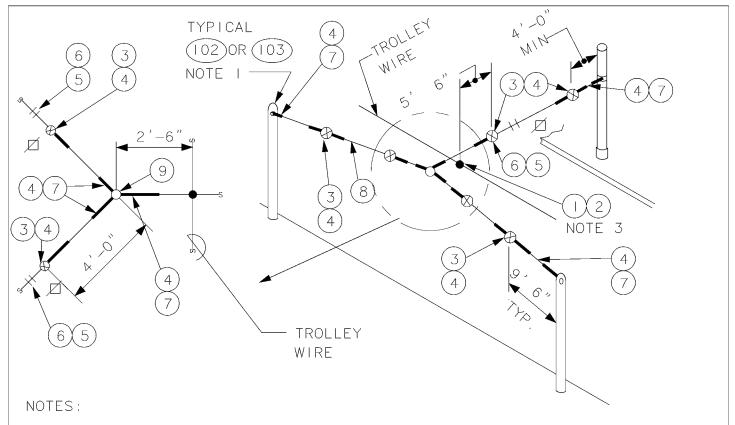

- I. A POLE COLLAR OR POLE EYEBOLT IS REQUIRED PER SA-102 OR SA-103 UNLESS A BUILDING EYEBOLT ATTACHMENT IS USED. INSTALLATION HEIGHT TO BE INDICATED AS REQUIRED ON THE OVERHEAD DRAWINGS.
- 2. PROVIDE TENSION ADJUSTMENT POINTS AT LOCATIONS INDICATED BY "Z". PROVIDE WIRE ROPE CLIPS AT EACH LOCATION. SEE SA-166.
- 3. SEE SA-164 FOR VERTICAL DIMENSION TO TROLLEY WIRE.

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APPROVED

SCALE:

CONTRACT:

NONE

King County

			MATE	RIAL LIST		
ITEM #	QTY		DESCRIPT	TON	MANUFACTURER	CAT. NO.
01	1	DETRO	IIT CLAMP 4	YZZY	WABCO	19293-3007
02	1	AGC T	ANGENT SPA	AN HANGER	WABCO	19360-2000
03	6	GUY S	TRAIN INSU	JL	PORCELAIN	504
					PRODUCTS CO.	
04	15	GUY C	RIP DEADEN	ND	PREFORMED	CDE-3106
05	6	WIRE	WIRE ROPE CLIP, 5/16"		CROSBY	G450
06	AS REC	D FRICT	ION TAPE,	3/4" (6 WRAPS)		
07	6	THIME	BLE, 3/8″ >	(HD, OPEN	CROSBY	G414
08	VARIES	GUY S	TRAND		COPPERWELD	8M
09	1	BULL	BULL RING		WABCO	18567-2000
102	VARIES	FORGE	FORGED THREE-PIECE ADJUSTABLE		KORTICK	
		POLE	BAND, ANNE	EALED & GALVANIZED	MFG CO	
103	VARIES	WOOD	POLE EYEBO	JLT	METRO STD	SA-103
DESIGNED CHKD: DPG DOW				DEPARTMENT OF T WATERFRONT S		DATE: OCT 95

BRIDLE

SPAN


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DWG. NO.

SA - 515

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NOTES:

- 1. STAINLESS STEEL BANDING SHALL BE WRAPPED DOUBLE THICKNESS AROUND ITEM 57 PRIOR TO CLAMPING.
- 2. SEE SA-164 FOR HORIZONTAL & VERTICAL DIMENSIONS TO TROLLEY WIRE.
- 3. DRILL 1/2" HOLE IN TUBE TO MATCH HOLE IN ITEMS 108 & 109 FOR INSERTION OF 3/8" SS BOLT.

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DEPARTMENT OF TRANSPORTATION WATERFRONT STREETCAR

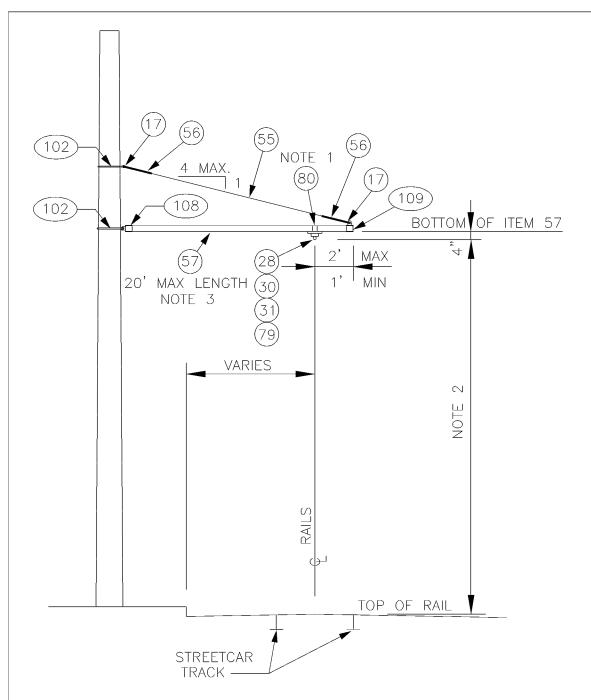STEEL POLE
BRACKET ASSEMBLY
TANGENT CONSTRUCTION

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MATERIAL LIST							
ITEM ;	# QTY	DESCRIPTION	MANUFACTURER	CAT. NO.			
17	2	THIMBLE, 1/2" XHD, OPEN	CROSBY	G414			
28	1	INSULATOR SPOOL	WABCO	16835-2000			
30	1	TROLLEY SUPPORT-LARGE PIPE ARMS	WABC□	54940-4001			
31	1	SPRING DETROIT CLAMP	WABC□	54959-3001			
55	VARIES	PHILLYSTRAN (3/8")	PHILLYSTRAN	HPTG 6700I			
			INC.				
56	2	PHILLYSTRAN BIG GRIP	PHILLYSTRAN	PLP 2755			
			INC.				
57	VARIES	FIBERGLASS REINFORCED PLASTIC	MORRISON	EXTREN			
		(FRP) TUBE 3 1/2" Ø X 1/2"	MOLDED FG	SERIES 525			
79	1	5/8"-11 UNC X 1 3/8" STUD					
80	VARIES	3/4" STAINLESS STEEL BANDING	BAND-IT	TYPE 201			
102	2	FORGED THREE-PIECE ADJUSTABLE	KORTICK				
		POLE BAND, ANNEALED & GALVANIZED	MFG CO				
108	1	MAST ARM POLE END CAP	METRO STD	SA-108			
109	1	MAST ARM ARM END CAP	METRO STD	SA-109			


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DEPARTMENT OF TRANSPORTATION WATERFRONT STREETCAR

STEEL POLE
BRACKET ASSEMBLY
TANGENT CONSTRUCTION

DATE:
OCT 95
FILE
DWG. NO.
SA-541
SHT 2 OF 2



- 1. ITEMS 4,7,28,50 & 53 TO BE USED FOR 1° TO 5° ANGLE TURN. ITEMS 4, 7,28,47 & 54 TO BE USED FOR 5° TO 7.5° ANGLE TURN. ITEMS 12,44, & 45 TO BE USED FOR 8° OR GREATER ANGLE TURN. SEGMENTS SHALL NOT BE USED FOR ANGLES GREATER THAN 12° WHEN POLE IS ON INSIDE OF CURVE.
- PROVIDE TENSION ADJUSTMENT POINTS AT LOCATIONS INDICATED BY "". PROVIDE WIRE ROPE CLIPS AT THESE LOCATIONS. SEE SA-166.
- DRILL 1/2" HOLE IN TUBE TO MATCH HOLE IN ITEMS 108 & 109 FOR INSERTION OF 3/8" SS BOLT.
- 4. SEE SA-164 FOR HORIZONTAL & VERTICAL DIMENSIONS TO TROLLEY WIRE.
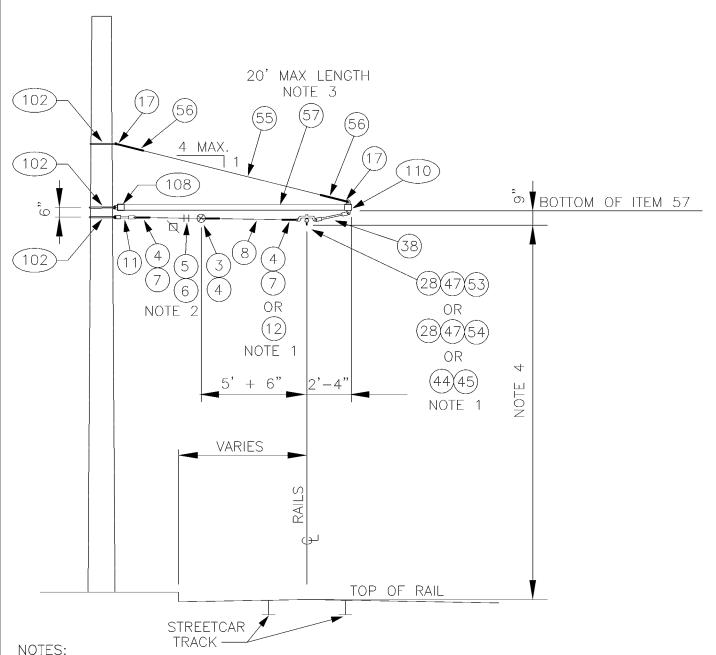
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DEPARTMENT OF TRANSPORTATION WATERFRONT STREETCAR

STEEL POLE BRACKET ASSEMBLY CURVE CONSTRUCTION

DATE:
JUN 95
FILE
DWG. NO.
SA - 542
SHT 1 OF 2

	MATERIAL LIST				
ITEM #	QTY	DESCRIPTION	MANUFACTURER	CAT. NO.	
03	1	GUY STRAIN INSUL	PORCELAIN PRODUCTS CO.	504	
04	VARIES	GUY GRIP DEADEND	PREFORMED	CDE-3106	
05	2	WIRE ROPE CLIP, 5/16"	CROSBY	G450	
06	AS REQD	FRICTION TAPE, 3/4" (6 WRAPS)			
07	VARIES	THIMBLE, 3/8" XHD, OPEN	CROSBY	G414	
08	VARIES	GUY STRAND	COPPERWELD	8M	
1 1	1	7/8 TRANSLITE STRAIN INSUL CL-CL	WABCO	54975-6120	
12	VARIES	7/8 TRANSLITE STRAIN INSUL CL-EYE	WABCO	55339-6120	
17	2	THIMBLE, 1/2" XHD, OPEN	CROSBY	G414	
28	VARIES	INSULATOR SPOOL	WABCO	16835-2000	
38	1	7/8 TRANSLITE STRAIN INSUL CL-CL	WABCO	54975-6200	
44	VARIES	RUNNER, 6 FT TYPE C, 8 TO 12 DEG	WABCO	21375-2000	
45	VARIES	PLATE-STRAIN 5 TO 12 DEG	WABCO	20290-2000	
47	VARIES	DOUBLE CURVE HANGER TYPE A-2	WABCO	14073-2000	
53	VARIES	CURVE RAIL	K & M	851 B412/0	
54	VARIES	CURVE RAIL	K & M	851 B412/1	
55	VARIES	PHILLYSTRAN (3/8")	PHILLYSTRAN INC.	HPTG 6700I	
56	2	PHILLYSTRAN BIG GRIP	PHILLYSTRAN INC.	PLP 2755	
57	VARIES	FIBERGLASS REINFORCED PLASTIC	MORRISON	EXTREN	
		(FRP) TUBE 3 1/2″ Ø X 1/2″	MOLDED FG	SERIES 525	
102	3	FORGED THREE-PIECE ADJUSTABLE	KORTICK		
		POLE BAND, ANNEALED & GALVANIZED	MFG CO		
108	1	MAST ARM POLE END CAP	METRO STD	SA-108	
110	1	MAST ARM UNDERSLING END CAP	METRO STD	SA-110	


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DEPARTMENT OF TRANSPORTATION WATERFRONT STREETCAR

STEEL POLE
BRACKET ASSEMBLY
CURVE CONSTRUCTION

DATE:
OCT 95
FILE
DWG. NO.
SA-542
SHT 2 OF 2



NOTES:

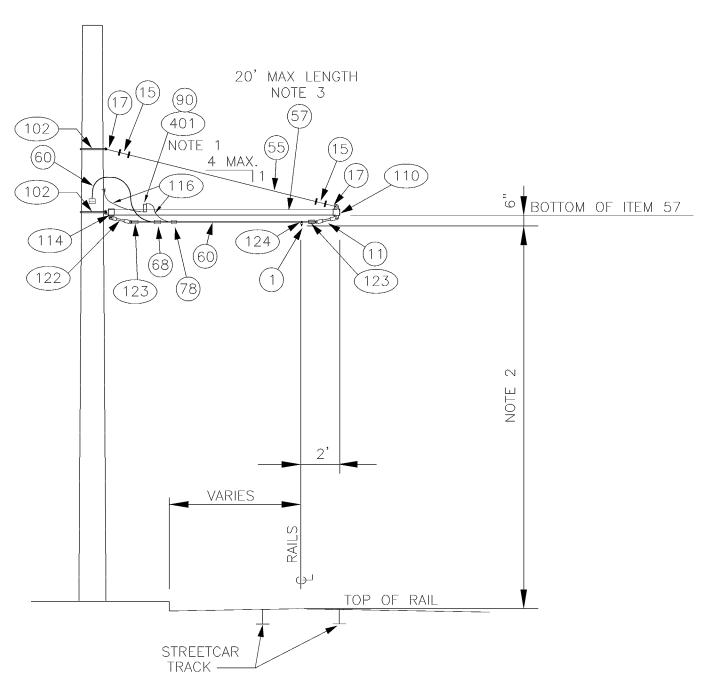- 1. SEE DETAIL 1 ON SHEET 2 FOR DETAILS.
- 2. SEE SA-164 FOR HORIZONTAL & VERTICAL DIMENSIONS TO TROLLEY WIRE.
- 3. DRILL 1/2" HOLE IN TUBE TO MATCH HOLE IN ITEMS 110 & 114 FOR INSERTION OF 3/8" SS BOLT.
- 4. ALL FERROUS METAL SHOULD BE HOT DIP GALV. AFTER FABRICATION.


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DEPARTMENT OF TRANSPORTATION WATERFRONT STREETCAR

STEEL POLE TANGENT FEEDER BRACKET ASSEMBLY

DATE:
MAY 98
FILE
DWG. NO.
SA - 549
SHT 1 OF 3



DETAIL 1

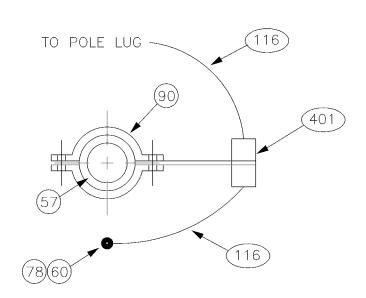LIGHTNING ARRESTOR ATTACHMENT DETAIL

INSTALL CLAMP & ARRESTOR AT TWO FEET FROM POLE

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DEPARTMENT OF TRANSPORTATION WATERFRONT STREETCAR

STEEL POLE TANGENT FEEDER BRACKET ASSEMBLY

DATE:
MAY 98
FILE
DWG. NO.
SA-549
SHT 2 OF 3

	MATERIAL LIST			
ITEM #	QTY	DESCRIPTION	MANUFACTURER	CAT. NO.
01	1	DETROIT CLAMP ASSY	WABCO	19293-3007
1 1	1	7/8 TRANSLITE STRAIN INSUL CL-CL	WABCO	54975-6120
15	4	WIRE ROPE CLIP, 3/8"	CROSBY	G450
17	2	THIMBLE, 1/2" XHD, OPEN	CROSBY	G414
55	AS REQD	PHILLYSTRAN (3/8")	PHILLYSTRAN	HPTG 6700I
			INC.	
57	VARIES	FIBERGLASS REINFORCED PLASTIC	MORRISON	EXTREN
		(FRP) TUBE 3 1/2" Ø X 1/2"	MOLDED FG	SERIES 525
60	AS REQD	FEED SPAN CABLE		
68	1	UNIVERSAL SERVICE CONNECTOR	BURNDY	KVSU34
78	1	CONNECTOR, PARALLEL CLAMP	BURNDY	QPX342C
90	1	HEAVY PIPE CLAMP, GALV, 3" IPS	GRINNELL	FIG. 216
102	2	FORGED THREE-PIECE ADJUSTABLE	KORTICK	
		POLE BAND, ANNEALED & GALVANIZED	MFG CO	
110	1	MAST ARM UNDERSLING END CAP	METRO STD	SA-110
114	1	MAST ARM POLE END CAP W/ BOT. TAB	METRO STD	SA-114
116	VARIES	WIRE, 2 OR 5 KV, #4 AWG CU,		
		JACKETED, UNSHIELDED		
122	1	7/8 TRANSLITE STRAIN INSUL CL-TB	WABCO	54982-3001
123	2	FEEDER-TYPE E DEAD END	WABCO	21590-2000
124	1	CLAMP ASSEMBLY	WABC□	54936-3006
401	1	LIGHTNING ARRESTOR	METRO STD	SA-401


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DEPARTMENT OF TRANSPORTATION WATERFRONT STREETCAR

STEEL POLE TANGENT FEEDER BRACKET ASSEMBLY

DATE:
MAY 98
FILE
DWG. NO.
SA-549
SHT 3 OF 3



NOTES:

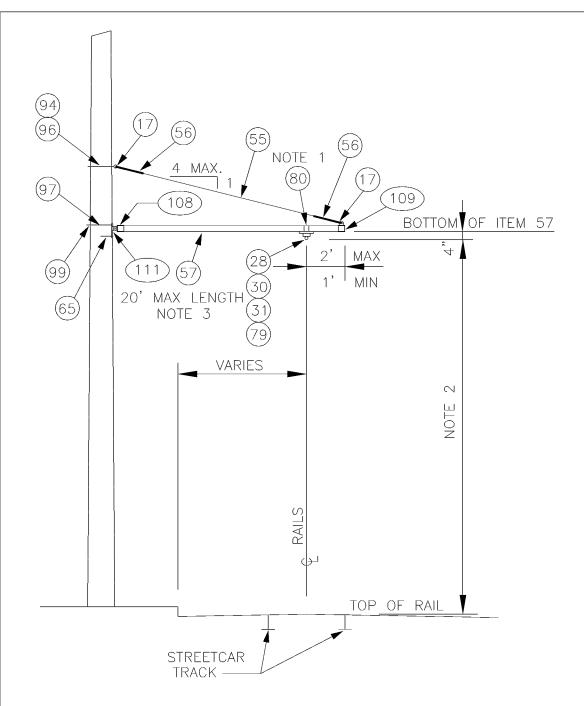- 1. STAINLESS STEEL BANDING SHALL BE WRAPPED DOUBLE THICKNESS AROUND ITEM 57 PRIOR TO CLAMPING.
- 2. SEE SA-164 FOR HORIZONTAL & VERTICAL DIMENSIONS TO TROLLEY WIRE.
- 3. DRILL 1/2" HOLE IN TUBE TO MATCH HOLE IN ITEMS 108 & 109 FOR INSERTION OF 3/8" SS BOLT.

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DEPARTMENT OF TRANSPORTATION WATERFRONT STREETCAR

WOOD POLE
BRACKET ASSEMBLY
TANGENT CONSTRUCTION

DATE:
FEB 98
FILE
DWG. NO.
SA - 551
SHT 1 OF 2

MATERIAL LIST				
ITEM #	QTY	DESCRIPTION	MANUFACTURER	CAT. NO.
17	2	THIMBLE, 1/2" XHD, OPEN	CROSBY	G414
28	1	INSULATOR SPOOL	WABCO	16835-2000
30	1	TROLLEY SUPPORT-LARGE PIPE ARMS	WABCD	54940-4001
31	1	SPRING DETROIT CLAMP	WABCO	54959-3001
55	VARIES	PHILLYSTRAN (3/8")	PHILLYSTRAN	HPTG 6700I
			INC.	
56	2	PHILLYSTRAN BIG GRIP	PHILLYSTRAN	PLP 2755
			INC.	
57	VARIES	FIBERGLASS REINFORCED PLASTIC	MORRISON	EXTREN
		(FRP) TUBE 3 1/2" Ø X 1/2"	MOLDED FG	SERIES 525
65	1	LAG SCREW, FETTER DRIVE, 1/2"X 4"	JOSLYN	J8754
79	1	5/8"-11 UNC X 1 3/8" STUD		
80	VARIES	3/4" STAINLESS STEEL BANDING	BAND-IT	TYPE 201
94	1	5/8" OVAL EYEBOLT W/ NUT	JOSLYN	J94XX
96	1	SQ CURVED WASHER 3" X 3" X 1/4",	JOSLYN	J113
		11/16" DIA		
97	1	3/4" MACHINE BOLT	JOSLYN	J89XX
99	1	SQ CURVED WASHER 3" X 3" X 1/4",	JOSLYN	J6823
		13/16" DIA		
108	1	MAST ARM POLE END CAP	METRO STD	SA-108
109	1	MAST ARM ARM END CAP	METRO STD	SA-109
111	1	WOOD POLE MOUNTING BRACKET	METRO STD	SA-111


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DEPARTMENT OF TRANSPORTATION WATERFRONT STREETCAR

WOOD POLE BRACKET ASSEMBLY TANGENT CONSTRUCTION

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- 1 ITEMS
- 1. ITEMS 4,7,28,50 & 53 TO BE USED FOR 1° TO 5° ANGLE TURN. ITEMS 4, 7,28,47 & 54 TO BE USED FOR 5° TO 7.5° ANGLE TURN. ITEMS 12,44, & 45 TO BE USED FOR 8° OR GREATER ANGLE TURN. SEGMENTS SHALL NOT BE USED FOR ANGLES GREATER THAN 12° WHEN POLE IS ON INSIDE OF CURVE.
- 2. PROVIDE TENSION ADJUSTMENT POINTS AT LOCATIONS INDICATED BY "□".
 PROVIDE WIRE ROPE CLIPS AT THESE LOCATIONS. SEE SA-166.
- 3. DRILL 1/2" HOLE IN TUBE TO MATCH HOLE IN ITEMS 108 & 109 FOR INSERTION OF 3/8" SS BOLT.
- 4. SEE SA-164 FOR HORIZONTAL & VERTICAL DIMENSIONS TO TROLLEY WIRE.

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DEPARTMENT OF TRANSPORTATION WATERFRONT STREETCAR

WOOD POLE BRACKET ASSEMBLY CURVE CONSTRUCTION
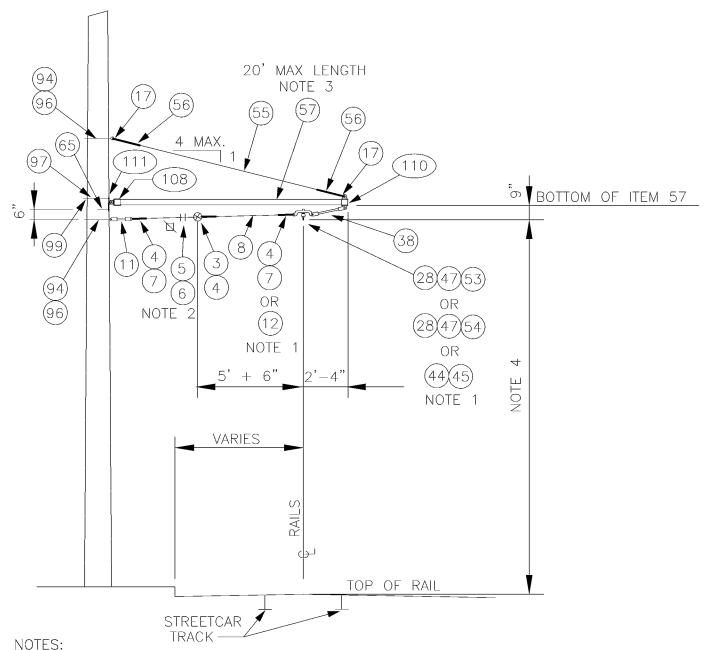
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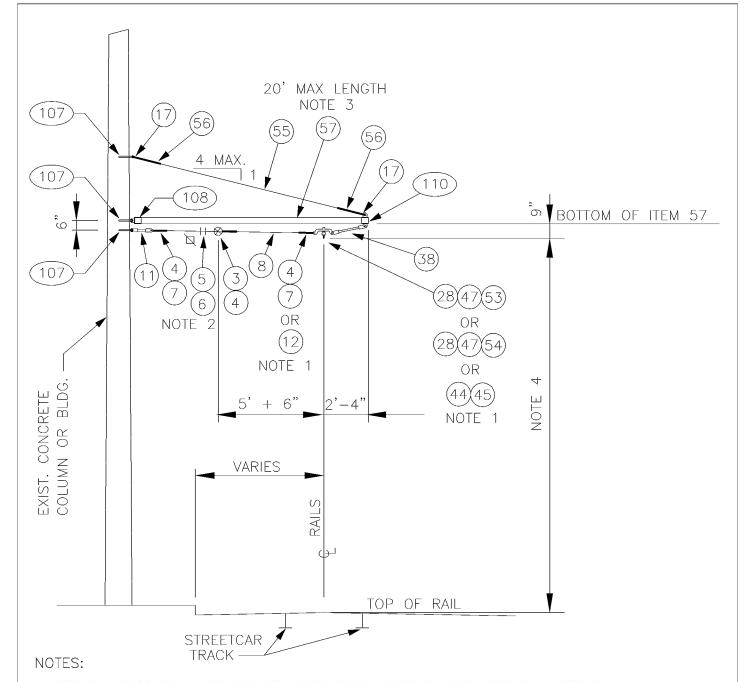
	MATERIAL LIST				
ITEM #	TEM # QTY DESCRIPTION		MANUFACTURER	CAT. NO.	
03	03 1 GUY STRAIN INSUL		PORCELAIN PRODUCTS CO.	504	
04	VARIES	GUY GRIP DEADEND	PREFORMED	CDE-3106	
05	2	WIRE ROPE CLIP, 5/16"	CROSBY	G450	
06	AS REQD	FRICTION TAPE, 3/4" (6 WRAPS)			
07	VARIES	THIMBLE, 3/8" XHD, OPEN	CROSBY	G414	
08	VARIES	GUY STRAND	COPPERWELD	8M	
1 1	1	7/8 TRANSLITE STRAIN INSUL CL-CL	WABCO	54975-6120	
12	VARIES	7/8 TRANSLITE STRAIN INSUL CL-EYE	WABCO	55339-6120	
17	2	THIMBLE, 1/2" XHD, OPEN	CROSBY	G414	
28	VARIES	INSULATOR SPOOL	WABCO	16835-2000	
38	1	7/8 TRANSLITE STRAIN INSUL CL-CL	WABCO	54975-6200	
44	VARIES	RUNNER, 6 FT TYPE C, 8 TO 12 DEG	WABCD	21375-2000	
45	45 VARIES PLATE-STRAIN 5 TO 12 DEG		WABCD	20290-2000	
47	VARIES	DOUBLE CURVE HANGER TYPE A-2	WABCO	14073-2000	
53	VARIES	CURVE RAIL	K & M	851 B412/0	
54	VARIES	CURVE RAIL	K & M	851 B412/1	
55	55 VARIES PHILLYSTRAN (3/8")		PHILLYSTRAN INC.	HPTG 6700I	
56	2	PHILLYSTRAN BIG GRIP	PHILLYSTRAN INC.	PLP 2755	
57	VARIES	FIBERGLASS REINFORCED PLASTIC	MORRISON	EXTREN	
		(FRP) TUBE 3 1/2" Ø X 1/2"	MOLDED FG	SERIES 525	
65	1	LAG SCREW, FETTER DRIVE, 1/2"X 4"	JOSLYN	J8754	
94	2	5/8" OVAL EYEBOLT W/ NUT	JOSLYN	J94XX	
96	2	SQ CURVED WASHER 3" X 3" X 1/4", 11/16" DIA	JOSLYN	J113	
97	1	3/4" MACHINE BOLT	JOSLYN	J89XX	
99	1	SQ CURVED WASHER 3" X 3" X 1/4", 13/16" DIA	JOSLYN	J6823	
108	1	MAST ARM POLE END CAP	METRO STD	SA-108	
110	1	MAST ARM UNDERSLING END CAP	METRO STD	SA-110	
111	1	WOOD POLE MOUNTING BRACKET	METRO STD	SA-111	

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WOOD POLE BRACKET ASSEMBLY CURVE CONSTRUCTION

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- 1. ITEMS 4,7,28,50 & 53 TO BE USED FOR 1° TO 5° ANGLE TURN. ITEMS 4, 7,28,47 & 54 TO BE USED FOR 5° TO 7.5° ANGLE TURN. ITEMS 12,44, & 45 TO BE USED FOR 8° OR GREATER ANGLE TURN. SEGMENTS SHALL NOT BE USED FOR ANGLES GREATER THAN 12° WHEN POLE IS ON INSIDE OF CURVE.
- 3. DRILL 1/2" HOLE IN TUBE TO MATCH HOLE IN ITEMS 108 & 109 FOR INSERTION OF 3/8" SS BOLT.
- 4. SEE SA-164 FOR HORIZONTAL & VERTICAL DIMENSIONS TO TROLLEY WIRE.

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CONCRETE ATTACHMENT BRACKET ASSEMBLY CURVE CONSTRUCTION

DATE:
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DWG. NO.
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SHT 1 OF 2

	MATERIAL LIST				
ITEM # QTY DESCRIPTION		MANUFACTURER	CAT. NO.		
03	1	GUY STRAIN INSUL	PORCELAIN	504	
			PRODUCTS CO.		
04	VARIES	GUY GRIP DEADEND	PREFORMED	CDE-3106	
05	2	WIRE ROPE CLIP, 5/16"	CROSBY	G450	
06	AS REQD	FRICTION TAPE, 3/4" (6 WRAPS)			
07	VARIES	THIMBLE, 3/8" XHD, OPEN	CROSBY	G414	
08	VARIES	GUY STRAND	COPPERWELD	8M	
1 1	1	7/8 TRANSLITE STRAIN INSUL CL-CL	WABCD	54975-6120	
12	VARIES	7/8 TRANSLITE STRAIN INSUL CL-EYE	WABCO	55339-6120	
17	2	THIMBLE, 1/2" XHD, OPEN	CROSBY	G414	
28	VARIES	INSULATOR SPOOL	WABCO	16835-2000	
38	1	7/8 TRANSLITE STRAIN INSUL CL-CL	WABCO	54975-6200	
44	VARIES	RUNNER, 6 FT TYPE C, 8 TO 12 DEG	WABCO	21375-2000	
45	VARIES	PLATE-STRAIN 5 TO 12 DEG	WABCO	20290-2000	
47	VARIES	DOUBLE CURVE HANGER TYPE A-2	WABCO	14073-2000	
53	VARIES	CURVE RAIL	K & M	851 B412/0	
54	VARIES	CURVE RAIL	K & M	851 B412/1	
55	VARIES	PHILLYSTRAN (3/8")	PHILLYSTRAN	HPTG 6700I	
INC.					
56	2	PHILLYSTRAN BIG GRIP	PHILLYSTRAN	PLP 2755	
I NC.					
57	VARIES	FIBERGLASS REINFORCED PLASTIC	MORRISON	EXTREN	
		(FRP) TUBE 3 1/2" Ø X 1/2"	MOLDED FG	SERIES 525	
107	3	STAINLESS STEEL EYEBOLT	METRO STD	SA-107	
108	1	MAST ARM POLE END CAP	METRO STD	SA-108	
110	1	MAST ARM UNDERSLING END CAP	METRO STD	SA-110	

NOTES:

1. INSTALL ITEM 107 PER SA-221.


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DEPARTMENT OF TRANSPORTATION WATERFRONT STREETCAR

CONCRETE ATTACHMENT BRACKET ASSEMBLY CURVE CONSTRUCTION

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- I. ITEMS 4,7,28,50 & 53 TO BE USED FOR I TO 5 ANGLE TURN. ITEMS 4, 7,28,47 & 54 TO BE USED FOR 5 TO 7.5 ANGLE TURN. ITEMS 12,44, & 45 TO BE USED FOR 8 OR GREATER ANGLE TURN. SEGMENTS SHALL NOT BE USED FOR ANGLES GREATER THAN 12 WHEN POLE IS ON INSIDE OF CURVE.
- 2. PROVIDE TENSION ADJUSTMENT POINTS AT LOCATIONS INDICATED BY "\(\bigvee\)". PROVIDE WIRE ROPE CLIPS AT THESE LOCATIONS. SEE SA-166.
- 3. DRILL 1/2" HOLE IN TUBE TO MATCH HOLE IN ITEMS 108 & 109 FOR INSERTION OF 3/8" SS BOLT.
- 4. SEE SA-164 FOR HORIZONTAL & VERTICAL DIMENSIONS TO TROLLEY WIRE.

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DEPARTMENT OF TRANSPORTATION WATERFRONT STREETCAR

WOOD POLE
BRACKET ASSEMBLY
CURVE CONST (2 TRACKS)
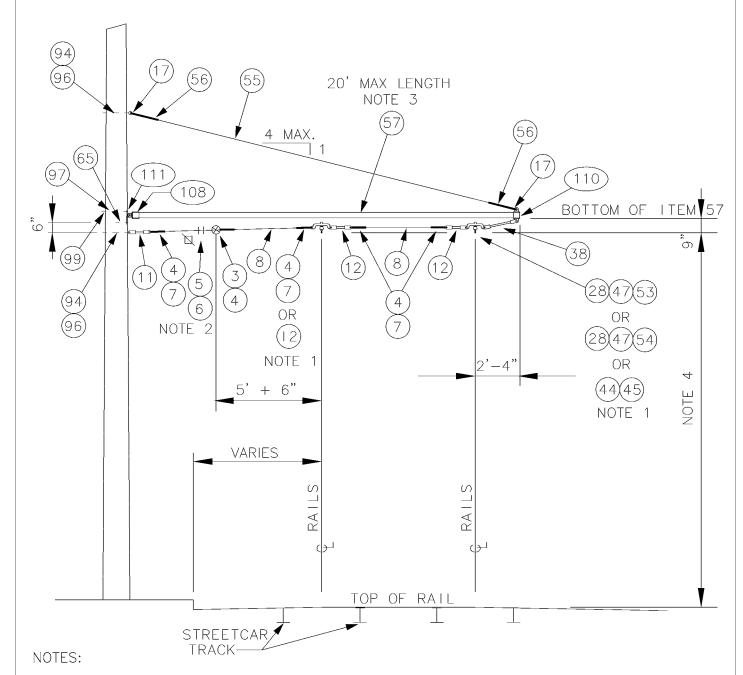
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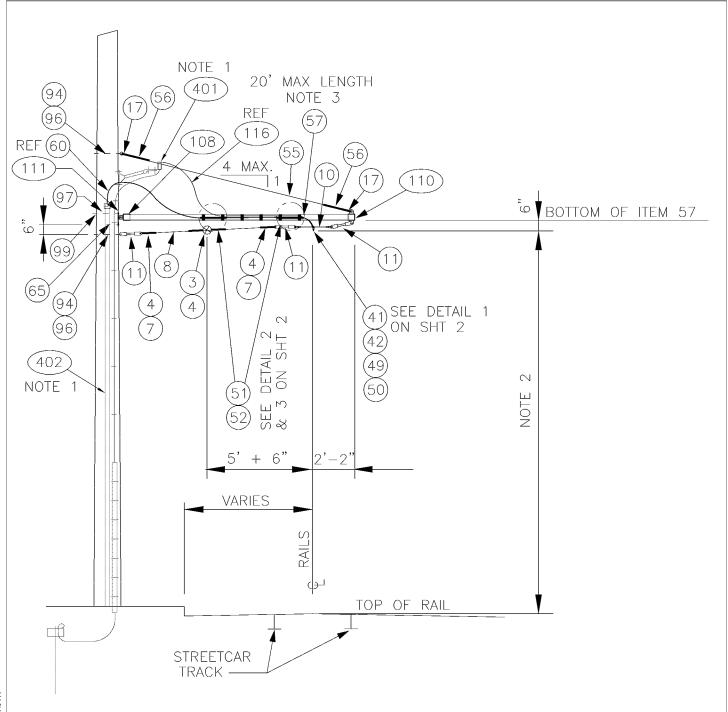
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ITEM	EM # QTY DESCRIPTION		MANUFACTURER	CAT. NO.	
		PORCELAIN PRODUCTS CO.	504		
04	VARIES	GUY GRIP DEADEND	PREFORMED	CDE-3106	
05	2	WIRE ROPE CLIP, 5/16"	CROSBY	G450	
06	AS REQD	FRICTION TAPE, 3/4" (6 WRAPS)			
07	VARIES	THIMBLE, 3/8" XHD, OPEN	CROSBY	G414	
08	VARIES	GUY STRAND	COPPERWELD	8M	
1 1	1	7/8 TRANSLITE STRAIN INSUL CL-CL	WABCO	54975-6120	
12	VARIES	7/8 TRANSLITE STRAIN INSUL CL-EYE	WABCO	55339-6120	
17	2	THIMBLE, 1/2" XHD, OPEN	CROSBY	G414	
28	VARIES	INSULATOR SPOOL	WABCD	16835-2000	
38	1	7/8 TRANSLITE STRAIN INSUL CL-CL	WABCD	54975-6200	
44	VARIES	RUNNER, 6 FT TYPE C, 8 TO 12 DEG	WABCO	21375-2000	
45	VARIES	PLATE-STRAIN 5 TO 12 DEG	WABCO	20290-2000	
47	VARIES	DOUBLE CURVE HANGER TYPE A-2	WABC□	14073-2000	
53	VARIES	CURVE RAIL	K & M	851 B412/0	
54	VARIES	CURVE RAIL	K & M	851 B412/1	
55	VARIES	PHILLYSTRAN (3/8")	PHILLYSTRAN INC.	HPTG 6700I	
56	2	PHILLYSTRAN BIG GRIP	PHILLYSTRAN INC.	PLP 2755	
57	VARIES	FIBERGLASS REINFORCED PLASTIC	MORRISON	EXTREN	
		(FRP) TUBE 3 1/2" Ø X 1/2"	MOLDED FG	SERIES 525	
65	1	LAG SCREW, FETTER DRIVE, 1/2"X 4"	JOSLYN	J8754	
94	2	5/8" DVAL EYEBOLT W/ NUT	JOSLYN	J94XX	
96	2	SQ CURVED WASHER 3" X 3" X 1/4", 11/16" DIA	JOSLYN	J113	
97	1	3/4" MACHINE BOLT	JOSLYN	J89XX	
99	1	SQ CURVED WASHER 3" X 3" X 1/4", 13/16" DIA	JOSLYN	J6823	
108	1	MAST ARM POLE END CAP	METRO STD	SA-108	
110	-	MAST ARM UNDERSLING END CAP	METRO STD	SA-110	
111	1	WOOD POLE MOUNTING BRACKET	METRO STD	SA-111	

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WOOD POLE BRACKET ASSEMBLY CURVE CONST (2 TRACKS)

DATE:
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SHT 2 OF 2



NOTES:

- 1. 60,116 & 401 SHOWN FOR REFERENCE ONLY, SEE SA-401 & SA-402 FOR DETAILS.
- 2. SEE SA-164 FOR HORIZONTAL & VERTICAL DIMENSIONS TO TROLLEY WIRE.
- 3. DRILL 1/2" HOLE IN TUBE TO MATCH HOLE IN ITEMS 108 & 109 FOR INSERTION OF 3/8" SS BOLT.
- 4. ALL FERROUS METAL SHOULD BE HOT DIP GALV. AFTER FABRICATION.


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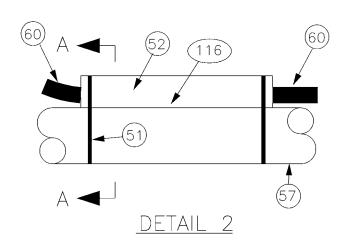



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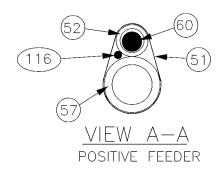
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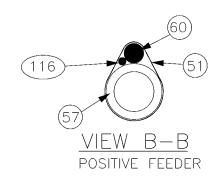
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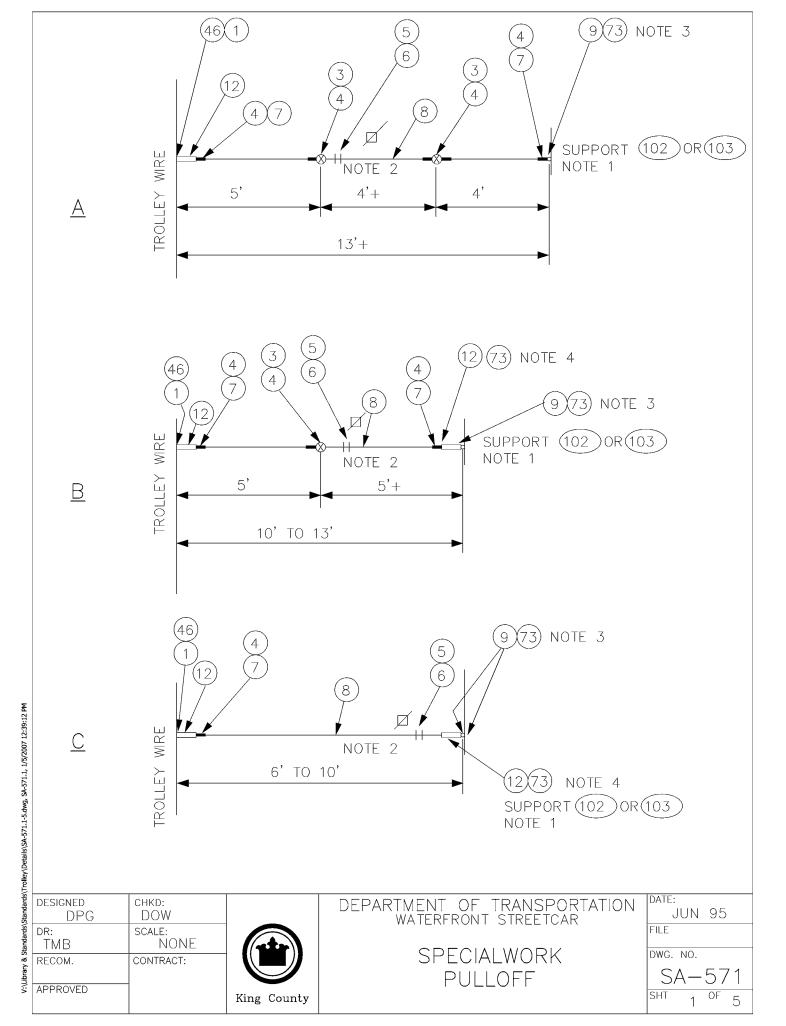
	MATERIAL LIST				
ITEM	# QTY	DESCRIPTION	MANUFACTURER	CAT. NO.	
03	1	GUY STRAIN INSUL	PORCELAIN PRODUCTS CO.	504	
04	4	GUY GRIP DEADEND	PREFORMED	CDE-3106	
07	2	THIMBLE, 3/8" XHD, OPEN	CROSBY	G414	
08	VARIES	GUY STRAND	COPPERWELD	8M	
10	1	HI-LITE DOUBLE CURVE HANGER	WABCO	54962-3001	
1 1	3	7/8 TRANSLITE STRAIN INSUL CL-CL	WABCO	54975-6120	
17	2	THIMBLE, 1/2" XHD, OPEN	CROSBY	G414	
41	1	H.S. FEEDER CLAMP ASSY, BRONZE	WABCO	19879-2000	
42	2	FEEDER CLAMP, BRONZE	WABCO	21088-2000	
49	1	COMPRESSION CONNECTOR COPPER-LONG		VHCL-	
		BARREL-TIN PLATED-FLARED	SQUARE D	2/0-12BNF	
50	1	COMPRESSION CONNECTOR COPPER-LONG	ANDERSON/	VHCL-	
		BARREL-TIN PLATED-FLARED	SQUARE D	500-12BNF	
51	AS REQD	MULTI-LOK TIES (18") NYLON COATED	BAND-IT	AE714	
52	2 12"	TUF NEOPRENE AIR HOSE SLEEVE	MCMASTER-	3 BRAID	
	PIECES	1.5" ID X 2.0625" DD (BLACK)	CARR		
55	VARIES	PHILLYSTRAN (3/8")	PHILLYSTRAN	HPTG 6700I	
			INC.		
56	2	PHILLYSTRAN BIG GRIP	PHILLYSTRAN INC.	PLP 2755	
57	VARIES	FIBERGLASS REINFORCED PLASTIC	MORRISON	EXTREN	
		(FRP) TUBE 3 1/2" Ø X 1/2"	MOLDED FG	SERIES 525	
60	AS REQD	FEED SPAN CABLE			
65	1	LAG SCREW, FETTER DRIVE, 1/2"X 4"	JOSLYN	J8754	
94	2	5/8" DVAL EYEBOLT W/ NUT	JOSLYN	J94XX	
96	2	SQ CURVED WASHER 3" X 3" X 1/4", 11/16" DIA	JOSLYN	J113	
97	1	3/4" MACHINE BOLT	JUSLYN	J89XX	
99	1	SQ CURVED WASHER 3" X 3" X 1/4",	JOSLYN	J6823	
		13/16″ DIA			
108	1	MAST ARM POLE END CAP	METRO STD	SA-108	
110	1	MAST ARM UNDERSLING END CAP	METRO STD	SA-110	
111	1	WOOD POLE MOUNTING BRACKET	METRO STD	SA-111	
116	VARIES	WIRE, 2 OR 5 KV, #4 AWG CU,			
<u> </u>		JACKETED, UNSHIELDED			


03 PM	110	1		MAST
12:39:	111	1		WOOD
V:\Library & Standards\Standards\Trolley\Detalls\SA-559.1-3.dwg, SA-559.3, 1/5/2007 12:39:03 PM	116	VARI	ES	WIRE,
3, 1/5				JACKE
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Jwg, S				
9.1-3.0				
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WOOD POLE TANGENT FEEDER BRACKET ASSEMBLY

DATE:
OCT 95
FILE
DWG. NO.
SA-559
SHT 3 OF 3



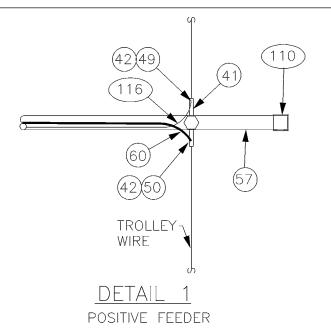

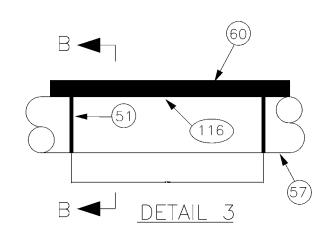
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3	DPG	DOW	
í	DR:	SCALE:	
	TMB	NONE	
5	RECOM.	CONTRACT:	
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SPECIALWORK PULLOFF

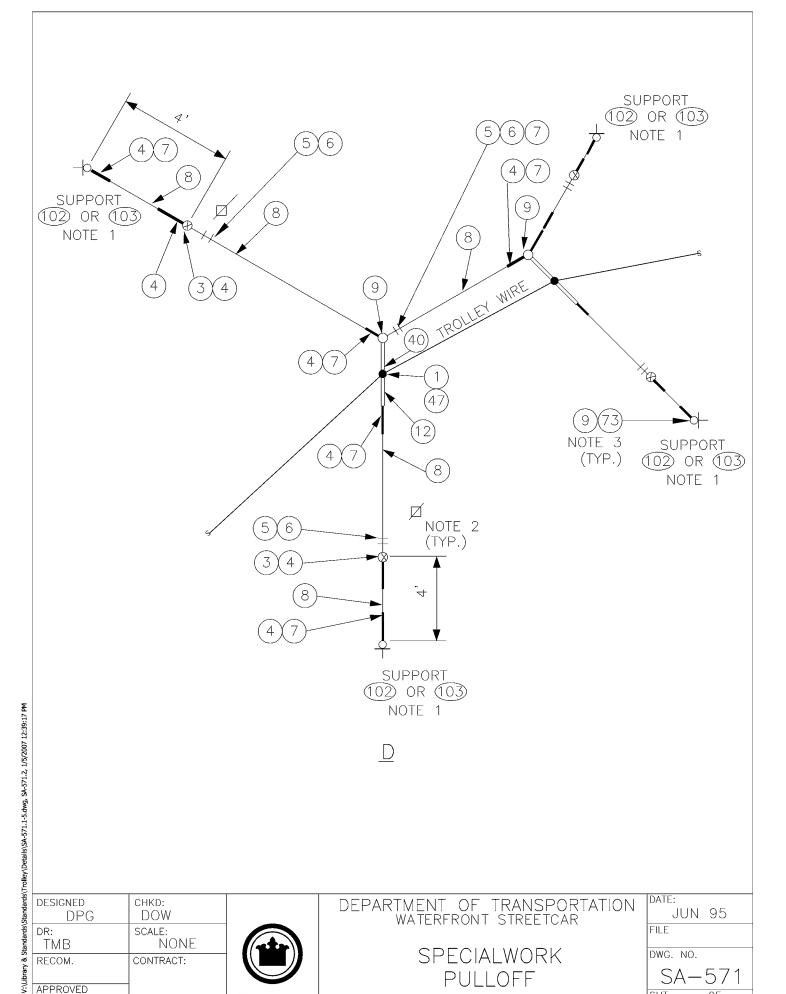DATE	:		
	JUN	95	
FILE			
DWG.	NO.		
S	A-	57	1
SHT	2	OF	5



E

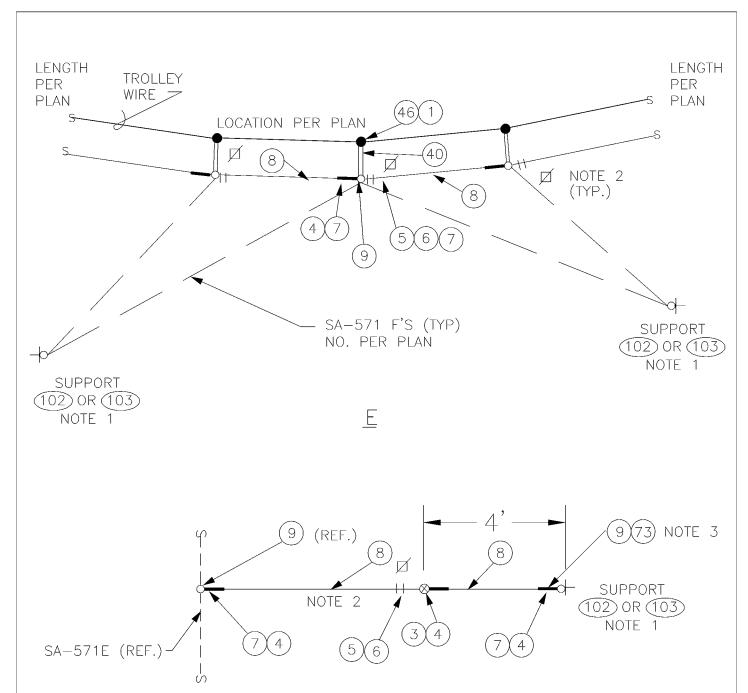	DESIGNED	CHKD:	
1	DPG	DOW	
,	DR:	SCALE:	
	TMB	NONE	
5	RECOM.	CONTRACT:	
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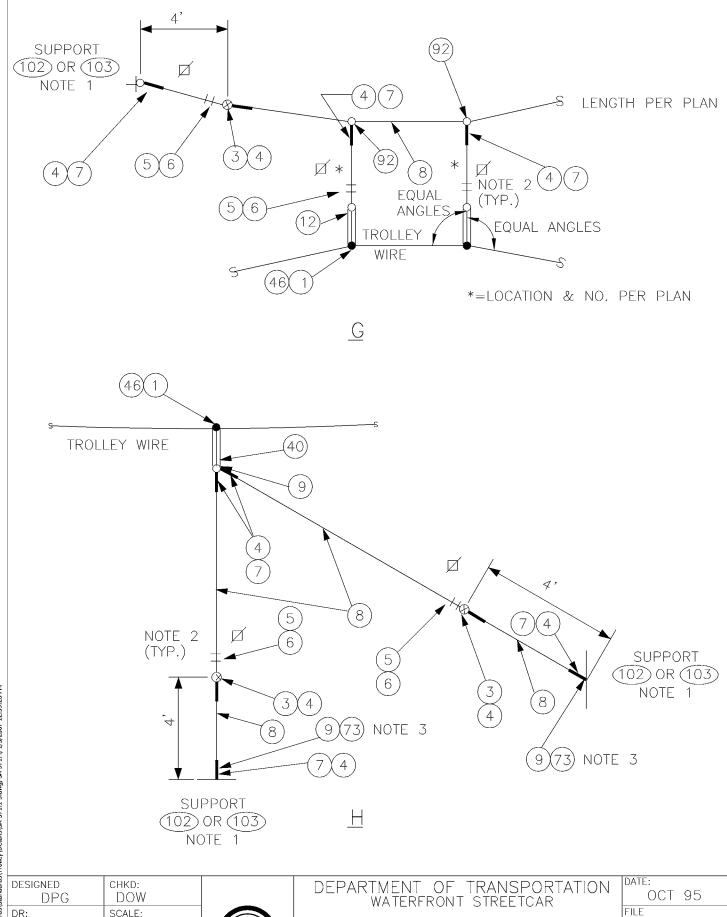


DEPARTMENT OF TRANSPORTATION WATERFRONT STREETCAR

SPECIALWORK PULLOFFS

DATE:
JUN 95
FILE
DWG. NO.
SA - 571

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SHT & 3 & OF & 5
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SPECIALWORK

PULLOFF

DWG. NO.

OF

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DR:

TMB

RECOM.

APPROVED

SCALE:

CONTRACT:

NONE

King County

NOTES:

- 1. A POLE COLLAR OR POLE EYEBOLT IS REQUIRED PER SA-102 OR SA-103 UNLESS A BUILDING EYEBOLT ATTACHMENT IS USED. INSTALLATION HEIGHT TO BE INDICATED AS REQUIRED ON THE OVERHEAD DRAWINGS.
- 3. ITEMS 9 & 73 REQUIRED WHEN MORE THAN TWO PULLOFFS AND/OR SPANS ATTACH TO SAME SUPPORT.
- 4. ITEM 73 REQUIRED WITH ITEM 12 IF SUPPORT IS AN EYEBOLT.

	MATERIAL LIST					
ITEM #	4 QT	Υ	DESCRIPTION MANUFACTURER		CAT. NO.	
06	AS F	REQD	FRICTION TAPE, 3/4" (6 WRAPS)			
09	*		BULL RING	WABCO	18567-2000	
12	*		7/8 TRANSLITE STRAIN INSUL CL-EYE	WABCO	55339-6120	
40	*		7/8 TRANSLITE STRAIN INSUL CL-90	WABCO	54995-6120	
GUY	TENSIC	DNS	0-3000 LBS			
01	*		DETROIT CLAMP ASSY	WABCO	19293-3007	
03	03 * GUY STRAIN INSUL PORCELAIN		PORCELAIN	504		
			PRODUCTS CO.			
04	O4 * GUY GRIP DEADEND		PREFORMED	CDE-3106		
05	·		CROSBY	G450		
07	07 * THIMBLE, 3/8" XHD, OPEN		CROSBY	G414		
07 08 46 47 73 92	08 VARIES GUY STRAND		COPPERWELD	8M		
46	* SINGLE CURVE HANGER TYPE A-2		WABCO	14072-2000		
47	7 * DOUBLE CURVE HANGER TYPE A-2		WABCO	14073-2000		
73	3 * ANCHOR SHACKLE		JOSLYN	J2742		
92	92 * ANGLE CLAMP		ANDERSON/	82860-2000		
			SQUARE D			
102 VARIES		ES	FORGED THREE-PIECE ADJUSTABLE	KORTICK		
			POLE BAND, ANNEALED & GALVANIZED	MFG CO		
103	103 VARIES WOOD POLE EYEBOLT METRO STD		METRO STD	SA-103		
DESIGNED CHKD: DEPARTMENT OF TRANSPORTATION DATE:			DATE:			

DESIGNED CHKD:
DPG DOW

DR: SCALE:
TMB NONE

RECOM. CONTRACT:

King County

DEPARTMENT OF TRANSPORTATION WATERFRONT STREETCAR

SPECIALWORK PULLOFF


OCT 95
FILE

DWG. NO.

SA - 571

SHT 5 0F 5

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DR:

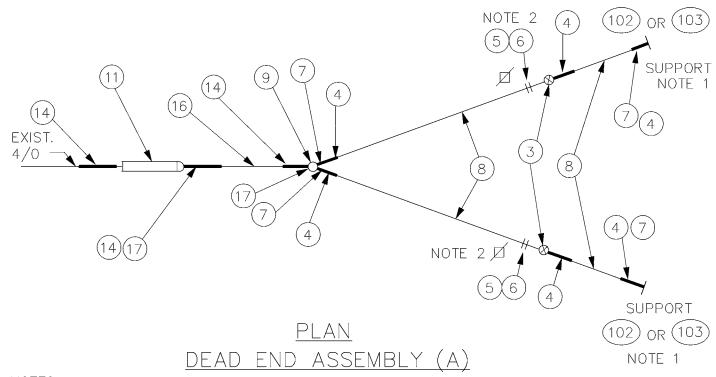TMB

RECOM.

APPROVED

SCALE:

CONTRACT:

NONE

King County

- 1. A POLE COLLAR OR POLE EYEBOLT IS REQUIRED PER SA-102 OR SA-103 UNLESS A BUILDING EYEBOLT ATTACHMENT IS USED. INSTALLATION HEIGHT IS INDICATED ON THE OVERHEAD DRAWINGS.
- 2. PROVIDE TENSION ADJUSTMENT POINTS AT LOCATIONS INDICATED BY "♥". SEE SA-166.


	MATERIAL LIST					
ITEM	#	ΥTΩ	DESCRIPTION	MANUFACTURER	CAT. NO.	
03	2		GUY STRAIN INSUL	PORCELAIN PRODUCTS CO.	504	
04	6		GUY GRIP DEADEND	PREFORMED	CDE-3106	
05	4		WIRE ROPE CLIP, 5/16"	CROSBY	G450	
06	AS	REQD	FRICTION TAPE, 3/4" (6 WRAPS)			
07	4		THIMBLE, 3/8" XHD, OPEN	CROSBY	G414	
08	VARIES GU		GUY STRAND	COPPERWELD	8M	
09	1		BULL RING	WABCD	18567-2000	
1 1	1		7/8 TRANSLITE STRAIN INSUL CL-CL	WABCD	54975-6120	
1 4	3		GUY GRIP DEADEND	PREFORMED	CDE-3115	
16	VA	RIES	GUY STRAND	COPPERWELD	16M	
17	2	2 THIMBLE, 1/2" XHD, OPEN		CROSBY	G414	
102	VA	RIES	FORGED THREE-PIECE ADJUSTABLE	KORTICK		
			POLE BAND, ANNEALED & GALVANIZED	MFG CO		
103	03 VARIES WOOD POLE EYEBOLT		METRO STD	SA-103		
DESIGNED CHKD: DPG DOW					N DATE: OCT 95	

DEAD END

ASSEMBLY

FILE

DWG. NO.

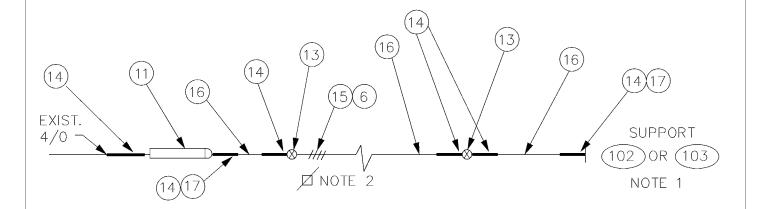

PLAN DEAD END ASSEMBLY (B)

NOTES


- 1. A POLE COLLAR OR POLE EYEBOLT IS REQUIRED PER SA-102 OR SA-103 UNLESS A BUILDING EYEBOLT ATTACHMENT IS USED. INSTALLATION HEIGHT IS INDICATED ON THE OVERHEAD DRAWINGS.
- 2. PROVIDE TENSION ADJUSTMENT POINTS AT LOCATIONS INDICATED BY "□". SEE SA-166.


	MATERIAL LIST								
	TEM #	QTY			DESCRIPTION		MANUFACTURER	CAT. NO.	
ľ	06	AS RE	QD	FRICT	ION TAPE,	3/4" (6 WRAPS)			
	1 1	1		7/8 T	RANSLITE S	TRAIN INSUL CL-CL	WABCD	54975-6120	
	13	2		GUY S	TRAIN INSU	IL.	PORCELAIN	506	
						PRODUCTS CO.			
	14	6 GUY GRIP DEADEND		PREFORMED	CDE-3115				
5	15	4 WIRE ROPE CLIP, 3/8"		CROSBY	G450				
9	16	6 VARIES GUY		GUY S	TRAND		COPPERWELD	16M	
1	17	2	2 THIME		LE, 1/2″ X	HD, OPEN	CROSBY	G414	
2	102	VARIE	VARIES FORGE		D THREE-PI	ECE ADJUSTABLE	KORTICK		
		POLE BAND, ANNEALED & GALVANIZED		MFG CO					
	103	VARIE	S	WOOD POLE EYEBOLT		METRO STD	SA-103		
			DEPARTMENT OF T		N DATE: OCT 95				

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King County

DEAD END **ASSEMBLY** FILE DWG. NO.



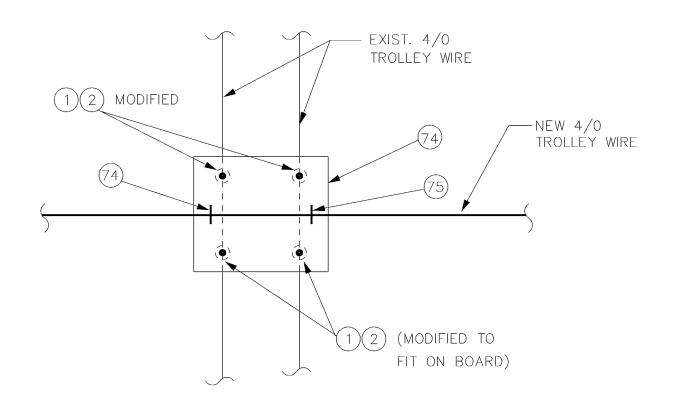

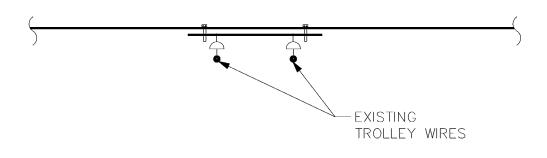	MATERIAL LIST						
1007/2/2	ITEM #	QTY	DESCRIPTION	MANUFACTURER	CAT. NO.		
	01	4	DETROIT CLAMP ASSY	WABCO	19293-3007		
ĥ	02	4	AGC TANGENT SPAN HANGER	WABCO	19360-2000		
	74	1	4 X 4 X 1/2" EXTERIOR PLYWOOD				
	75	4	U BOLT, FOR 4/0 TROLLEY WIRE				

33 PM						
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\;\ \	APPROVED					



TEMPORARY INSULATION BOARD

DATE:
JUN 95
FILE
DWG. NO.
SA-590
SHT 1 OF 1